

CONTRACT DRAWINGS


BEDFORD COUNTY PUBLIC SERVICE AUTHORITY

HIGH POINT WATER TREATMENT PLANT EXPANSION

PROJECT NO. 2003 - 028

BEDFORD COUNTY, VIRGINIA

2004

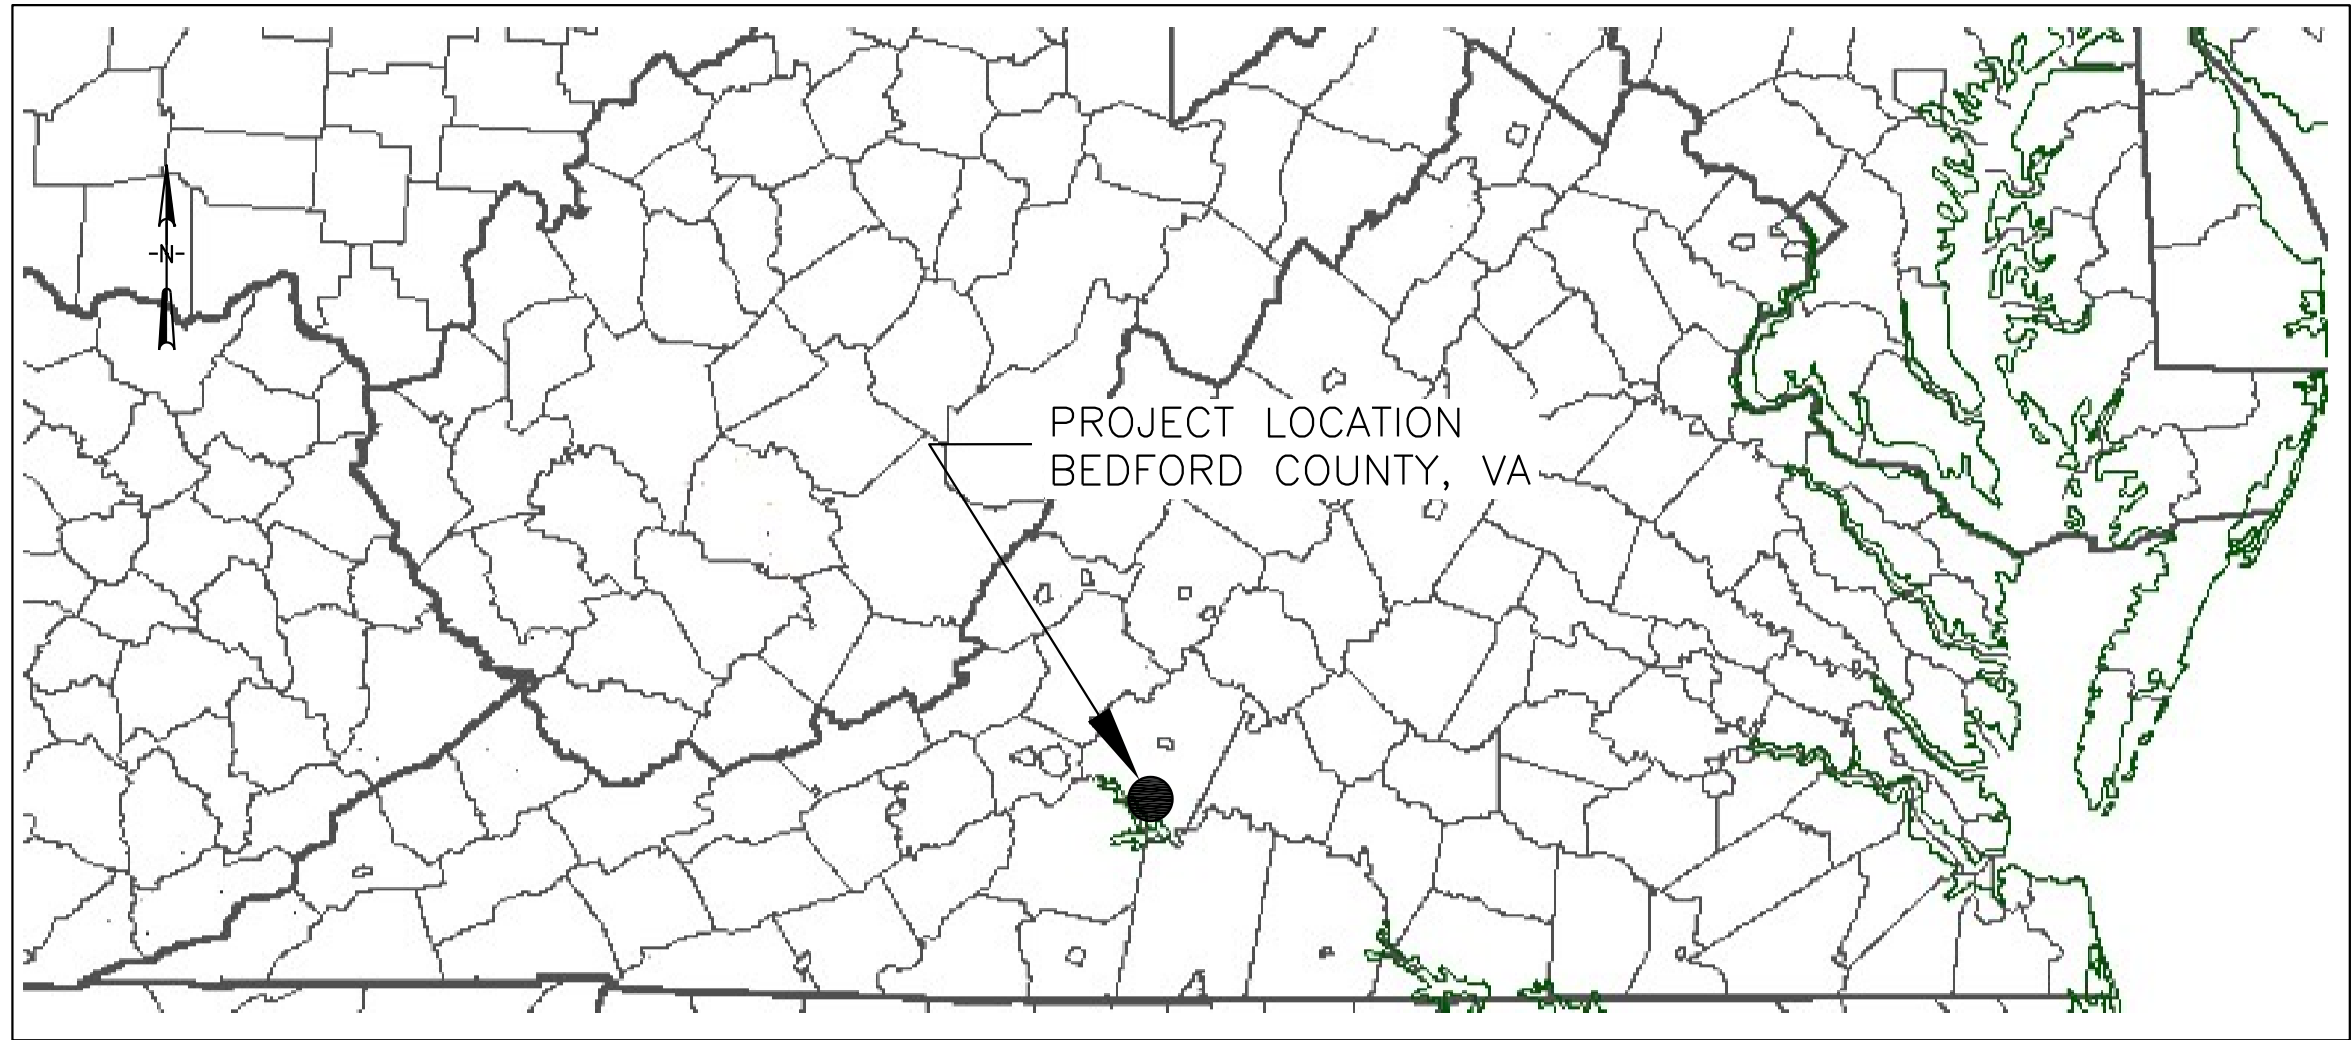

LOCATION MAP

NOT TO SCALE



BEDFORD COUNTY PUBLIC SERVICE AUTHORITY


1723 FALLING CREEK ROAD

BEDFORD, VA 24523

PHONE: (540) 586-7679

BRIAN M. KEY, P.E., DIRECTOR OF DESIGN & FACILITY SERVICES


LIST OF CONTRACT DRAWINGS		
SHEET NO.	DWG. NO.	TITLE
2	G-2	SITE LOCATION, ABBREVIATIONS, SYMBOLS NOTES & LEGENDS
3	G-3	EROSION & SEDIMENT CONTROL NOTES LEGEND & DETAILS
4	D-1	SITE DEMOLITION PLAN
5	D-2	RAW WATER PUMP STATION DEMOLITION PLAN
6	C-1	RAW WATER PUMP STATION ELECTRICAL BUILDING SITE PLAN & DETAILS
7	C-2	YARD PIPING & SITE PLAN
8	C-3	GRADING PLAN & SITE LAYOUT
9	C-4	YARD PIPING, STORM DRAIN DETAILS & CALCULATIONS
10	C-5	YARD PIPING CROSS SECTIONS & MISCELLANEOUS DETAILS
11	A-1	PLANS & ELEVATIONS
12	A-2	WALL SECTIONS
13	A-3	DETAILS & SCHEDULES
14	A-4	HEAD, SILL & JAMB DETAILS
15	A-5	RAW WATER PUMP STATION ELECTRICAL BUILDING PLANS, ELEVATIONS & DETAILS
16	S-1	FOUNDATION & ROOF FRAMING PLANS
17	S-2	SECTIONS & DETAILS
18	S-3	STANDARD STRUCTURAL DETAILS
19	M-1	RAW WATER PUMP STATION MECHANICAL
20	M-2	RAW WATER FLOWMETER & STRAINER MECHANICAL LAYOUT, SECTIONS, DETAILS, & FILTERED WATER FLOWMETER LAYOUT
21	M-3	MECHANICAL FLOOR PLAN & CROSS SECTION
22	M-4	MECHANICAL SECTIONS & DETAILS
23	M-5	MECHANICAL SECTIONS & DETAILS
24	M-6	EFM TANK SECTIONS & DETAILS
25	M-7	CHEMICAL FEED SYSTEM & BACKWASH RECOVERY TANKS SECTIONS & DETAILS
26	M-8	MISCELLANEOUS MECHANICAL DETAILS
27	M-9	CHEMICAL FEED SYSTEM, INSTRUMENTATION & SAMPLING DETAILS
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29	P-1	PLUMBING PLAN
30	P-2	CARRIER PIPE PLUMBING PLAN & DETAILS
31	E-1	ELECTRICAL LEGEND, ABBREVIATIONS, & SYMBOLS
32	E-2	RAW WATER PUMP STATION PLANS, SCHEDULES & DIAGRAMS
33	E-3	ONE LINE DIAGRAMS & ELECTRICAL DETAILS
34	E-4	POWER, CONTROL & LIGHTING PLANS
35	E-5	CONDUIT RISER DIAGRAM
36	E-6	ELECTRICAL SCHEDULES
37	I-1	PROCESS & INSTRUMENTATION DIAGRAM

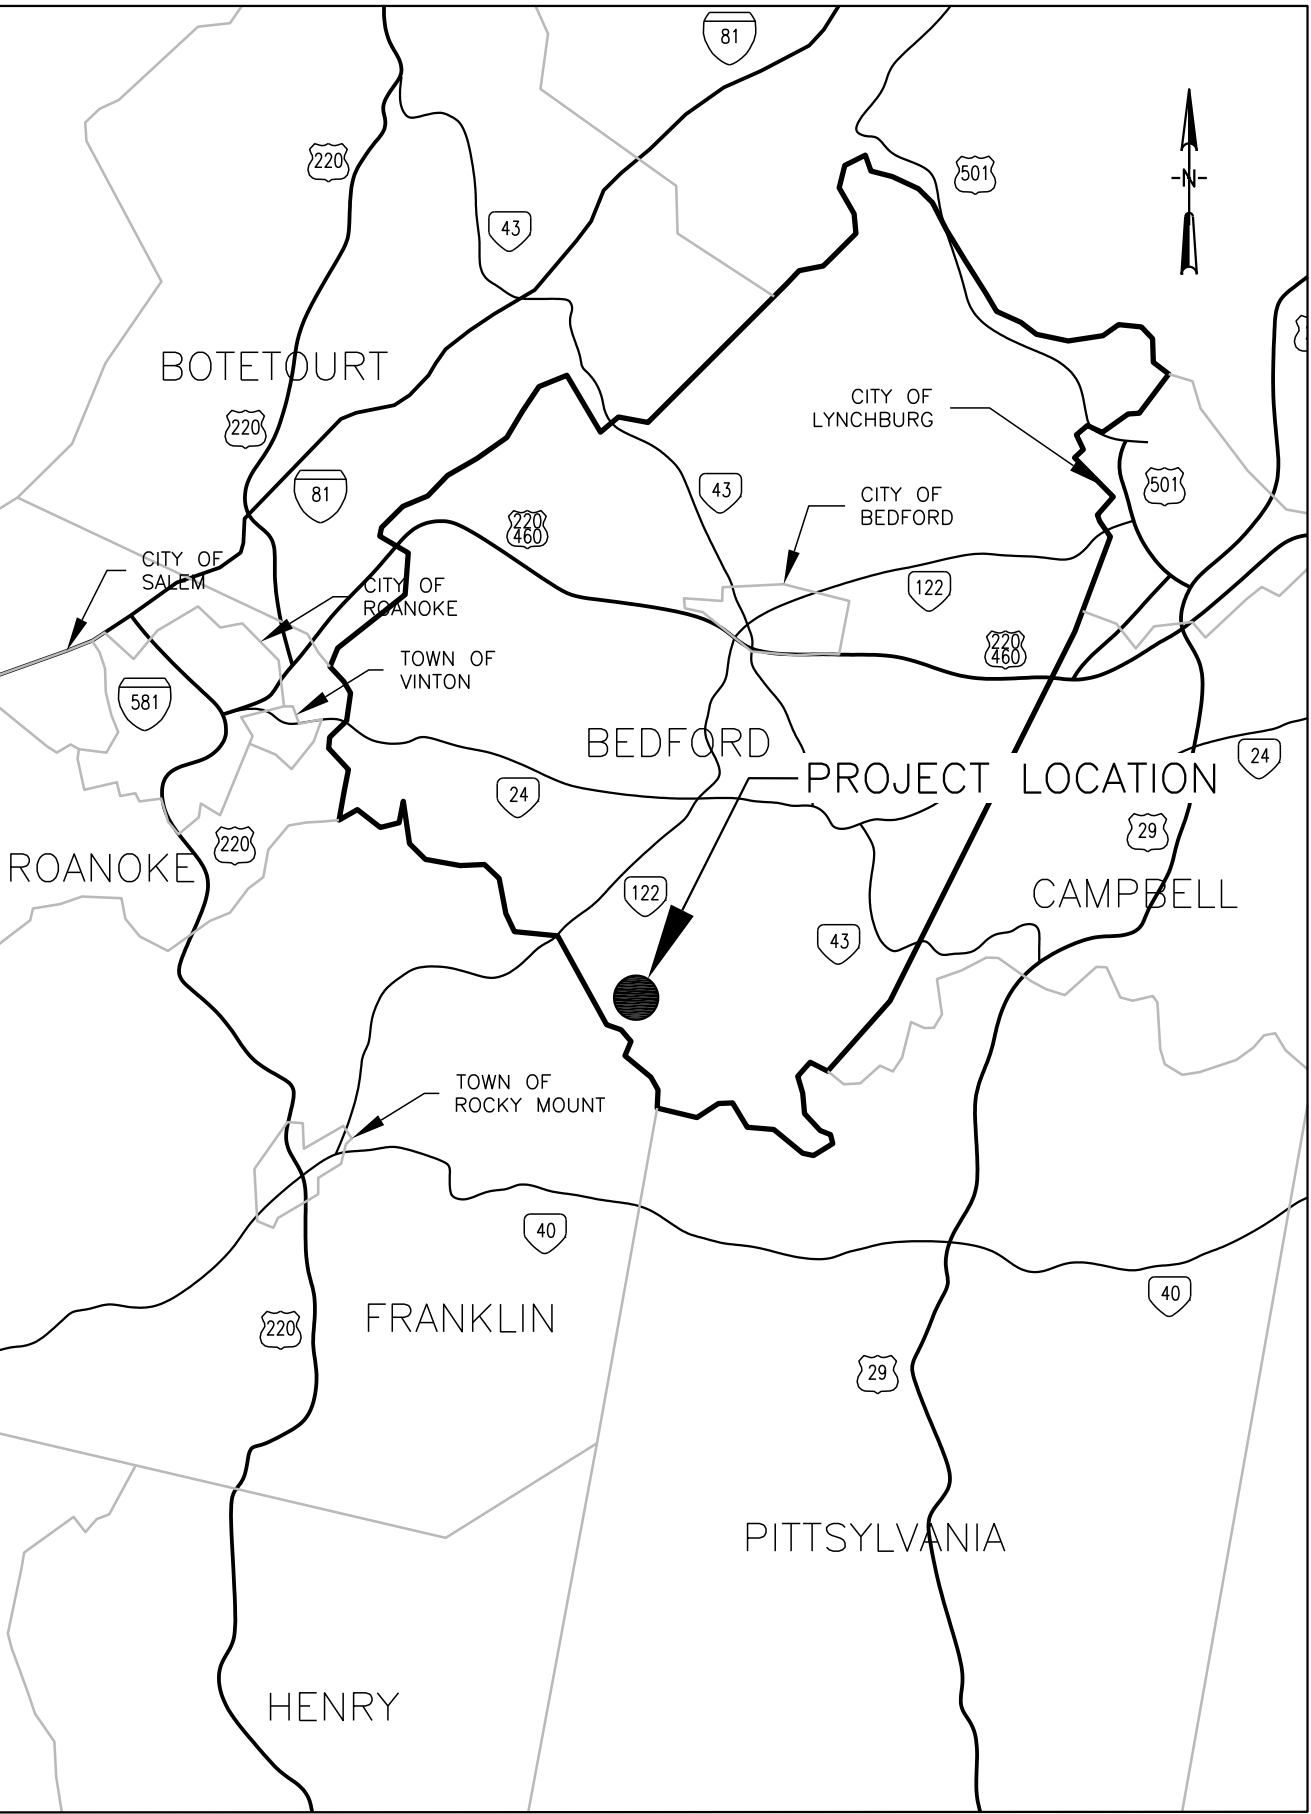

SOURCE: VDOT: OFFICIAL STATE TRANSPORTATION MAP

VICINITY MAP

NOT TO SCALE

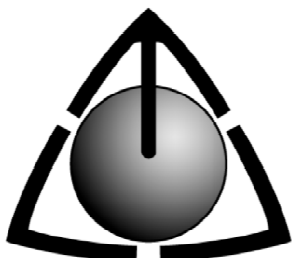

Stearns & Wheler, LLC

Environmental Engineers and Scientists

310 FIRST STREET S.W., SUITE 150

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REVISION 1: 6/18/04 VDH COMMENTS



LEGEND

ITEM	APPEARANCE
EXISTING 5' CONTOUR	---855---
EXISTING 1' CONTOUR	---853---
EXISTING WATERLINE	---CW---CW---
EXISTING DRAINAGE LINE	---D---D---
EXISTING SANITARY SEWER AND LATERALS	---EX. SS---
EXISTING FORCE MAIN	---EX. FM---
EXISTING GAS LINE	---EX. GAS---
EXISTING TV CABLE	---EX. TV---
EXISTING UNDERGROUND TELEPHONE/ELECTRIC	---UT---
EXISTING UNDERGROUND FIBER OPTIC CABLE	---UFO---
EXISTING UNDERGROUND ELECTRIC	---UE---
EXISTING OVERHEAD TELEPHONE/ELECTRIC	---OHE---
EXISTING PROPERTY LINE	---X---X---X---X---
EXISTING FENCE OR GUARD RAIL	
EXISTING EDGE OF PAVEMENT	
PROPOSED 5' CONTOURS	---855---
PROPOSED 1' CONTOURS	---853---
PROPOSED WATER MAIN	
PROPOSED WATER SERVICE	
APPROXIMATE STREET RIGHT-OF-WAY	
TEMPORARY EASEMENT	---T.E.---
PERMANENT EASEMENT	---P.E.---
EXISTING FIRE HYDRANT	
EXISTING WATER VALVE	
EXISTING POLE WITH GUY	
EXISTING WOODS AND/OR BRUSH	
EXISTING HEMLOCK TREE	
EXISTING FUR TREE	
EXISTING WHITE PINE TREE	
EXISTING HOUSE OR BUILDING	
PROPOSED WATER VALVE	
PROPOSED 11-1/4" BEND	
PROPOSED 22-1/2" BEND	
PROPOSED 45" BEND	
PROPOSED 90" BEND	
PROPOSED TEE	
PROPOSED WYE	
PROPOSED REDUCER	
EXISTING BASELINE CONTROL POINT	
SHEET NO.	
PROPOSED	---
EXISTING	---
STORM SEWER STRUCTURES & FITTINGS	
CLEAN OUT	
PROPOSED CONTROL POINTS	
PROPOSED CONTROL POINTS	---GAS---GAS---
PROPOSED STORM DRAIN PIPING	---SD---SD---
PROPOSED FENCE	---□---□---□---

ABBREVIATIONS

ADDL	ADDITIONAL
ARV	AIR RELEASE VALVE
ALUM	ALUMINUM
AC	ASBESTOS CEMENT
BSMT	BASEMENT
BM	BENCHMARK OR BEAM
BIT	BITUMINOUS
BOV	BLOW-OFF VALVE
BLDG	BUILDING
CIP	CAST IRON PIPE
CB	CATCH BASIN
CL	CENTERLINE
C.V.	CHECK VALVE
CLR	CLEAR
CAVV	COMBINED AIR RELEASE & VACUUM VALVE
CONC.	CONCRETE
CMU	CONCRETE MASONRY UNIT
CONT	CONTINUOUS
CMP	CORRUGATED METAL PIPE
CSK	COUNTERSUNK
DIP	DUCTILE IRON PIPE
DWG	DRAWING
EA	EACH
EF	EACH FACE
EW	EACH WAY
EOP	EDGE OF PAVEMENT
EL/ELEV	ELEVATION
FRP	FIBERGLASS REINFORCED PLASTIC
FH	FIRE HYDRANT
FIN	FINISH
FF	FINISHED FLOOR
FL/FLR	FLOOR
FTG	FOOTING
FM	FORCE MAIN
FND	FOUNDATION
GALV	GALVANIZED PIPE
G	GAS MAIN
G.V.	GATE VALVE
GP	GUIDE POST
HK	HOOK
HORIZ	HORIZONTAL
HDPE	HIGH DENSITY POLYETHYLENE
INV	INVERT
FIP	IRON PIN
ISO	ISOLATION
JT	JOINT
LP	LAMP POLE
LLH	LONG LEG HORIZONTAL
LLV	LONG LEG VERTICAL
MH	MANHOLE
MAS	MASONRY
MCJ	MASONRY CONTROL JOINT
MAX	MAXIMUM
MIN	MINIMUM
MON	MONUMENT
NIC	NOT IN CONTRACT
OC	ON CENTER
OPNG	OPENING
O.F.	OUTSIDE FACE
%	PERCENT GRADE
P.E.	PERMANENT EASEMENT
PE	POLYETHYLENE
PVC	POLYVINYL CHLORIDE
PP	POWERPOLE
PL	PROPERTY LINE
RCP	REINFORCED CONCRETE PIPE
REINF	REINFORCING
REQ'D	REQUIRED
ROW	RIGHT-OF-WAY
SANMH	SANITARY MANHOLE
SANSWR	SANITARY SEWER
SS	STAINLESS STEEL
STD	STANDARD
ST	STEEL
STMH	STORM MANHOLE
STMSWR	STORM SEWER
T.E.	TEMPORARY EASEMENT
THK	THICK
T&B	TOP AND BOTTOM
T/	TOP OF
TYP	TYPICAL
UNO/UON	UNLESS OTHERWISE NOTED
WL	WATERLINE
WW	WOVEN WIRE
WWF	WELDED WIRE FABRIC

GENERAL NOTES:

1) THE CONTRACTOR SHALL COORDINATE (WITH THE BEDFORD COUNTY PUBLIC SERVICE AUTHORITY STAFF) ALL ACTIVITIES INTERFERING WITH, AFFECTING, AND/OR IMPACTING PLANT OPERATIONS PRIOR TO COMMENCING THESE ACTIVITIES. THE CONTRACTOR SHALL COORDINATE SCHEDULING, SUBMITTALS, AND WORK WITH THE BEDFORD COUNTY PUBLIC SERVICE AUTHORITY STAFF TO ENSURE EFFICIENT AND ORDINARY SEQUENCE OF INSTALLATION OF INTERDEPENDENT CONSTRUCTION ELEMENTS. THE CONTRACTOR SHALL SCHEDULE ALL CONSTRUCTION ACTIVITIES WITH THE BEDFORD COUNTY PUBLIC SERVICE AUTHORITY STAFF.

2) THE CONTRACTOR SHALL EXERCISE EXTREME CAUTION TO ELIMINATE THE POSSIBILITY OF ANY DISTURBANCE OR DAMAGE TO PUBLIC OR PRIVATELY OWNED UTILITIES, STRUCTURES, OTHER FACILITIES OR OBSTRUCTION RESULTING FROM HIS ACTIVITIES TO THIS END, CONTRACTOR SHALL, AT NO ADDITIONAL COST TO THE OWNER, TAKE ALL MEASURES NECESSARY TO PROVIDE, AND SHALL BE SOLELY RESPONSIBLE FOR, TEMPORARY SUPPORT AND SHORING, ADEQUATE PROTECTION, AND MAINTENANCE OR CONTINUOUS OPERATION OF ALL UNDER AND ABOVE GROUND UTILITY SERVICES. THE CONTRACTOR SHALL CALL MISS UTILITY AT 1-800-552-7001 48 HOURS PRIOR TO DIGGING. ALL UTILITY TIE-INS ARE TO BE COORDINATED WITH THE APPROPRIATE PUBLIC OR PRIVATE UTILITY AUTHORITY BEFORE COMMENCING WORK ON EXISTING UTILITIES. THE CONTRACTOR SHALL SUPPLY ALL UTILITY COMPANIES WITH APPROVED PLAN COPIES FOR COORDINATION OF EXTENSION AND TIE-IN EFFORTS.

3) SITE CONDITIONS MAY NECESSITATE SLIGHT DEVIATIONS IN ALIGNMENT, GRADE, AND/OR LOCATION OF NEW FACILITIES FROM THE PLAN ALIGNMENT. THE CONTRACTOR SHALL CONSTRUCT THE NEW FACILITIES TO SUCH DEVIATIONS AS DIRECTED BY THE ENGINEER WITHOUT ADDITIONAL COST OR FINE TO THE OWNER. SHOULD PLAN DEVIATIONS BE REQUIRED, THE CONTRACTOR SHALL NOTIFY THE ENGINEER PRIOR TO UNDERTAKING ANY REVISION.

4) ALL CONSTRUCTION SHALL BE IN CONFORMANCE WITH THE CURRENT INTERNATIONAL BUILDING CODE AND/OR STATE AND LOCAL BUILDING CODES AS WELL AS THE CONSTRUCTION STANDARDS AND SPECIFICATIONS OF THE VIRGINIA DEPARTMENT OF TRANSPORTATION, VIRGINIA DEPARTMENT OF HEALTH, AND VIRGINIA DEPARTMENT OF ENVIRONMENTAL QUALITY.

5) THE CONTRACTOR SHALL MAINTAIN THE CONSTRUCTION AREA IN A SAFE AND ACCEPTABLE MANNER AND SHALL BE RESPONSIBLE FOR REMEDIATING ANY DAMAGES RESULTING FROM HIS FAILURE TO DO SO.

6) THE CONTRACTOR SHALL MAINTAIN LIMITS OF CONSTRUCTION WITHIN THE PROPERTY BOUNDARIES OR EASEMENTS AS INDICATED.

7) AN APPROVED SET OF PLANS SHALL BE KEPT ON THE SITE AT ALL TIMES.

8) ALL CONSTRUCTION DEBRIS SHALL BE CONTAINERIZED IN CONFORMANCE WITH THE VIRGINIA LITTER CONTROL ACT AND DISPOSED OF IN A MANNER AND LOCATION ACCEPTABLE TO THE GOVERNING JURISDICTION. AT LEAST ONE TRASH RECEPTACLE SHALL BE ONSITE DURING CONSTRUCTION.

9) GRADE STAKES SHALL BE SET FOR ROADWAY, CURB & GUTTER, CULVERTS, SANITARY SEWER, AND STORM SEWER.

10) CONTRACTOR SHALL MAINTAIN DRIVEWAY ACCESS AND MAIL SERVICE AT ALL TIMES.

11) CONTRACTOR SHALL BE RESPONSIBLE FOR ANY DAMAGE OR DISTURBANCE OF INDIVIDUAL PROPERTY CORNER MONUMENTS CAUSED BY CONSTRUCTION ACTIVITIES AND SHALL HAVE THEM REPLACED BY A LAND SURVEYOR LICENSED IN VIRGINIA.

12) CONTRACTOR IS RESPONSIBLE FOR REMEDIATING ANY DAMAGE THAT OCCURS DURING CONSTRUCTION. CONTRACTOR SHALL BE RESPONSIBLE FOR THE SAFETY OF ANY LIVESTOCK, PETS AND/OR DOMESTICATED ANIMALS THAT ARE ENCOUNTERED AT THE PROJECT SITE.

13) FIELD SURVEY TO PROVIDE PLANIMETRIC, TOPOGRAPHIC MAPPING, TOPOGRAPHIC SITE MAPPING AND FIELD LOCATIONS AT THE WTP BUILDING & PROPERTY WAS PERFORMED BY LUMSDEN ASSOCIATES, P.C., ROANOKE, VIRGINIA IN JUNE 2003.


14) ALL EXISTING UNDERGROUND UTILITY LOCATIONS AS SHOWN ON THESE PLANS ARE APPROXIMATE AND DO NOT REPRESENT ALL UNDERGROUND UTILITIES OR SERVICE LINES. CONTRACTOR IS RESPONSIBLE FOR VERIFYING EXACT LOCATION, DEPTH, SIZE, AND TYPE OF UTILITIES SHOWN. PRIOR TO EXCAVATION, THE CONTRACTOR SHALL CONTACT THE PERTINENT UTILITY COMPANIES AND/OR UTILITY LOCATING SERVICES TO HAVE ALL UNDERGROUND UTILITIES LOCATED AND MARKED.

15) ALL PIPE, FITTINGS, AND APPURTENANCES SHALL BE RESTRAINED AND ANCHORED IN ACCORDANCE WITH BCPSA MASTER SPECIFICATIONS AND STANDARD DETAILS. THRUST RESTRAINTS ARE REQUIRED FOR ALL BENDS AND TEES. IF MECHANICAL JOINT RESTRAINT SYSTEMS ARE USED, INSTALLATION SHALL BE IN ACCORDANCE WITH MANUFACTURER'S REQUIREMENTS AND RECOMMENDATIONS RELATED TO NUMBER OF JOINTS RESTRAINED.


16) CULVERTS OR STORM DRAINS REMOVED OR DAMAGED DURING CONSTRUCTION SHALL BE REPLACED AT THE CONTRACTOR'S EXPENSE.

17) ALL DISTURBED AREAS SHALL BE RETURNED TO LIKE OR BETTER CONDITION WHETHER THEY ARE GRASSED, LANDSCAPED, GRAVELED OR OTHER. ANY DISTURBED PLANTINGS SHALL BE REPLACED BY LIKE SPECIES.

18) CONTRACTOR SHALL ADHERE TO THE LIMITS OF CONSTRUCTION AS SHOWN ON THESE PLANS. CONTRACTOR SHALL ACCESS OUTSIDE THE LIMITS OF CONSTRUCTION FOR THE CONSTRUCTION OF THE 8" CHAIN LINK FENCE AS SHOWN ON THESE PLANS. CONTRACTOR SHALL NOT IMPACT ANY ADJACENT PROPERTIES DURING FENCE CONSTRUCTION.

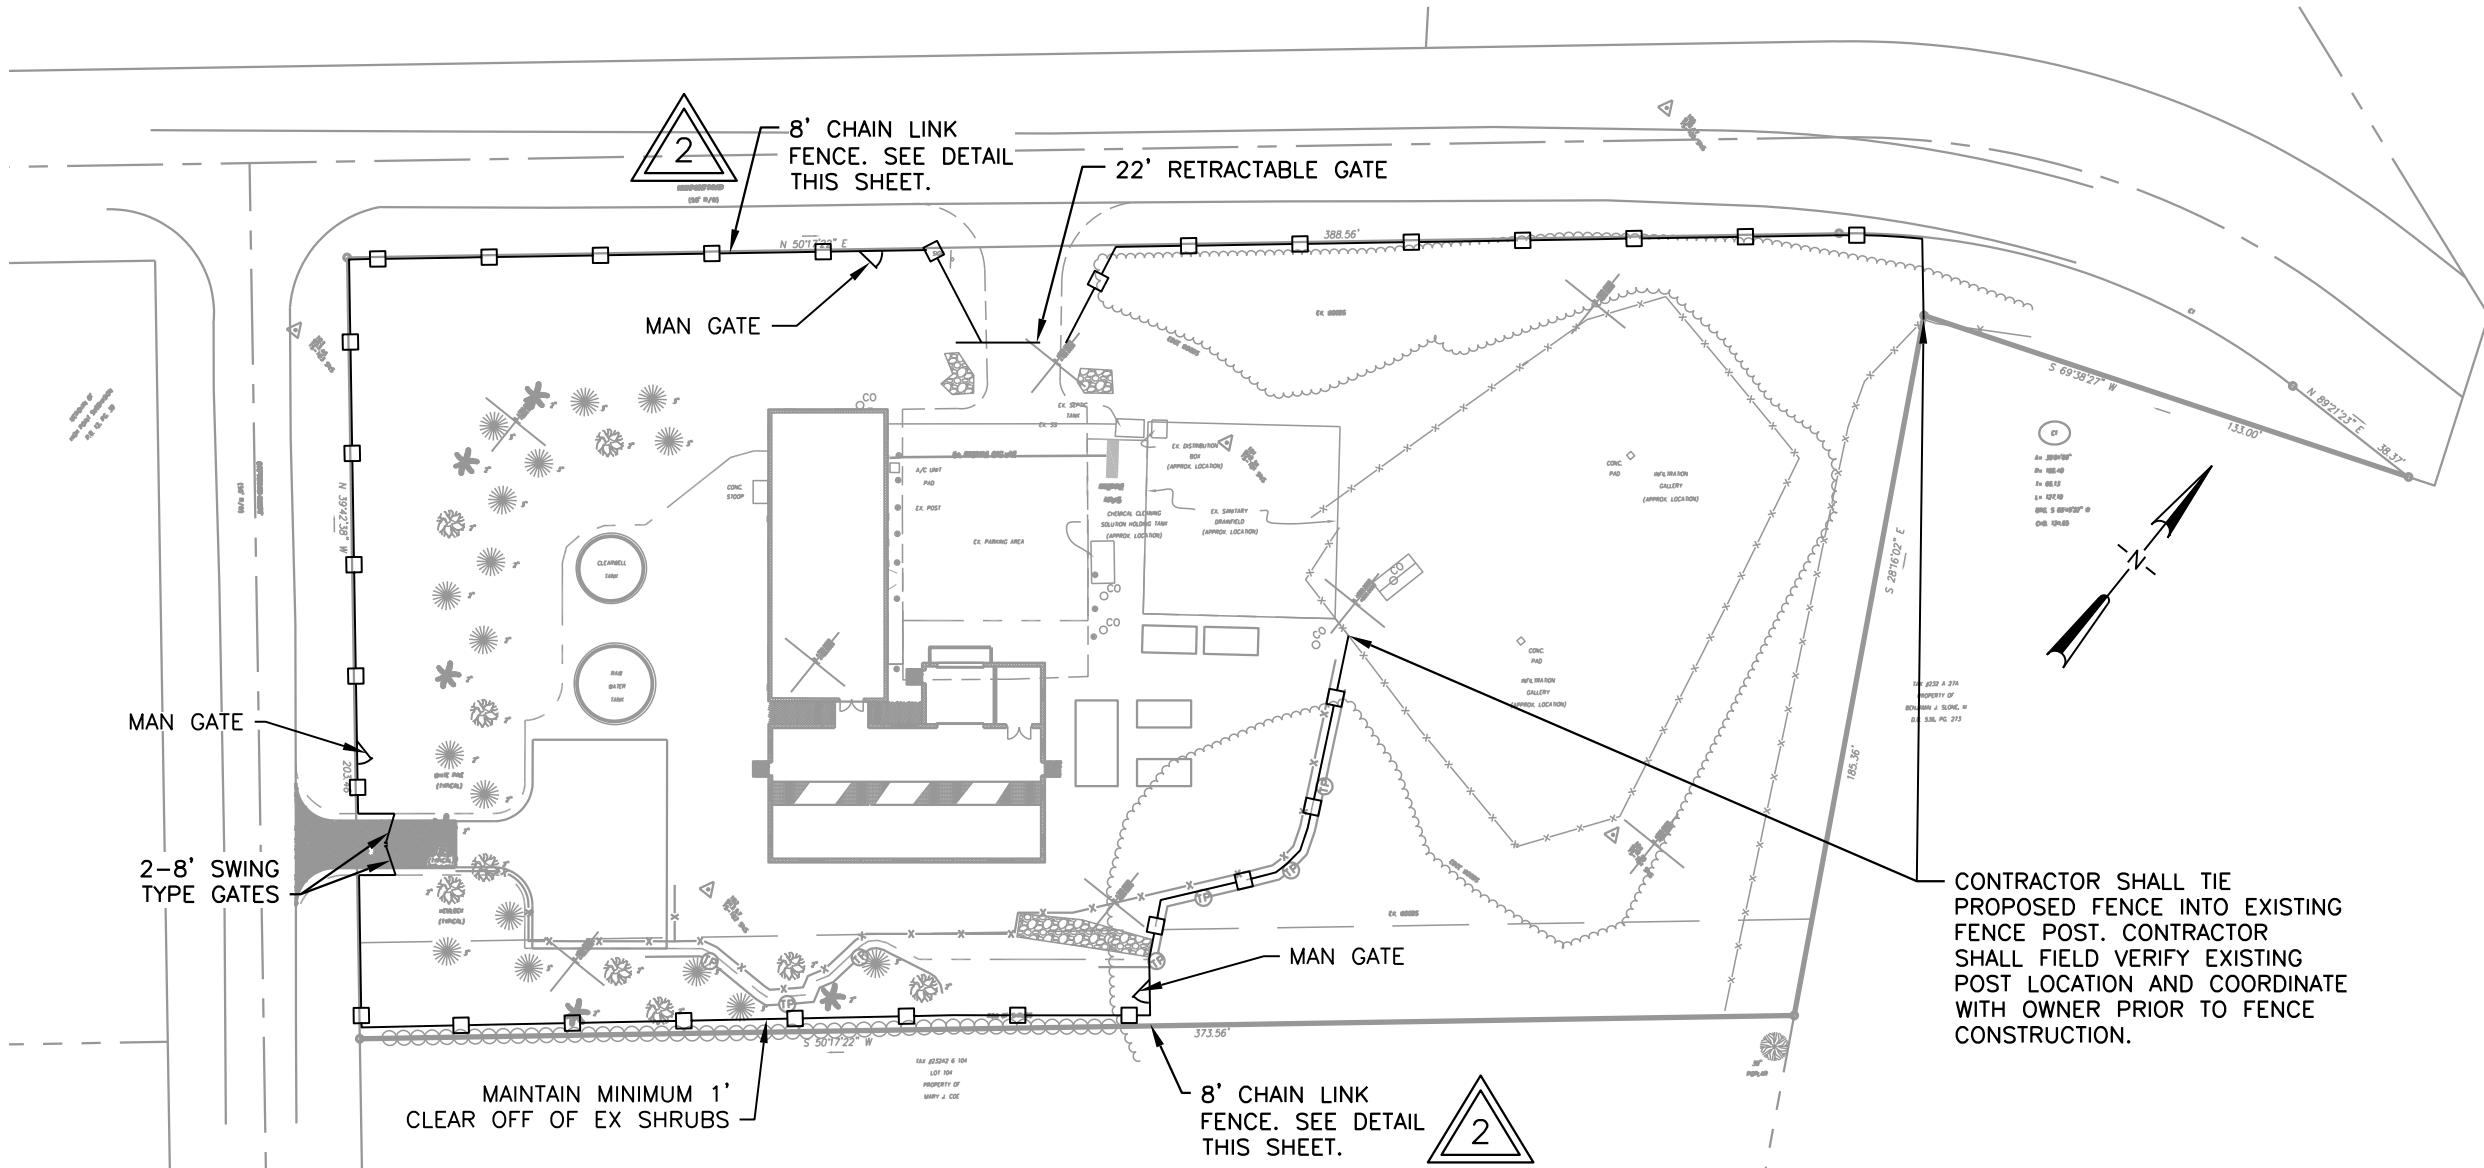


SITE LOCATION MAP
SCALE: 1"=50'

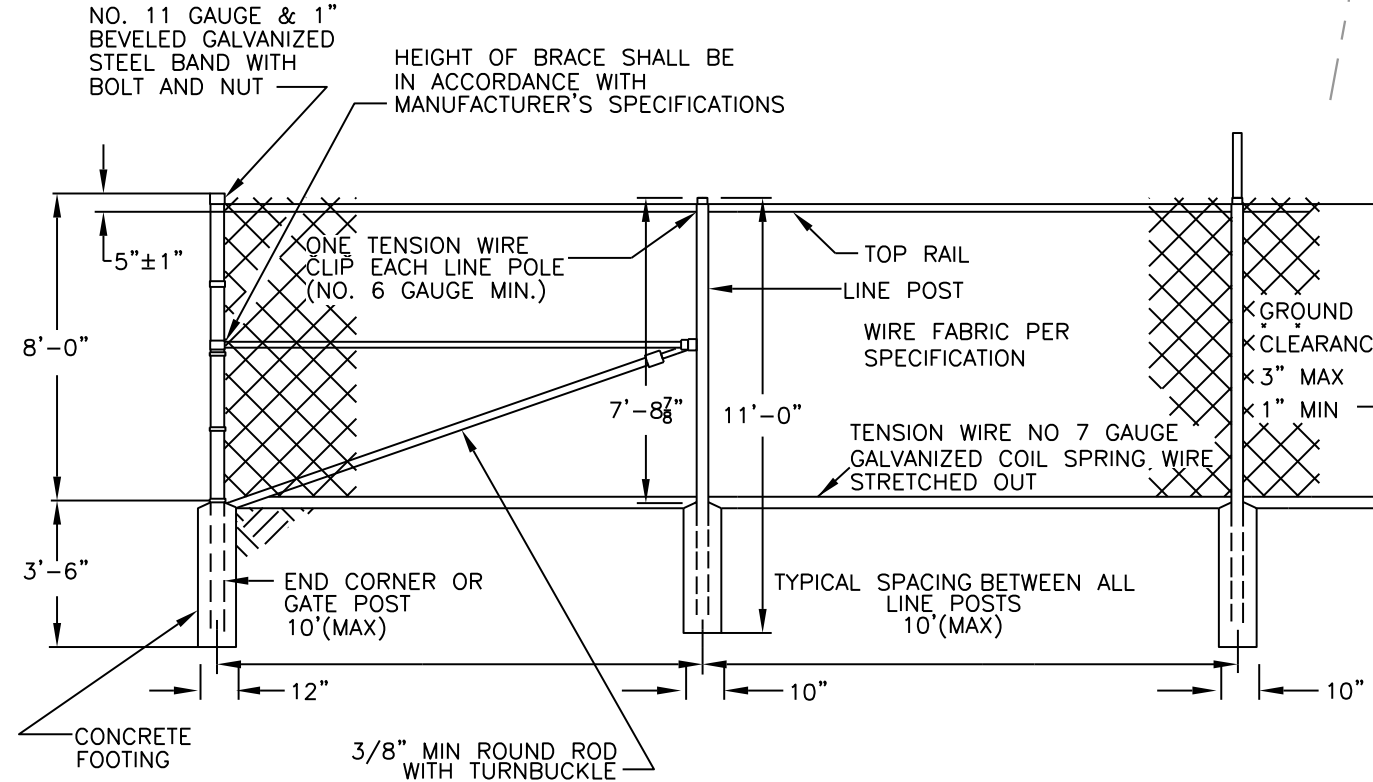

DOUBLE SWING GATE

MAN GATE

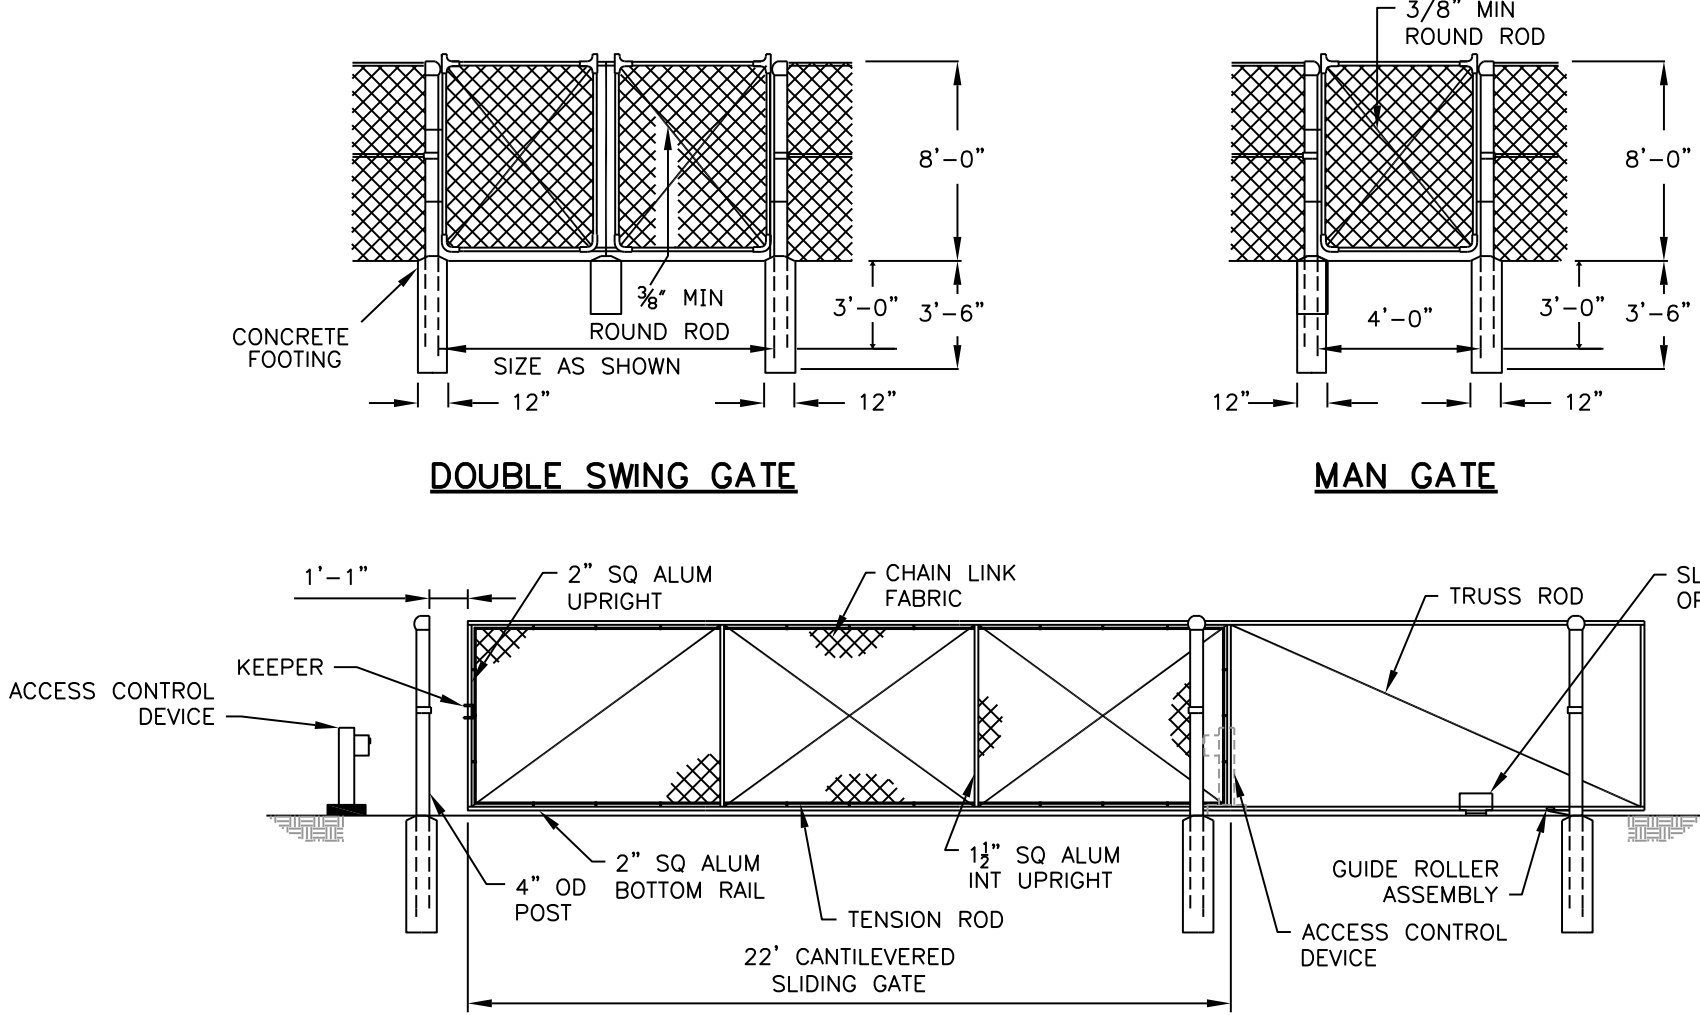

SINGLE CANTILEVERED RETRACTABLE GATE

LINE BRACE - SHALL BE USED WHEN VERTICAL ALIGNMENT CHANGES 15' (MAX SPACING 500')
- SHALL BE USED AT FENCE END (AS SHOWN ABOVE) AND GATE LOCATIONS

CORNER BRACE - SHALL BE USED WHEN HORIZONTAL ALIGNMENT CHANGES 15' OR MORE
- SHALL BE AS DETAILED ABOVE WITH BRACING IN BOTH DIRECTIONS


CHAIN LINK FENCE
INSTALLATION
NOT TO SCALE

4-REF: 20200201
6/03, ROANOKE, BSR
P:\2020\20_30\Drawings\Gen\

NOTES:

Underground facilities, structures, and utilities have been plotted from available surveys and records, and therefore their locations must be considered approximate only. There may be others, the existence of which is presently not known.

3	REVISED PER OWNER COMMENTS	BSR	7/04	WPJ	CMT	RRC	7/09/04												
2	REVISED PER OWNER & VDH COMMENTS	BSR	6/04	WPJ	CMT	RRC	6/21/04												
1	FOR APPROVAL	BSR	11/03	WPJ	CMT	RRC	1/23/04												
ISSUE NO.	DRAWN	DATE	CHECKED	DESIGNER	APPROVED	DATE	4	ISSUED FOR CONSTRUCTION											
PROJECT SUPERVISOR					DEPARTMENT SUPERVISOR														

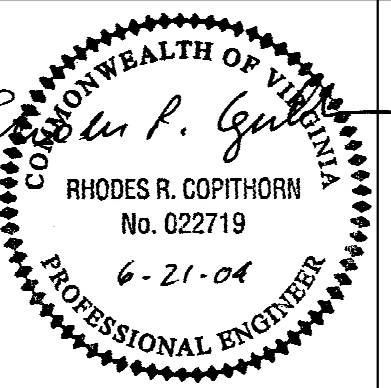

Stearns & Wheler, LLC
Environmental Engineers and Scientists


310 FIRST STREET, S.W., SUITE 150
ROANOKE, VIRGINIA 24011
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BEDFORD COUNTY PUBLIC SERVICE AUTHORITY

HIGH POINT WTP EXPANSION - PROJECT NO. 2003 - 028


SITE LOCATION, ABBREVIATIONS, SYMBOLS,
NOTES & LEGENDS

JOB NO. 20280 DRAWING G-2 SHEET 2 OF 37

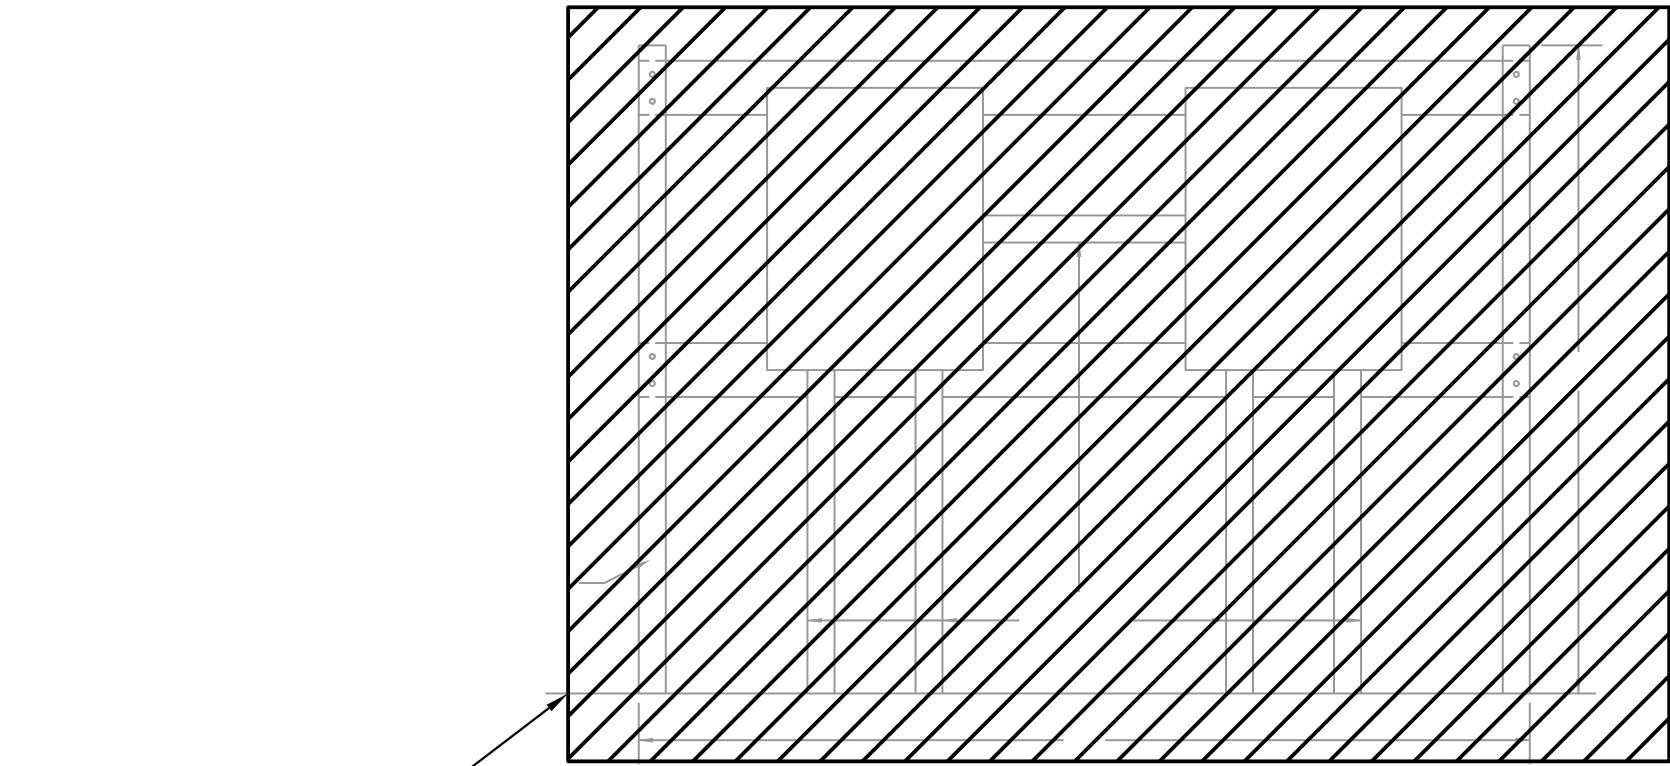

REMOVE EXISTING RAW WATER
ELECTRICAL PANELS AND FRAME

FRAME FOR ELECTRICAL SERVICE
RAW WATER PUMP STATION

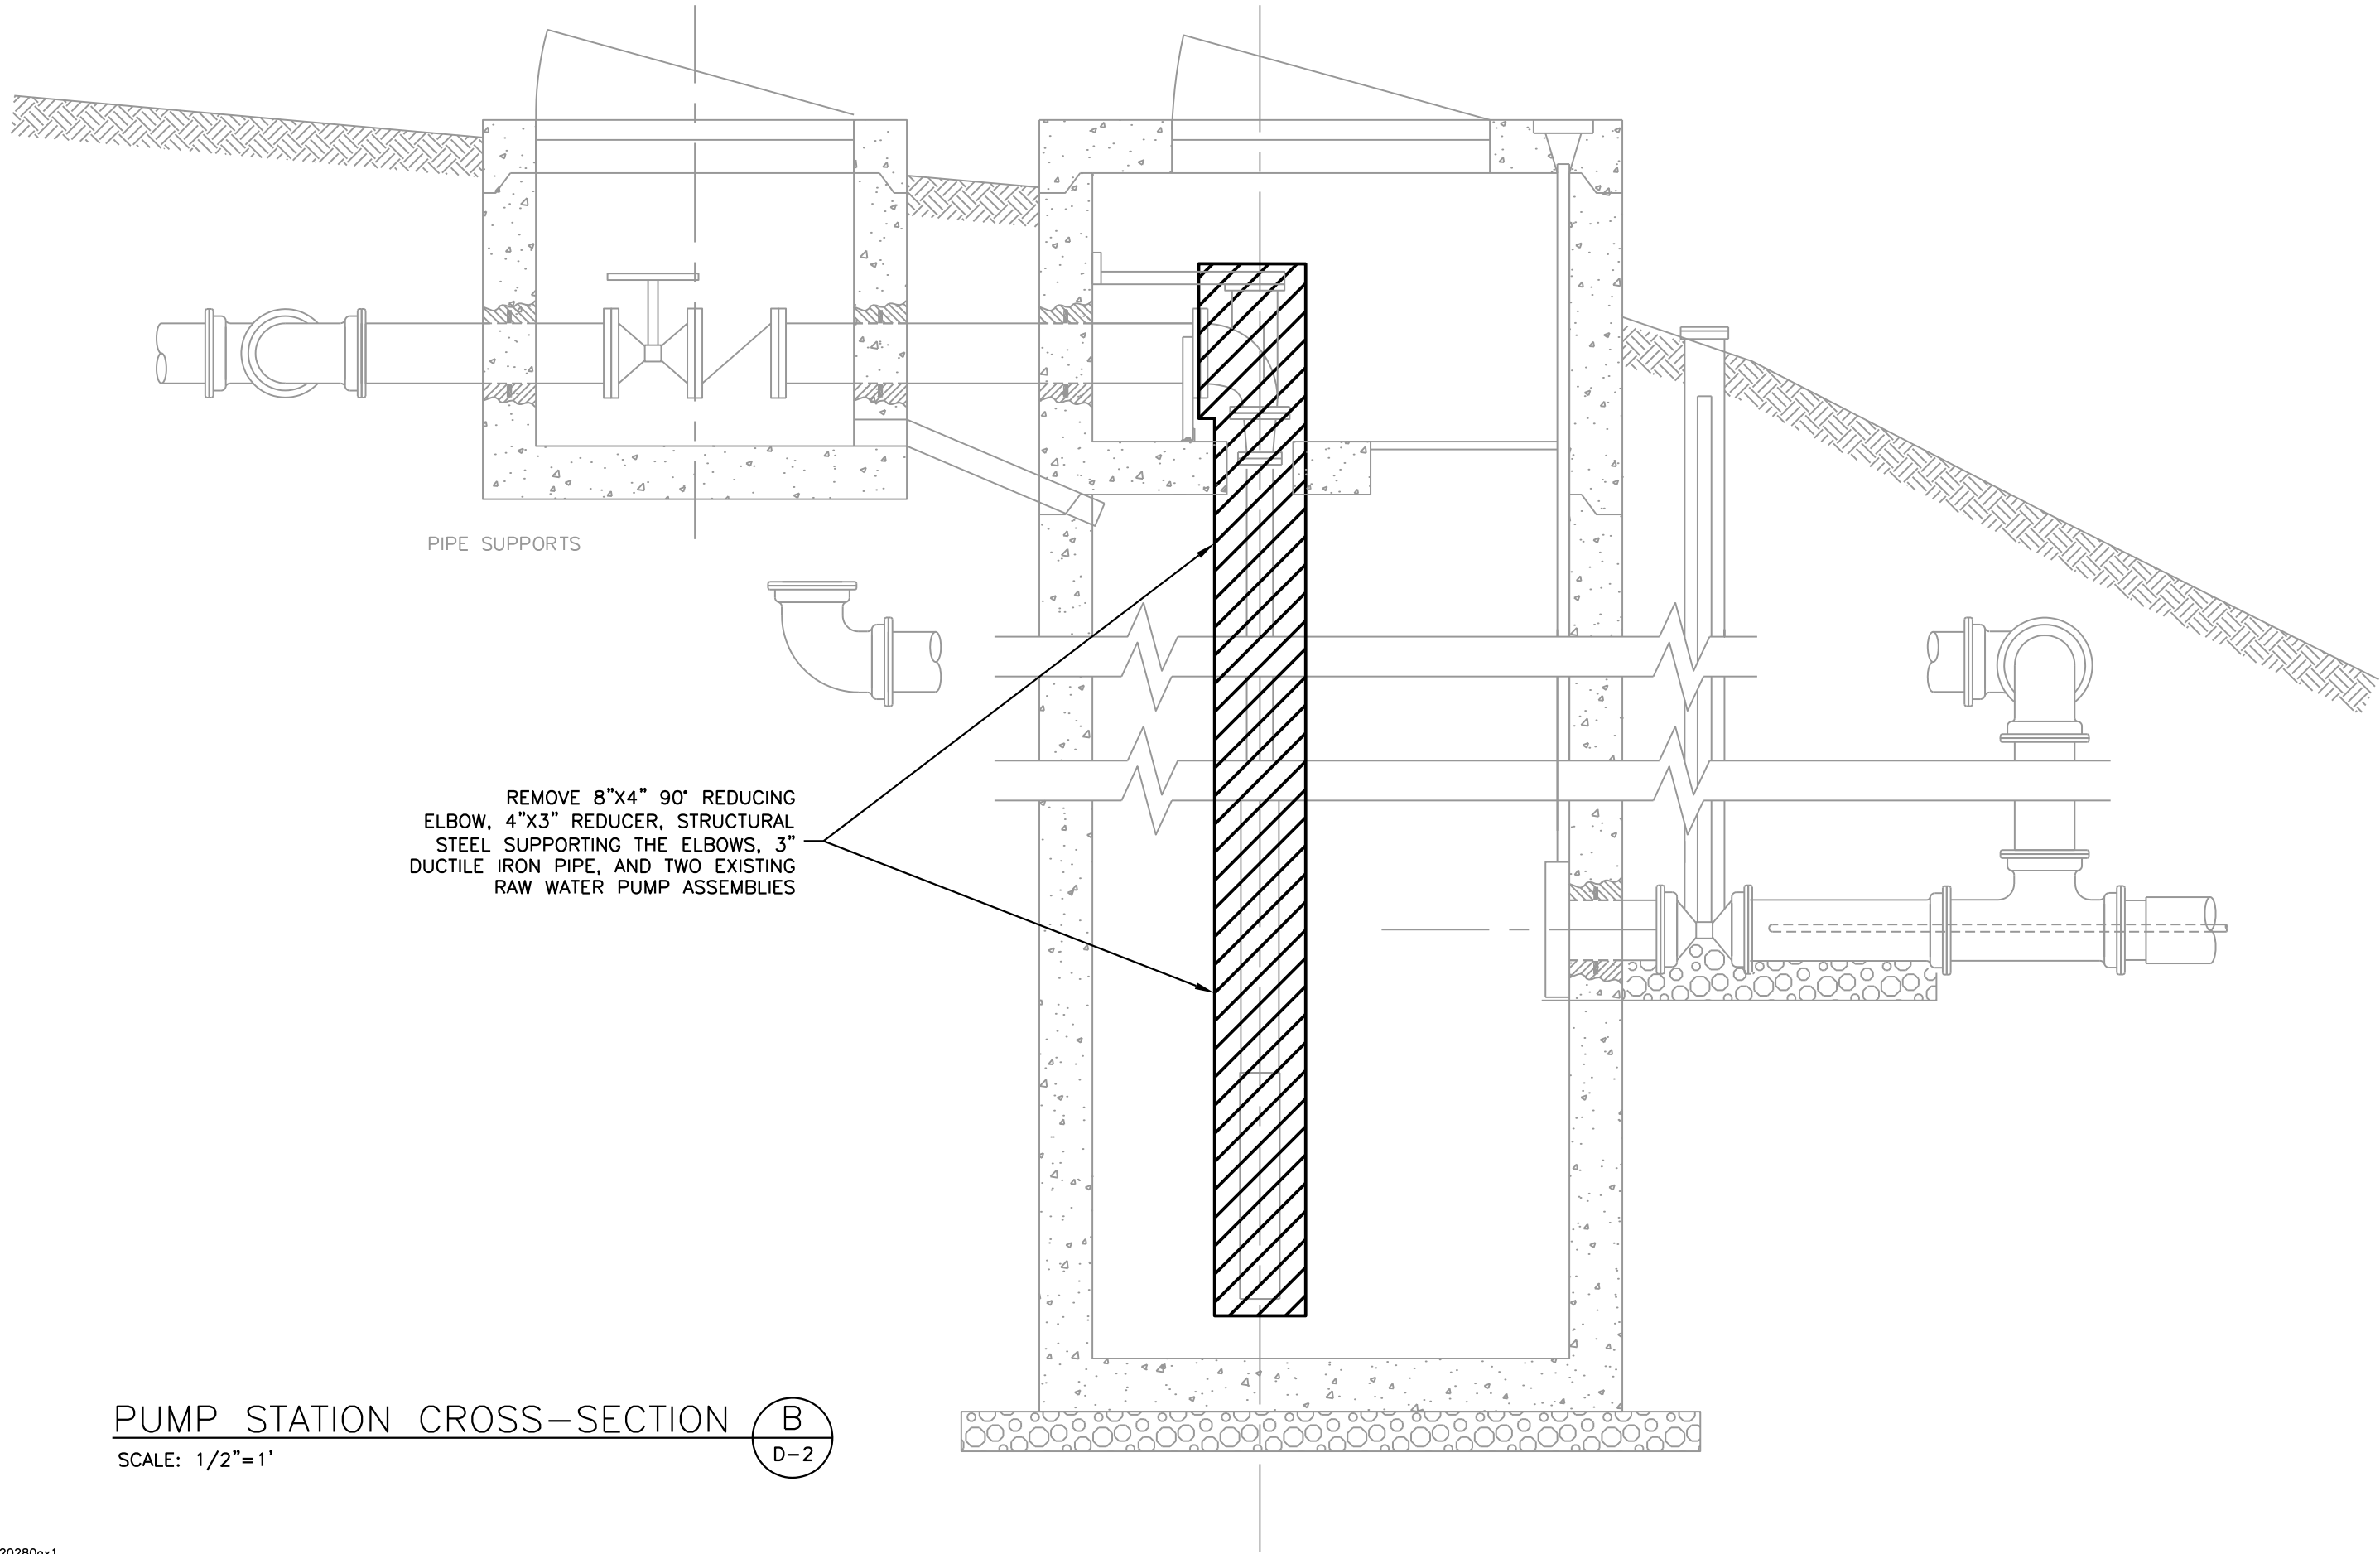

REMOVE 8"x4" 90° REDUCING
ELBOW, 4"x3" REDUCER, STRUCTURAL
STEEL SUPPORTING THE ELBOWS, 3"
DUCTILE IRON PIPE, AND TWO EXISTING
RAW WATER PUMP ASSEMBLIES


PUMP STATION CROSS-SECTION **B**
D-2
SCALE: 1/2"=1'

LEGEND



EQUIPMENT & FACILITIES
HATCHED SHOWN TO BE
REMOVED/REPLACED/RELOCATED

PROPOSED _____
EXISTING _____

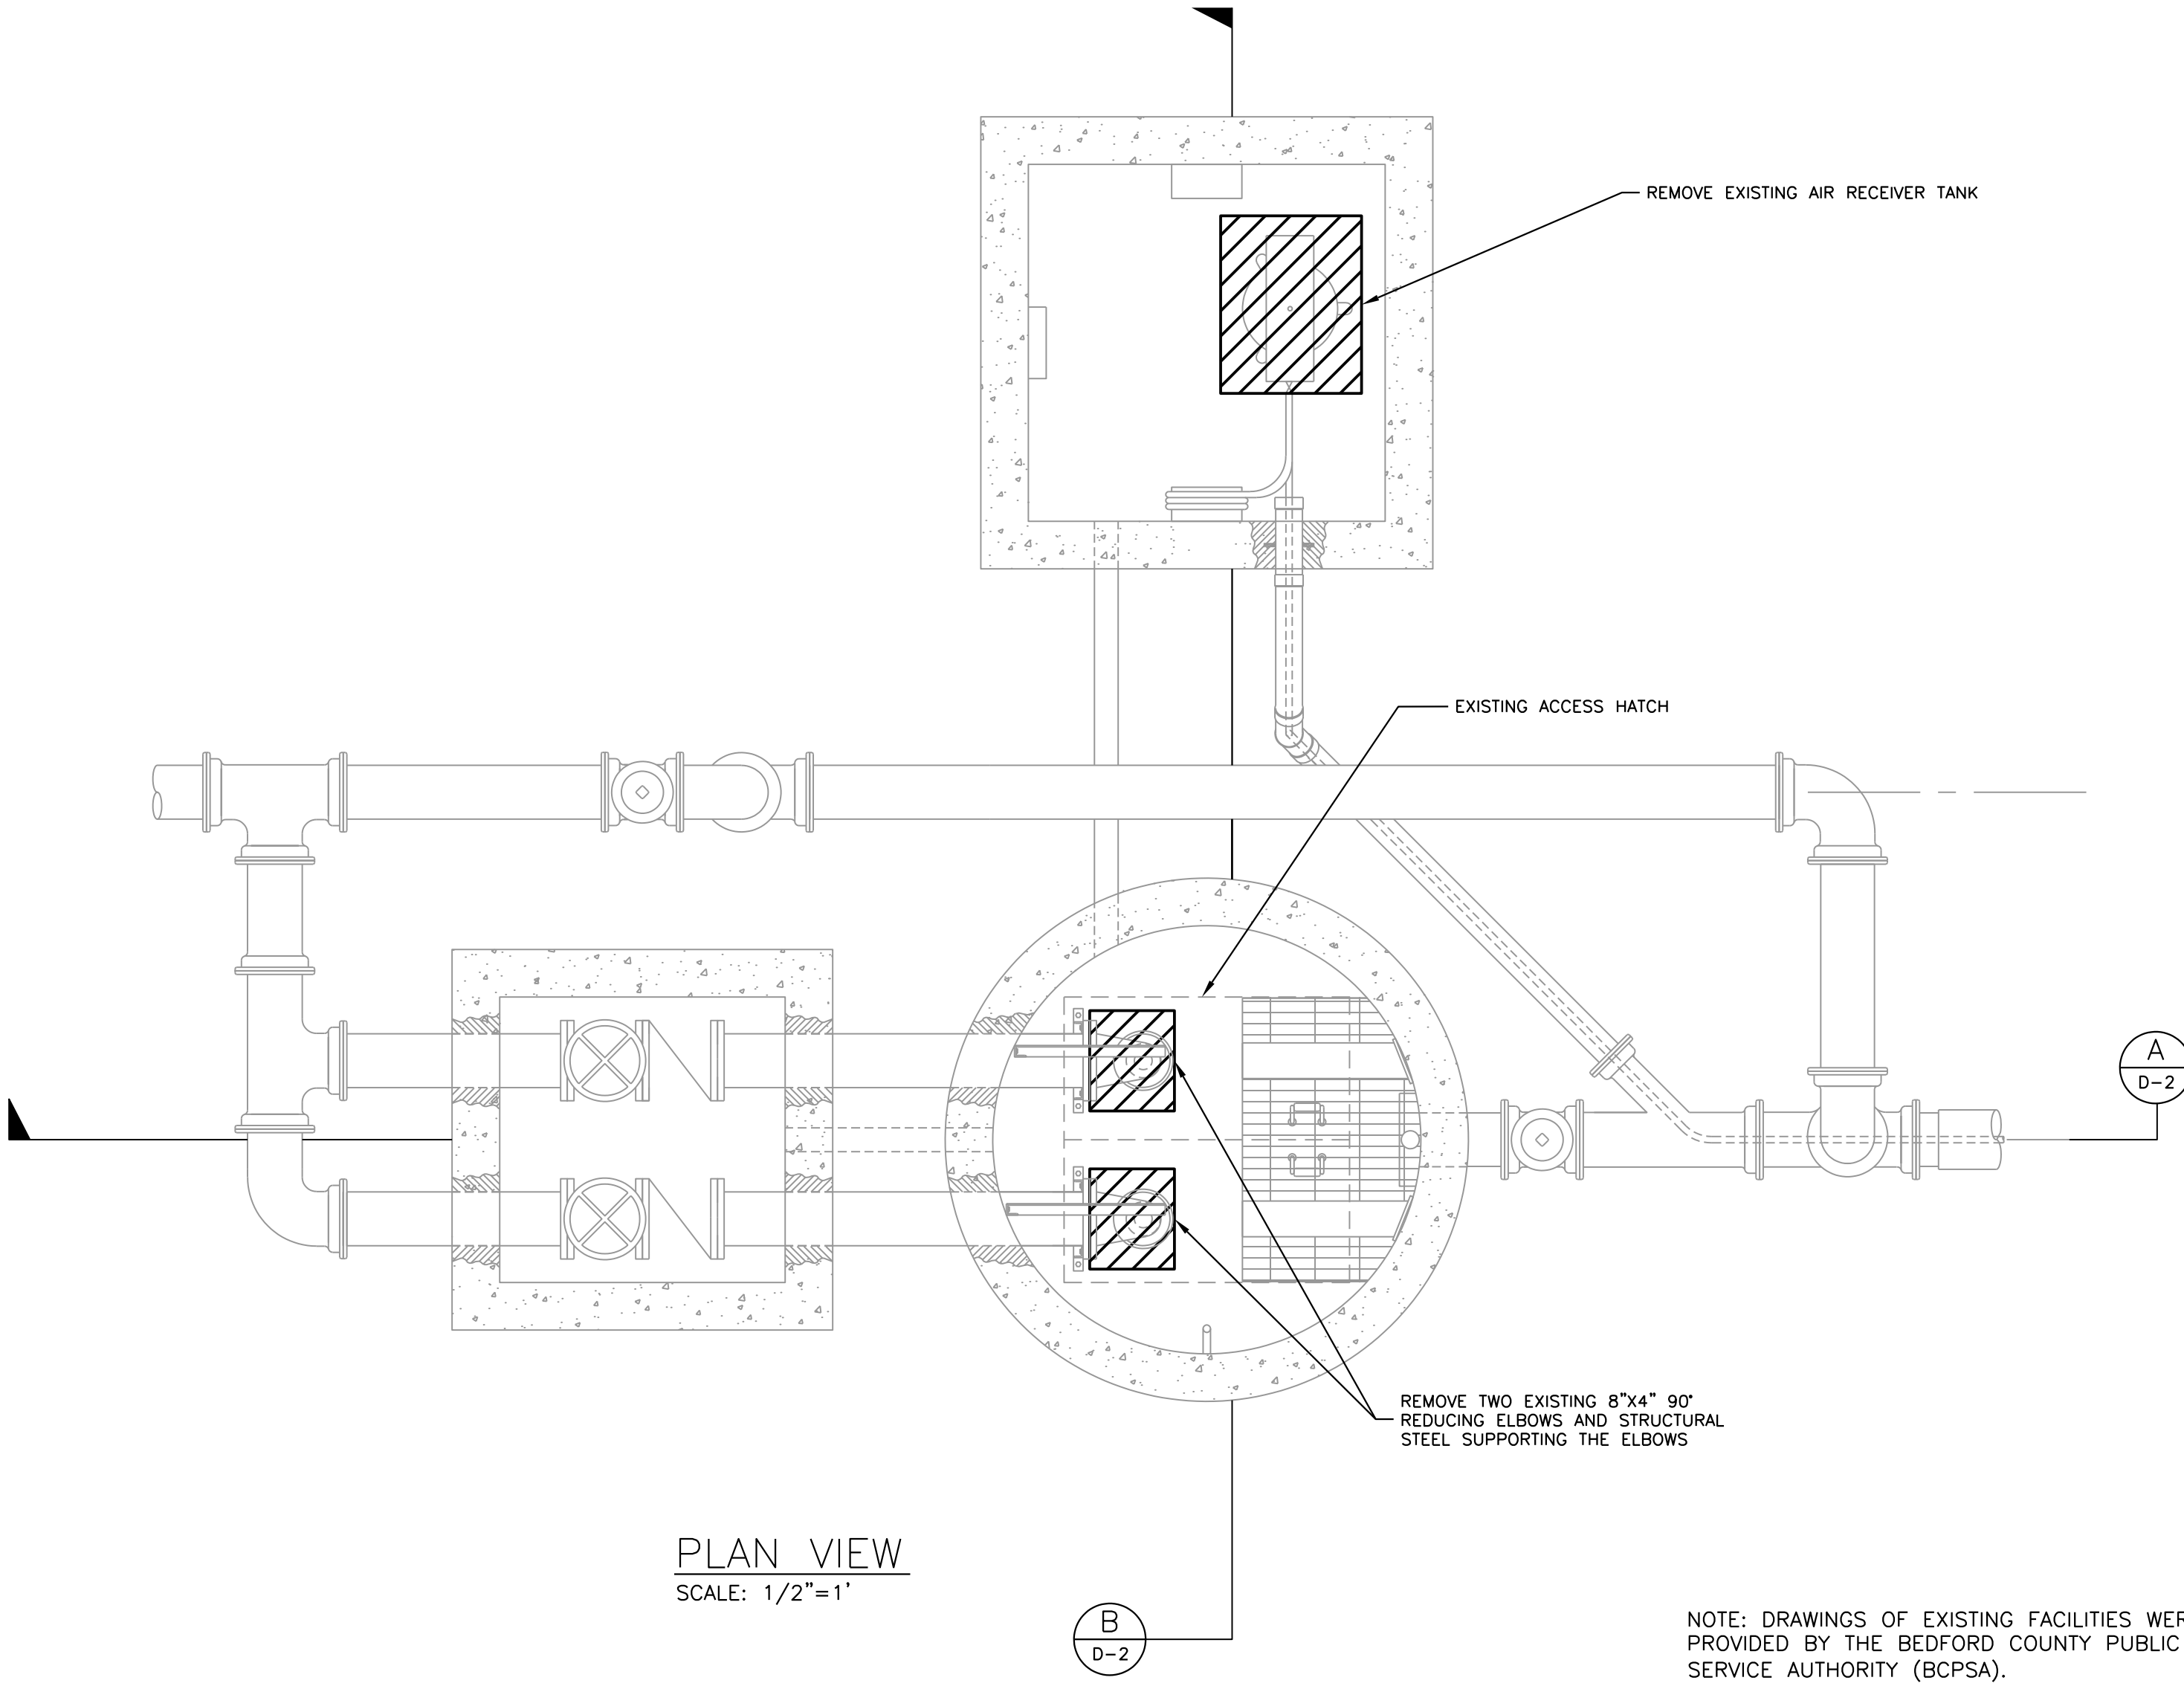

REMOVE EXISTING AIR RECEIVER TANK

EXISTING ACCESS HATCH

REMOVE TWO EXISTING 8"x4" 90°
REDUCING ELBOWS AND STRUCTURAL
STEEL SUPPORTING THE ELBOWS


PLAN VIEW
SCALE: 1/2"=1'

NOTE: DRAWINGS OF EXISTING FACILITIES WERE
PROVIDED BY THE BEDFORD COUNTY PUBLIC
SERVICE AUTHORITY (BCPSA).

3-REF: 20280-1
8/03, ROANOKE, BSR
P:\20280\30\Drawings\Demo\

NOTES:
Underground facilities, structures, and utilities have been plotted from available surveys and records, and therefore their locations must be considered approximate only. There may be others, the existence of which is presently not known.

3	ISSUED FOR CONSTRUCTION												
2	REVISED PER OWNER & VDH COMMENTS				RRC	6/21/04							
	BSR	6/04	WPJ	CMT									
1	FOR APPROVAL				RRC	1/23/04							
	BSR	11/03	WPJ	CMT									
ISSUE NO.	DRAWN	DATE	CHECKED	DESIGNER	APPROVED	DATE							
PROJECT SUPERVISOR			DEPARTMENT SUPERVISOR										
-----							ISSUE NO.	DRAWN	DATE	CHECKED	DESIGNER	APPROVED	DATE

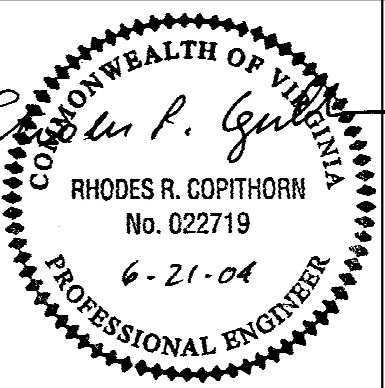

Stearns & Wheler, LLC
Environmental Engineers and Scientists


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BEDFORD COUNTY PUBLIC SERVICE AUTHORITY


HIGH POINT WTP EXPANSION – PROJECT NO. 2003 – 028

RAW WATER PUMP STATION
DEMOLITION PLAN

JOB NO. 20280 DRAWING D-2 SHEET 5 OF 37

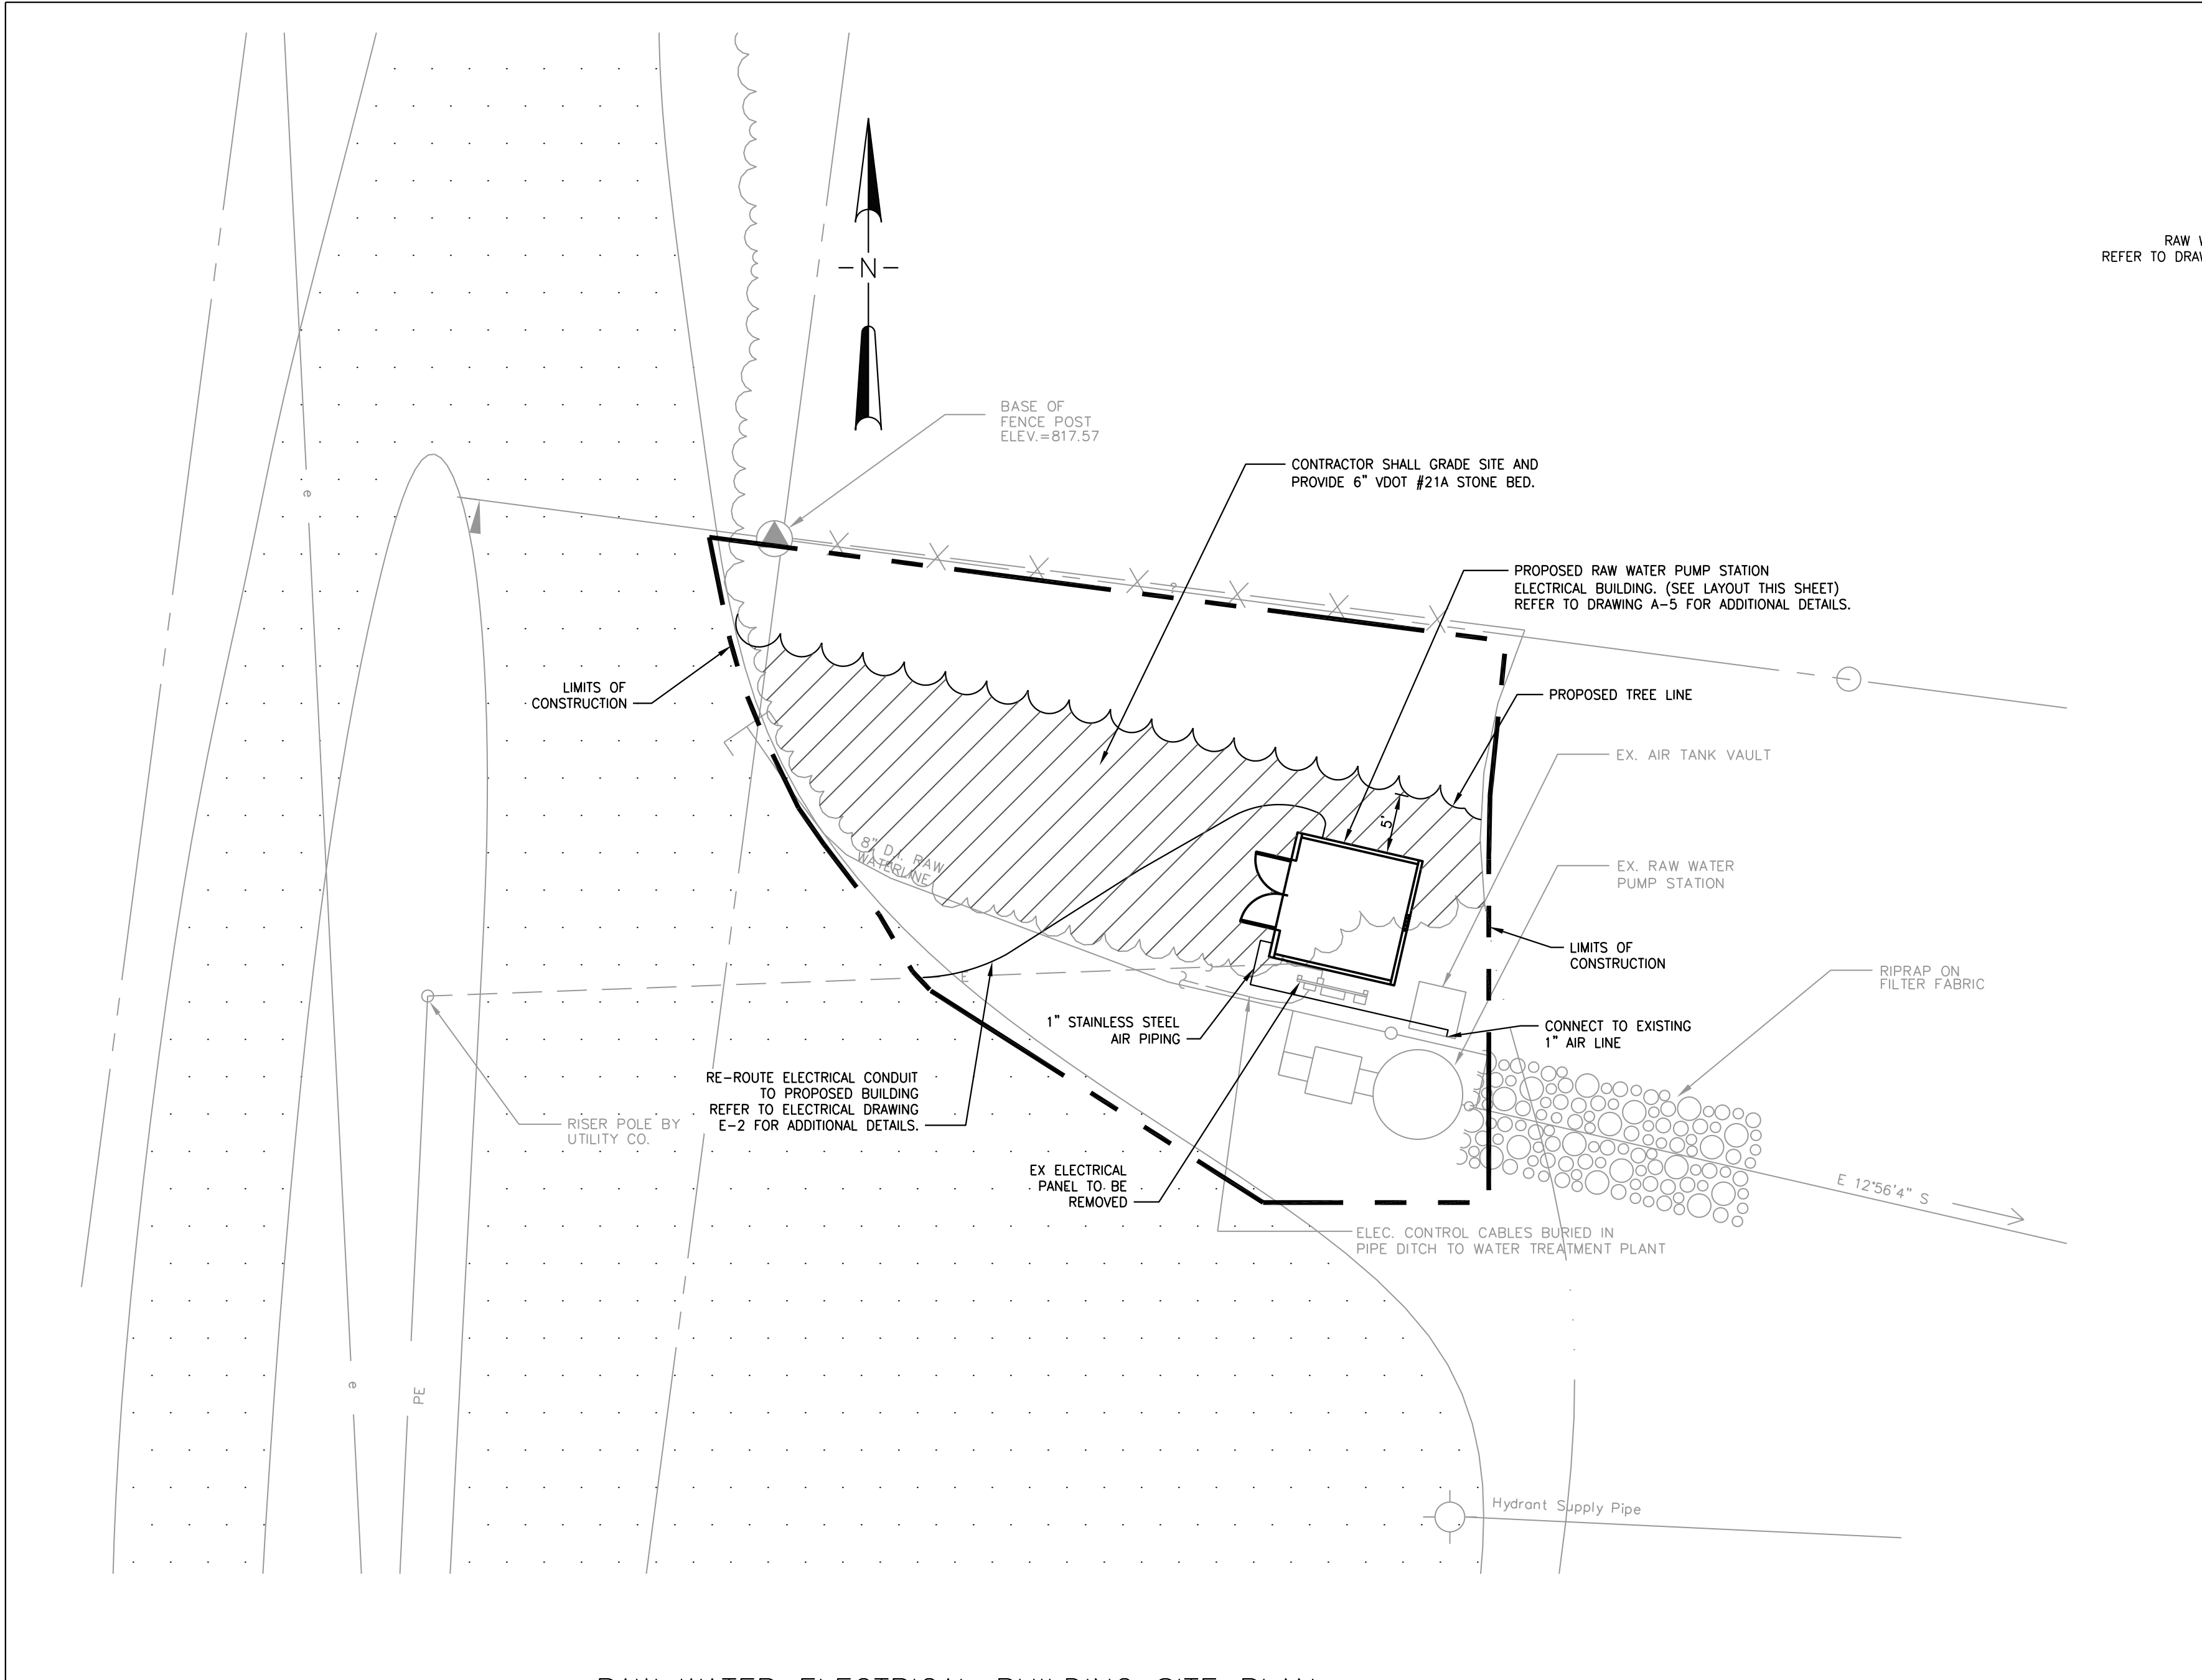

RAW WATER ELECTRICAL BUILDING SITE PLAN
SCALE: 1"=10'-0"

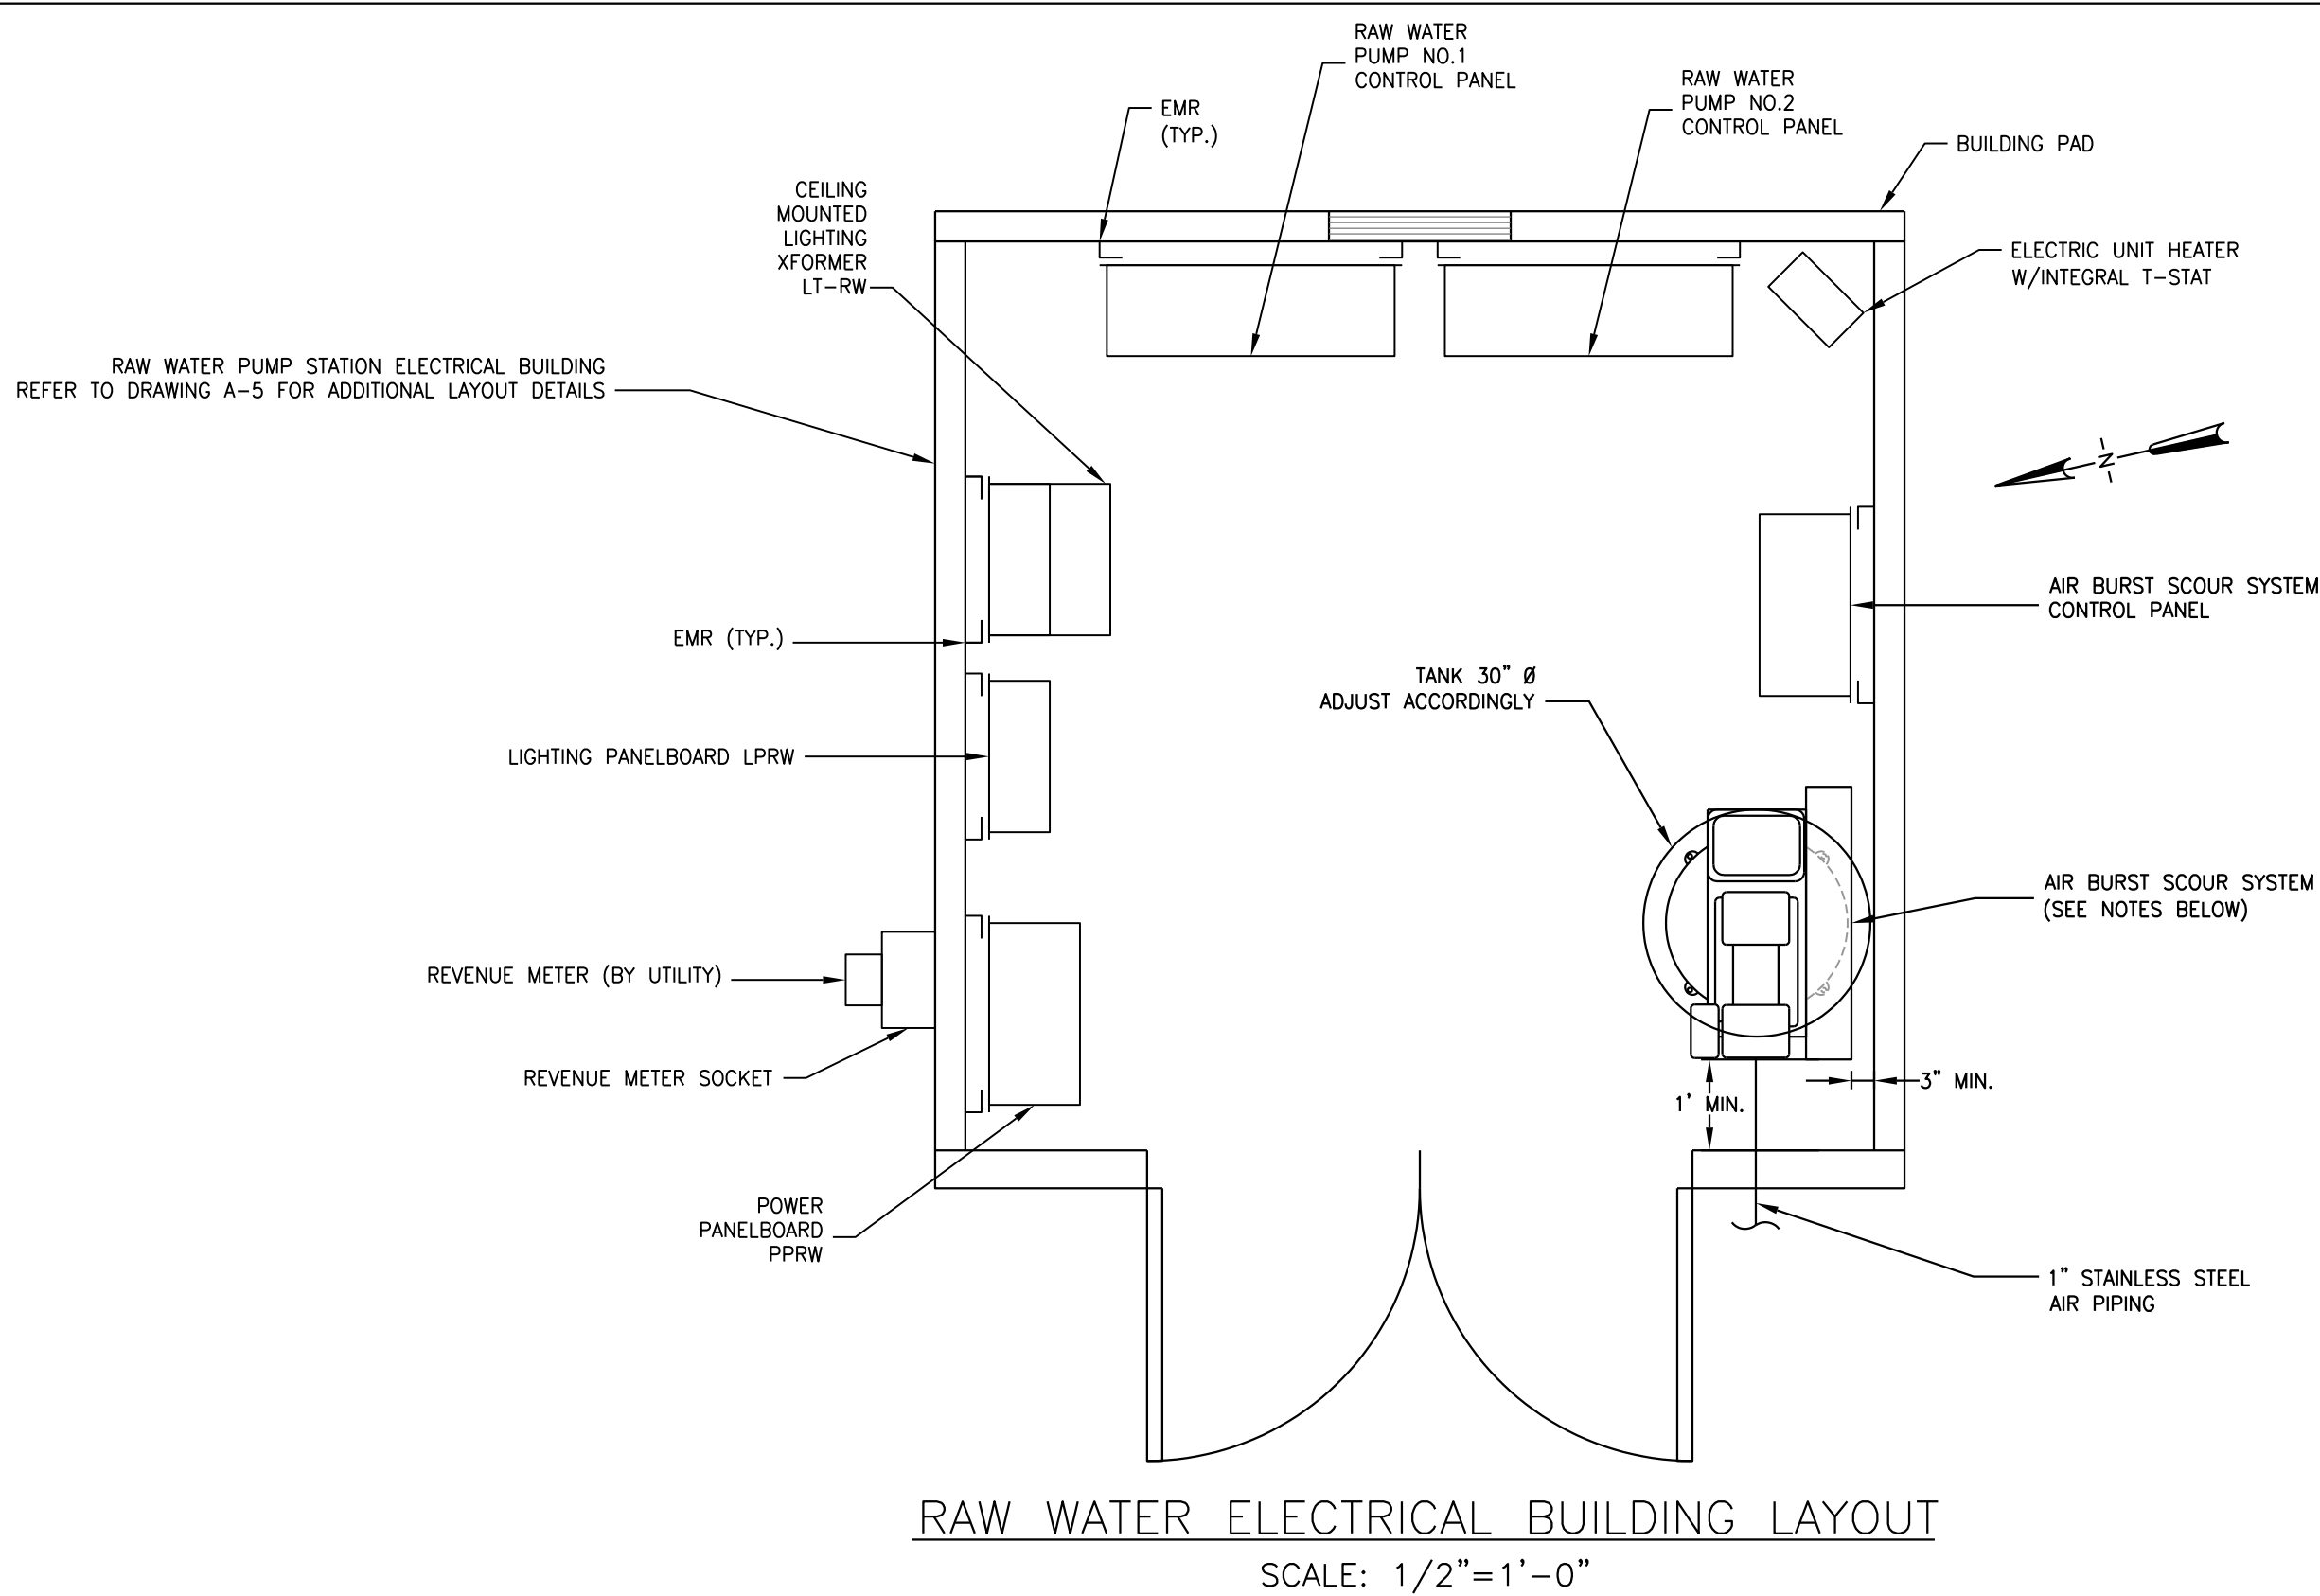

RAW WATER ELECTRICAL BUILDING LAYOUT
SCALE: 1/2"=1'-0"

AIR BURST SCOUR SYSTEM (ABSS) NOTES:

- AIR BURST SCOUR SYSTEM SHALL BE COOK LEGACY COATING COMPANY ABSS SYSTEM OR APPROVED EQUAL.
- AIR BURST SCOUR SYSTEM SHALL PROVIDE A BURST OF 3 SCREEN VOLUMES AT THE SCREEN (LEE COOK INTAKE SCREEN MODEL S-24, 24" DIAMETER X 24" LONG SCREEN) IN NO MORE THAN THREE (3) SECONDS.
- AIR BURST SCOUR SYSTEM SHALL CONSIST OF THE FOLLOWING:
 - MOTOR:** MOTOR SHALL BE 5HP, 230/460V, 3 PHASE, 60 HZ.
 - COMPRESSOR:** INGERSOLL RAND MODEL 2475NS FULLY PACKAGED AIR COMPRESSOR. THE STARTER SHALL INCLUDE AN AIR COOLED AFTER COOLER AND AN EDV 2000 ELECTRIC DRAIN VALVE. THE COMPRESSOR SHALL BE ABLE TO DELIVER 1.5 ACFM AT 120 PSI.
 - RECEIVER:** RECEIVER SHALL MEET ASME CODE VESSEL REQUIREMENTS. RECEIVER SHALL BE 120 GALLON VERTICAL TANK OPERATING AT 175 PSIG AND SHALL BE EQUIPPED WITH PRESSURE RELIEF VALVE SIZED TO HANDLE THE FULL DISCHARGE PRESSURE OF THE COMPRESSOR, A 4" DIAL PRESSURE GAGE, AND A FLOAT TYPE AUTOMATIC DRAIN.
 - VALVES:** VALVES SHALL BE ELECTRICALLY ACTUATED, SPRING LOADED BALL OR BUTTERFLY TYPE VALVES.
 - ACTUATORS:** ACTUATORS SHALL BE PNEUMATIC, DOUBLE ACTING TYPE.
 - CONTROL PANEL:** CONTROLS SHALL BE ENCLOSED IN A NEMA 4V ENCLOSURE. MOTOR STARTER(S) ARE MOUNTED IN THE CONTROL PANEL. ALL PANELS HAVE A POWER ON LIGHT, A TEST/OFF/AUTO SWITCH FOR COMPRESSOR CONTROL, AND A LOCKABLE DISCONNECT. SYSTEM CONTROL LOGIC SHALL BE DETERMINED BY AN ALLEN BRADLEY PLC SYSTEM (SLC 505 AND A PANELVIEW 600). VISUAL DISPLAY SHALL BE A COLOR TOUCH SCREEN. SYSTEM SHALL ALSO INCLUDE PUSH BUTTON VALVE INITIATION (INCLUDES CONTROL AIR RECEIVER AND PNEUMATIC ACTUATORS WITH MANUAL OVER-RIDE. INDICATOR LIGHTS TO INDICATE: "READY FOR BACKWASH," AND "VALVE FAIL TO OPEN." CONTROL PANEL SHALL BE DESIGNED TO BURST ONLY WHEN INTAKE PUMP(S) ARE INACTIVE. PLC SYSTEM FILES (.RSS FILE) AND PASSWORDS SHALL BE PROVIDED BY THE CONTRACTOR FOR OWNER'S USE.
- FUNCTIONAL SPECIFICATION OF ABSS SYSTEM:
 - AUTOMATIC OPERATION**
 - AUTOMATIC OPERATION OF THE AIR BURST SCOUR SYSTEM IS DETERMINED BY RAW WATER PUMP OPERATION.
 - THE AIR BURST SCOUR CONTROL SYSTEM SHALL INITIATE WHEN THE RAW WATER PUMP(S) HAVE CYCLED OFF.
 - THE LOGIC IN THE AIR BURST CONTROL PANEL WILL LOCKOUT THE ABILITY FOR THE RAW WATER PUMP(S) TO BE STARTED. NOTE: IF THE PLANT PLC SIGNALS THE PUMPS TO START, THE PLANT PLC WILL RECEIVE A PUMP START FAILURE INDICATION.
 - THE AIR BURST CONTROL PANEL WILL SEND A SIGNAL TO THE ACTUATED VALVE(S) TO OPEN THE VALVE(S) AND RELEASE THE COMPRESSED AIR.

RAW WATER ELECTRICAL BUILDING NOTES:

- CONTRACTOR SHALL FIELD VERIFY BUILDING LOCATION & FINISHED FLOOR ELEVATION PRIOR TO CONSTRUCTION.
- ELECTRICAL BUILDING SHALL BE A PRECAST UTILITY BUILDING AS MANUFACTURED BY THE CLEAR FLOW COMPANY OR APPROVED EQUAL.
- EXTERIOR BUILDING FINISH TO BE SELECTED BY OWNER PRIOR TO CONSTRUCTION.


AIR BURST SCOUR SYSTEM NOTES (CONT'D):

- THE VALVE(S) SHALL REMAIN OPEN FOR UP TO 3 SECONDS TO ALLOW 3 SCREEN VOLUMES OF AIR TO BE RELEASED TO THE SCREEN.
 - THE AIR BURST CONTROL PANEL WILL SEND A SECOND SIGNAL BACK TO THE VALVE(S) TO CLOSE THE VALVE(S).
 - ONCE THE VALVE(S) CLOSE, THE RAW WATER PUMPS SHALL BE ENABLED TO BE STARTED.
 - A PRESSURE SWITCH ON THE AIR BURST SYSTEM WILL SENSE LOW PRESSURE AND START THE COMPRESSOR, FILL THE TANK, AND THEN SHUT OFF.
 - THE FILL TIME FOR THE TANK IS APPROXIMATELY 22 MINUTES.
 - AIR BURST WILL NOT BE INITIATED UNTIL THE TANK IS FILLED.
 - THE PUMPS SHALL BE ALLOWED TO CYCLE ON AND OFF (OPERATE NORMALLY) WHILE THE COMPRESSOR SYSTEM IS RECHARGING THE RECEIVER TANK.
- B. MANUAL OPERATION**
- MANUAL OPERATION OF THE AIR BURST SCOUR SYSTEM CAN BE INITIATED BY PLACING THE MODE SWITCH ON THE CONTROL PANEL IN THE MANUAL POSITION.
 - THE OPERATOR CAN USE THE PUSHBUTTONS ON THE FACE OF THE AIR BURST PANEL TO OPEN AND CLOSE THE VALVE(S). NOTE: WHILE THE MODE SWITCH IS IN MANUAL, THE LOGIC IN THE AIR BURST CONTROL PANEL WILL LOCK OUT THE ABILITY FOR THE RAW WATER PUMPS TO BE STARTED.
 - ONCE THE VALVE(S) ARE MANUALLY CLOSED, THE MODE SWITCH MUST BE SWITCHED TO AUTO OR TIMED.
 - A PRESSURE SWITCH ON THE AIR BURST SYSTEM WILL SENSE LOW PRESSURE AND START THE COMPRESSOR, FILL THE TANK, AND THEN SHUT OFF.
 - THE FILL TIME FOR THE TANK IS APPROXIMATELY 22 MINUTES.
 - AIR BURST WILL NOT BE INITIATED UNTIL THE TANK IS FILLED.
 - THE PUMPS SHALL BE ALLOWED TO CYCLE ON AND OFF (OPERATE NORMALLY) WHILE THE COMPRESSOR SYSTEM IS RECHARGING THE RECEIVER TANK.
- C. TIMER OPERATION**
- THE AIR BURST SCOUR CONTROL SYSTEM SHALL HAVE A PARALLEL TIMER OPERATION WHERE THE CONTROL SYSTEM SHALL HAVE A SEVEN (7) DAY CLOCK TIMER TO INITIATE THE AIR BURST CYCLE. NOTE: IF THE RAW WATER PUMPS ARE RUNNING WHEN THE TIMER IS TRIGGERED, THE AIR BURST WILL NOT TAKE PLACE UNTIL THE PUMPS HAVE CYCLED OFF.
 - A PRESSURE SWITCH ON THE AIR BURST SYSTEM WILL SENSE LOW PRESSURE AND START THE COMPRESSOR, FILL THE TANK, AND THEN SHUT OFF.
 - THE FILL TIME FOR THE TANK IS APPROXIMATELY 22 MINUTES.
 - AIR BURST WILL NOT BE INITIATED UNTIL THE TANK IS FILLED.
 - THE PUMPS SHALL BE ALLOWED TO CYCLE ON AND OFF (OPERATE NORMALLY) WHILE THE COMPRESSOR SYSTEM IS RECHARGING THE RECEIVER TANK.

A-REF: 20280-A-RWPS-PL, 20280-C-RWPS
8/03, ROANOKE, ISB
P:\20280\30\Drawings\Civil

NOTES:
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3	ISSUED FOR CONSTRUCTION																		
	REVISED PER OWNER & VDH COMMENTS																		
2	BSR	6/04	WPJ	CMT	RRC	6/21/04													
	FOR APPROVAL																		
1	BSR	11/03	WPJ	CMT	RRC	1/23/04													
	ISSUE NO.	DRAWN	DATE	CHECKED	DESIGNER	APPROVED	DATE												
PROJECT SUPERVISOR					DEPARTMENT SUPERVISOR					ISSUE NO.	DRAWN	DATE	CHECKED	DESIGNER	APPROVED	DATE			

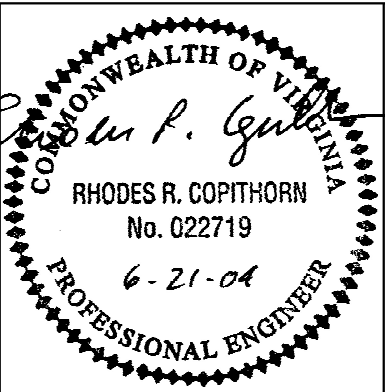

Stearns & Wheler, LLC
Environmental Engineers and Scientists

310 FIRST STREET, S.W., SUITE 150
ROANOKE, VIRGINIA 24011
PHONE: (540) 982-1910 FAX: (540) 982-1913


BEDFORD COUNTY PUBLIC SERVICE AUTHORITY

HIGH POINT WTP EXPANSION – PROJECT NO. 2003 – 028

**RAW WATER PUMP STATION
ELECTRICAL BUILDING SITE
PLAN & DETAILS**

JOB NO. 20280 DRAWING C-1 SHEET 6 OF 37

NOTE: DRAWINGS OF EXISTING FACILITIES WERE PROVIDED BY THE BEDFORD COUNTY PUBLIC SERVICE AUTHORITY (BCPSA).

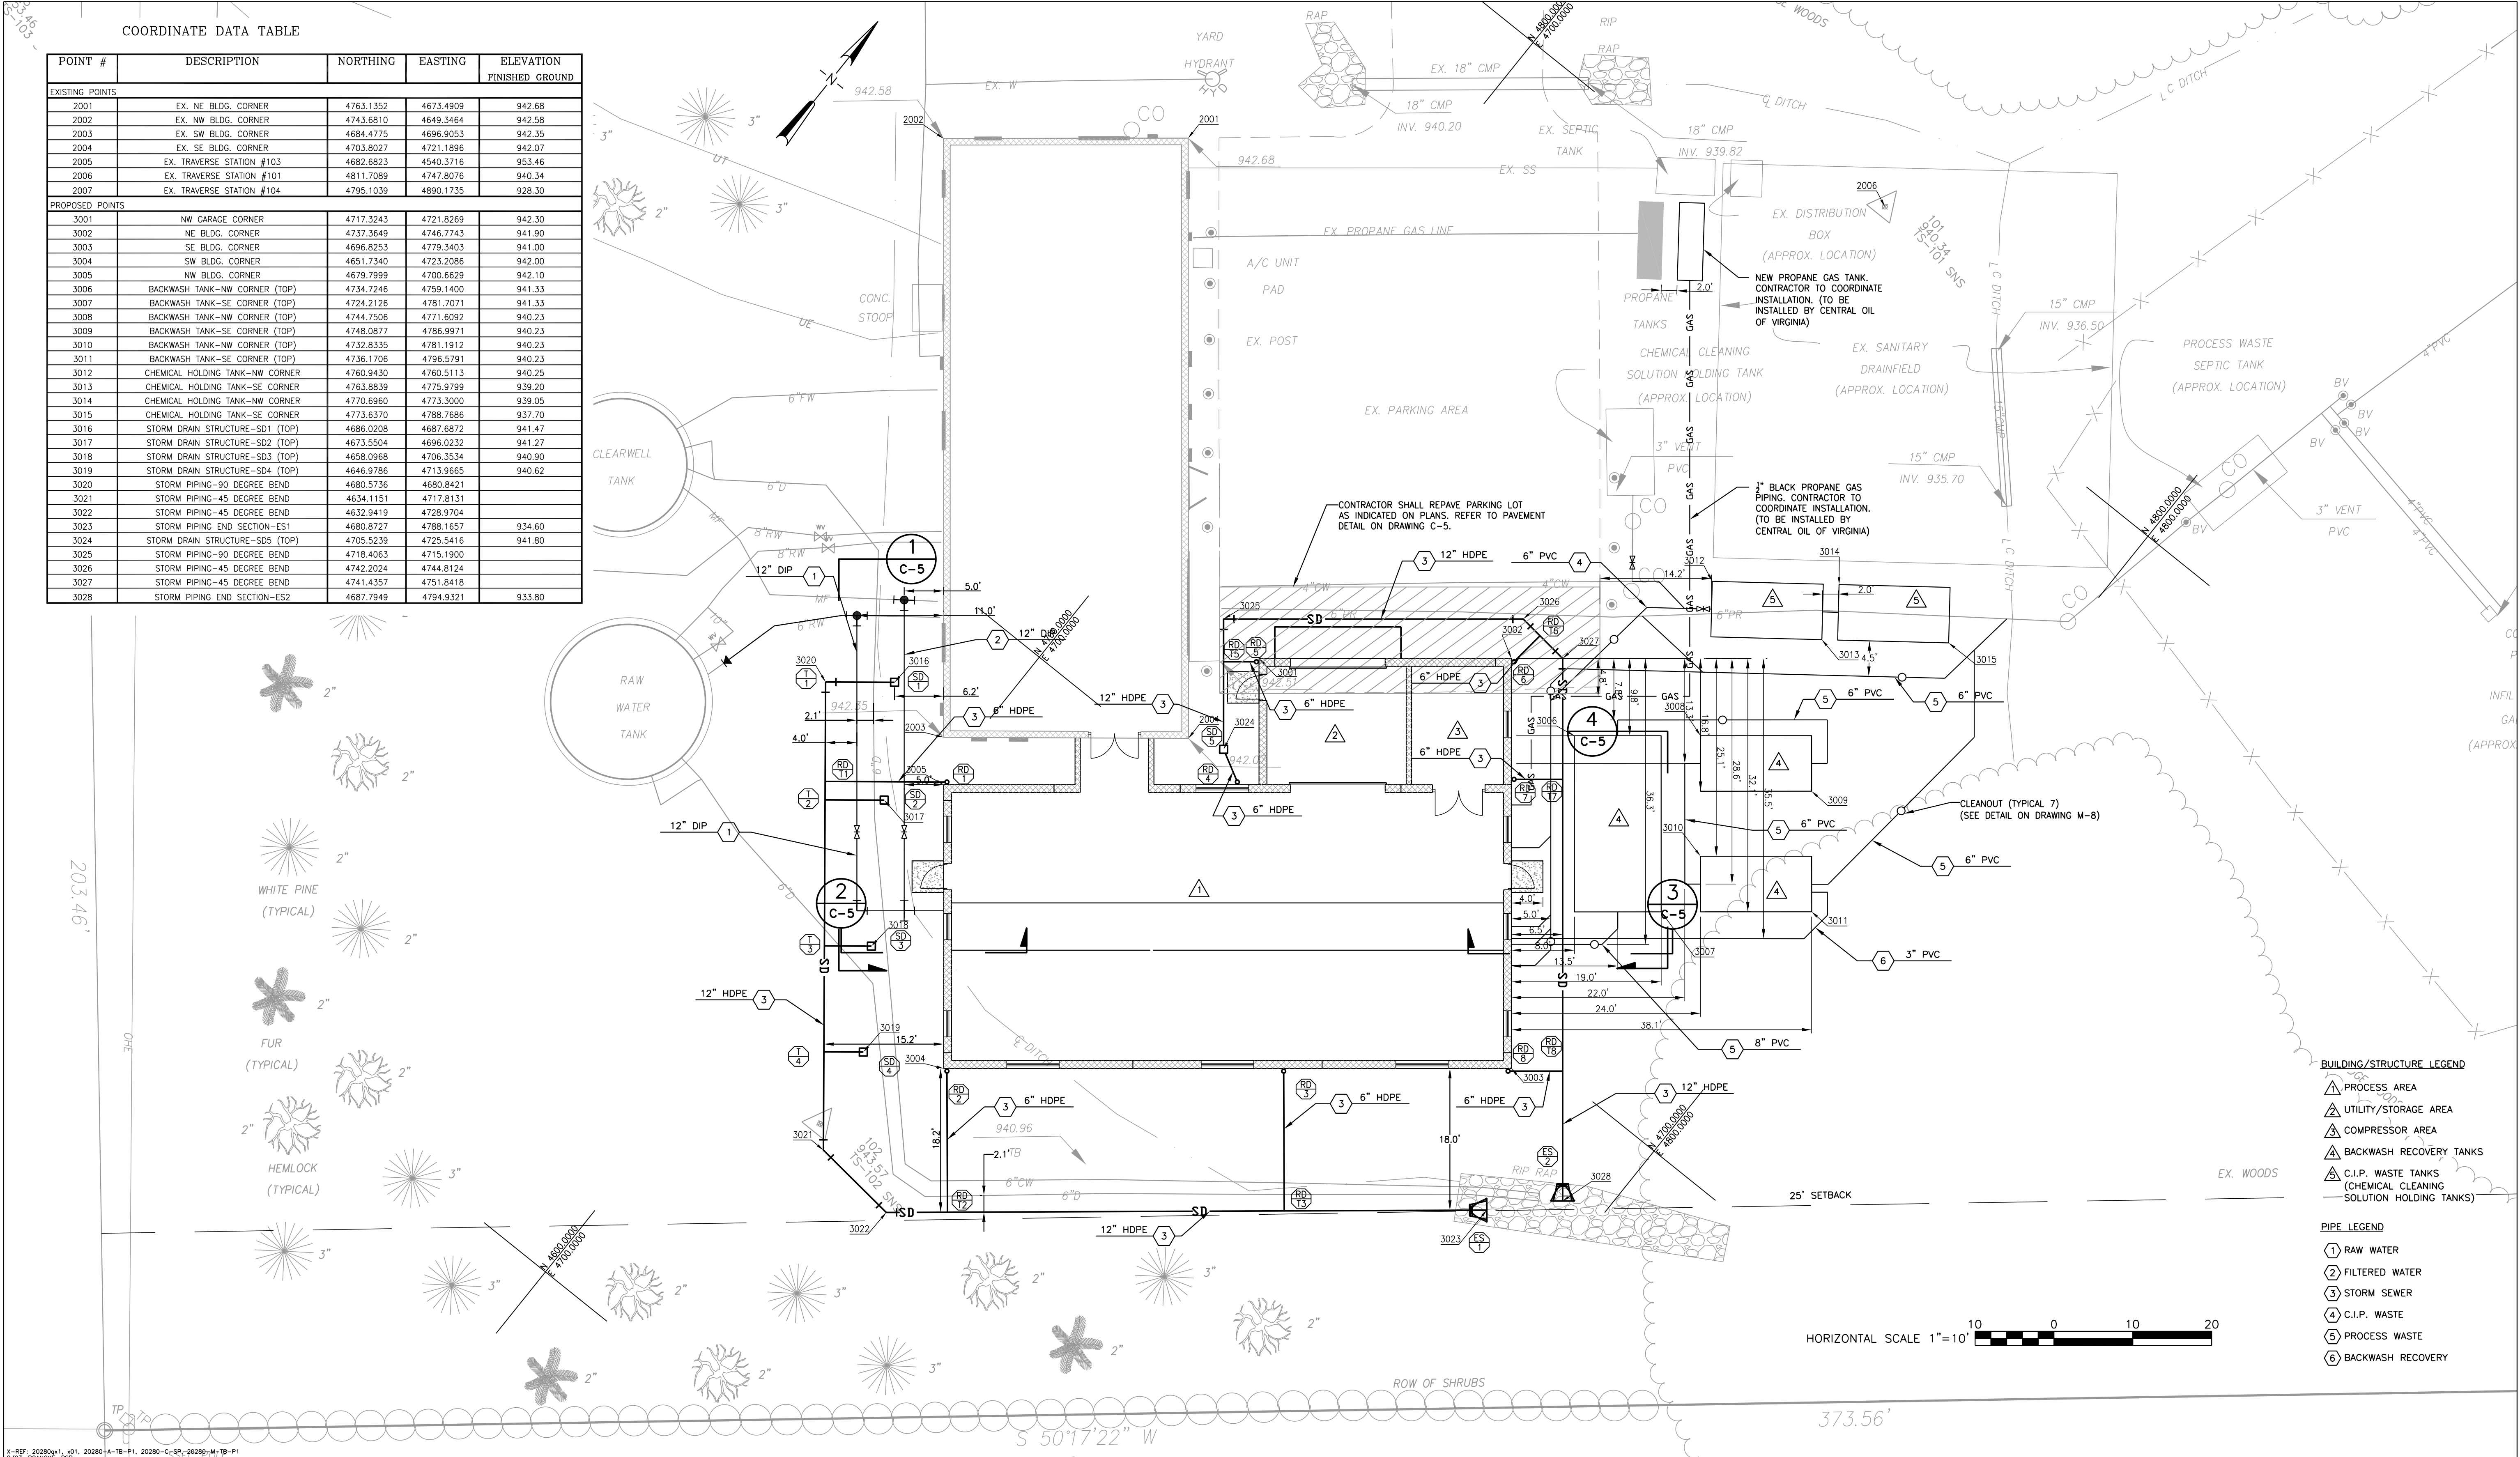

COORDINATE DATA TABLE


POINT #	DESCRIPTION	NORTHING	EASTING	ELEVATION FINISHED GROUND
EXISTING POINTS				
2001	EX. NE BLDG. CORNER	4763.1352	4673.4909	942.68
2002	EX. NW BLDG. CORNER	4743.6810	4649.3464	942.58
2003	EX. SW BLDG. CORNER	4684.4775	4696.9053	942.35
2004	EX. SE BLDG. CORNER	4703.8027	4721.1896	942.07
2005	EX. TRAVERSE STATION #103	4682.6823	4540.3716	953.46
2006	EX. TRAVERSE STATION #101	4811.7089	4747.8076	940.34
2007	EX. TRAVERSE STATION #104	4795.1039	4890.1735	928.30
PROPOSED POINTS				
3001	NW GARAGE CORNER	4717.3243	4721.8269	942.30
3002	NE BLDG. CORNER	4737.3649	4746.7743	941.90
3003	SE BLDG. CORNER	4696.8253	4779.3403	941.00
3004	SW BLDG. CORNER	4651.7340	4723.2086	942.00
3005	NW BLDG. CORNER	4679.7999	4700.6629	942.10
3006	BACKWASH TANK-NW CORNER (TOP)	4734.7246	4759.1400	941.33
3007	BACKWASH TANK-SE CORNER (TOP)	4724.2126	4781.7071	941.33
3008	BACKWASH TANK-NW CORNER (TOP)	4744.7506	4771.6092	940.23
3009	BACKWASH TANK-SE CORNER (TOP)	4748.0877	4786.9971	940.23
3010	BACKWASH TANK-NW CORNER (TOP)	4732.8335	4781.1912	940.23
3011	BACKWASH TANK-SE CORNER (TOP)	4736.1706	4796.5791	940.23
3012	CHEMICAL HOLDING TANK-NW CORNER	4760.9430	4760.5113	940.25
3013	CHEMICAL HOLDING TANK-SE CORNER	4763.8839	4775.9799	939.20
3014	CHEMICAL HOLDING TANK-NW CORNER	4770.6960	4773.3000	939.05
3015	CHEMICAL HOLDING TANK-SE CORNER	4773.6370	4788.7686	937.70
3016	STORM DRAIN STRUCTURE-SD1 (TOP)	4686.0208	4687.6872	941.47
3017	STORM DRAIN STRUCTURE-SD2 (TOP)	4673.5504	4696.0232	941.27
3018	STORM DRAIN STRUCTURE-SD3 (TOP)	4658.0968	4706.3534	940.90
3019	STORM DRAIN STRUCTURE-SD4 (TOP)	4646.9786	4713.9665	940.62
3020	STORM PIPING-90 DEGREE BEND	4680.5736	4680.8421	
3021	STORM PIPING-45 DEGREE BEND	4634.1151	4717.8131	
3022	STORM PIPING-45 DEGREE BEND	4632.9419	4728.9704	
3023	STORM PIPING END SECTION-ES1	4680.8727	4788.1657	934.60
3024	STORM DRAIN STRUCTURE-SD5 (TOP)	4705.5239	4725.5416	941.80
3025	STORM PIPING-90 DEGREE BEND	4718.4063	4715.1900	
3026	STORM PIPING-45 DEGREE BEND	4742.2024	4744.8124	
3027	STORM PIPING-45 DEGREE BEND	4741.4357	4751.8418	
3028	STORM PIPING END SECTION-ES2	4687.7949	4794.9321	933.80

A-REF: 20280a1.d01, 20280-A-TB-P1, 20280-C-SF, 20280-M-TB-P1
8/03, ROANOKE, VIR
P:\20280\30\Drawings\Civil

NOTES:

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3	ISSUED FOR CONSTRUCTION												
2	RE-SEALED				RRC	6/21/04							
1	FOR APPROVAL				RRC	1/23/04							
	BSR	11/03	WPJ	CMT									
ISSUE NO.	DRAWN	DATE	CHECKED	DESIGNER	APPROVED	DATE							
PROJECT SUPERVISOR					DEPARTMENT SUPERVISOR								
-----							ISSUE NO.	DRAWN	DATE	CHECKED	DESIGNER	APPROVED	DATE

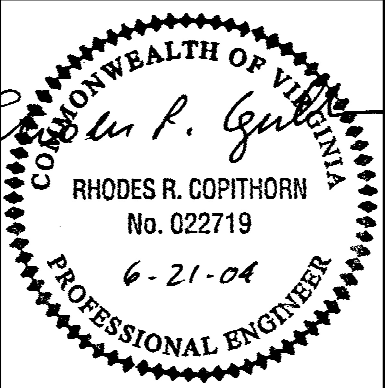

Stearns & Wheler, LLC
Environmental Engineers and Scientists


310 FIRST STREET, S.W., SUITE 150
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BEDFORD COUNTY PUBLIC SERVICE AUTHORITY

HIGH POINT WTP EXPANSION – PROJECT NO. 2003 – 028

YARD PIPING & SITE PLAN

JOB NO. 20280 DRAWING C-2 SHEET 7 OF 37

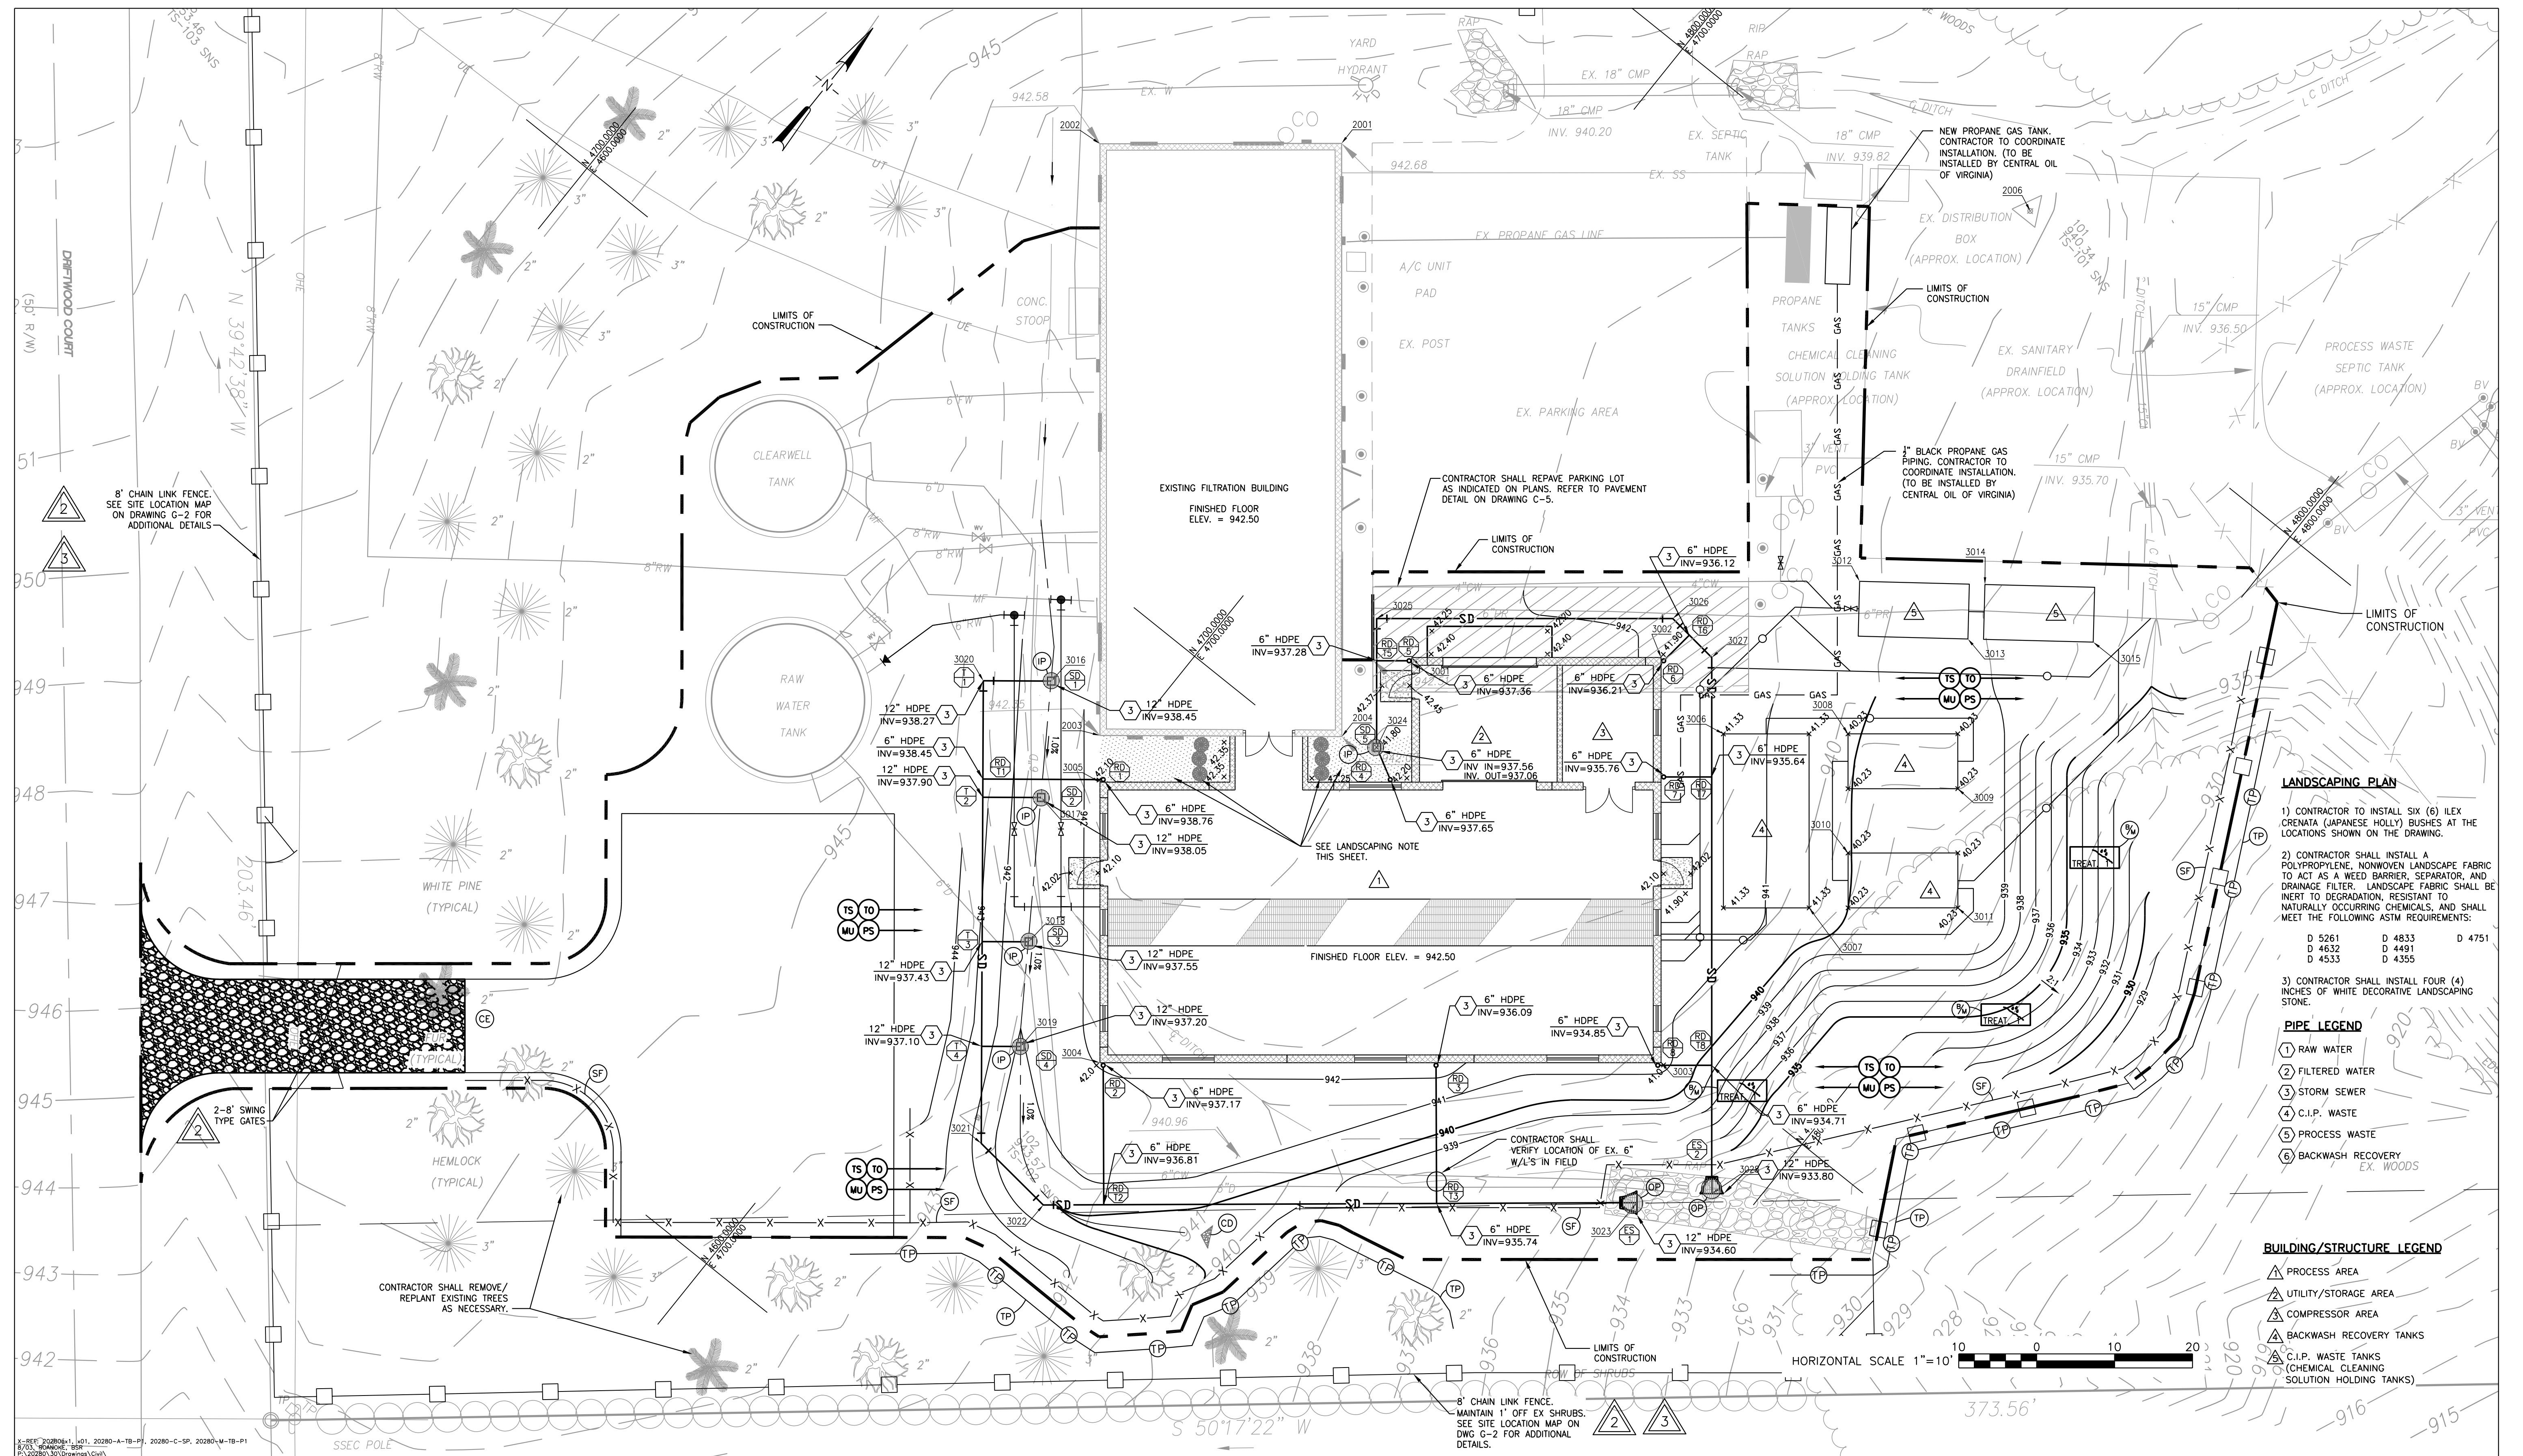


X-REF: 20280-x1, x01, 20280-A-TB-P1, 20280-C-SP, 20280-M-TB-P1
8/03, ROANOKE, BSR
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NOTES:

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3	REVISED PER OWNER COMMENTS				RRC	7/09/04							
	BSR	7/04	WPJ	CMT									
2	REVISED PER OWNER & VDH COMMENTS				RRC	6/21/04							
	BSR	6/04	WPJ	CMT									
1	FOR APPROVAL				RRC	1/23/04							
	BSR	11/03	WPJ	CMT									
ISSUE NO.	DRAWN	DATE	CHECKED	DESIGNER	APPROVED	DATE	4	ISSUED FOR CONSTRUCTION					
PROJECT SUPERVISOR					DEPARTMENT SUPERVISOR								
ISSUE NO.	DRAWN	DATE	CHECKED	DESIGNER	APPROVED	DATE							



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BEDFORD COUNTY PUBLIC SERVICE AUTHORITY

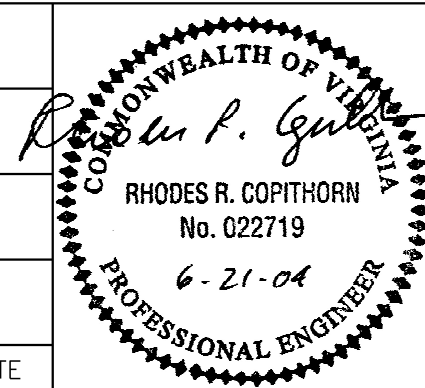HIGH POINT WTP EXPANSION – PROJECT NO. 2003 – 028

GRADING PLAN & SITE LAYOUT

JOB NO.	20280	DRAWING	C-3	SHEET	8 OF 37
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INLET CALCULATIONS

STORM DRAIN #1		Q(CFS)	K	EFFECTIVE OPENING	CLOGGING FACTOR	HT. (FEET)
WEIR:	H=	0.49	3.00	0.47	0.50	0.79
ORIFICE:	H=	0.49	0.60	2.88	0.50	0.01

NOTE:	WEIR HEADWATER COMPUTATION	$H = [Q/K(EFF. \text{ WEIR LENGTH})(CLOGGING \text{ FACTOR})]^{.6667}$
	ORIFICE HEADWATER COMPUTATION	$H = [Q/K(EFF. \text{ OPEN AREA})(CLOGGING \text{ FACTOR})(64.4)^{.5}]^{.2}$

STORM DRAIN #2		Q(CFS)	K	EFFECTIVE OPENING	CLOGGING FACTOR	HT. (FEET)
WEIR:	H=	0.06	3.00	0.47	0.50	0.19
ORIFICE:	H=	0.06	0.60	2.88	0.50	0.00

NOTE:	WEIR HEADWATER COMPUTATION	$H = [Q/K(\text{EFF. WEIR LENGTH})(\text{CLOGGING FACTOR})]^{.6667}$
	ORIFICE HEADWATER COMPUTATION	$H = [Q/K(\text{EFF. OPEN AREA})(\text{CLOGGING FACTOR})(64.4)^{.5}]^{.2}$

STORM DRAIN #3		Q(CFS)	K	EFFECTIVE OPENING	CLOGGING FACTOR	HT. (FEET)
WEIR:	H =	0.09	3.00	0.47	0.50	0.25
ORIFICE:	H =	0.09	0.60	2.88	0.50	0.00


NOTE:	WEIR HEADWATER COMPUTATION	$H = [Q/K(\text{EFF. WEIR LENGTH})(\text{CLOGGING FACTOR})]^{.6667}$
	ORIFICE HEADWATER COMPUTATION	$H = [Q/K(\text{EFF. OPEN AREA})(\text{CLOGGING FACTOR})(64.4)^{-0.5}]^2$

STORM DRAIN #4		Q(CFS)	K	EFFECTIVE OPENING	CLOGGING FACTOR	HT. (FEET)
WEIR:	H _{weir}	0.06	3.00	0.47	0.50	0.19
ORIFICE:	H _{orifice}	0.06	0.60	2.88	0.50	0.00



NOTE:	WEIR HEADWATER COMPUTATION	$H = [Q/K(\text{EFF. WEIR LENGTH})(\text{CLOGGING FACTOR})]^{.6667}$
	ORIFICE HEADWATER COMPUTATION	$H = [Q/K(\text{EFF. OPEN AREA})(\text{CLOGGING FACTOR})(64.4)^{.5}]^{.2}$

STORM DRAIN #5		Q(CFS)	K	EFFECTIVE OPENING	CLOGGING FACTOR	HT. (FEET)
WEIR:	H=	0.01	3.00	0.47	0.50	0.06
ORIFICE:	H=	0.01	0.60	2.88	0.50	0.00


NOTE:	WEIR HEADWATER COMPUTATION	$H = [Q/K(\text{EFF. WEIR LENGTH})(\text{CLOGGING FACTOR})]^{.6667}$
	ORIFICE HEADWATER COMPUTATION	$H = [Q/K(\text{EFF. OPEN AREA})(\text{CLOGGING FACTOR})(64.4)^{-0.5}]^2$

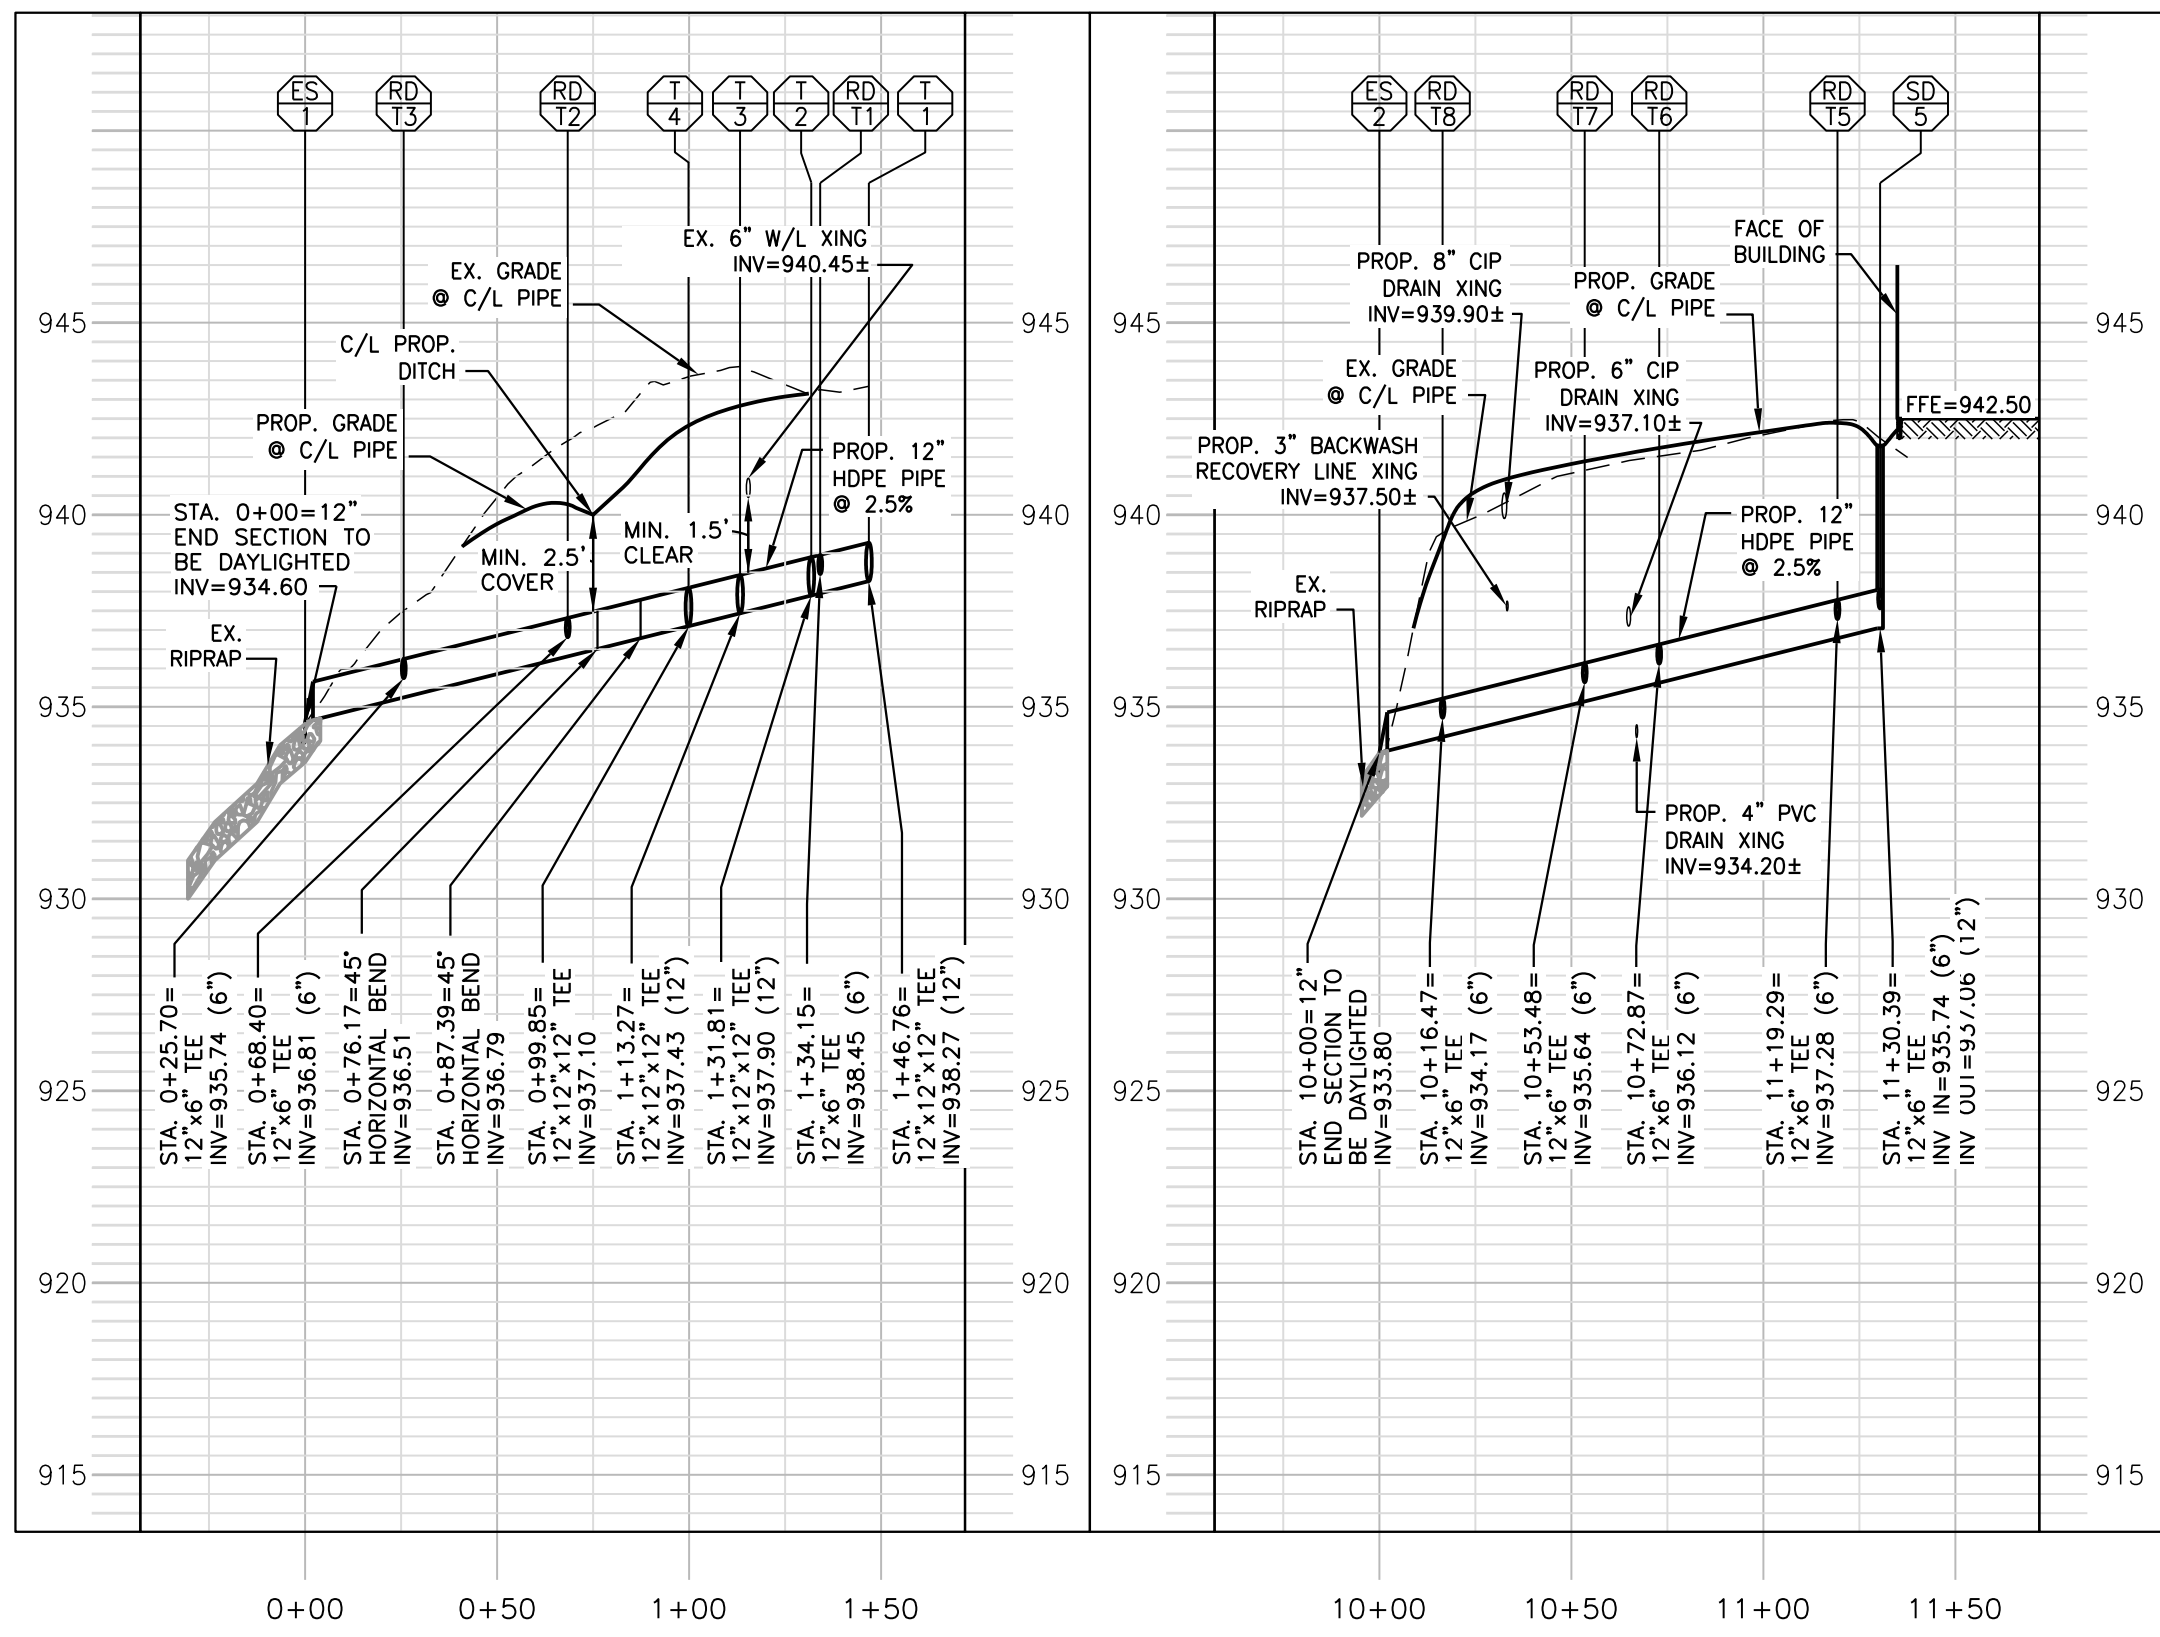


12" HDPE STORM DRAIN PROFILES
SCALE: HORIZ. 1"=50' VERT. 1"=5'

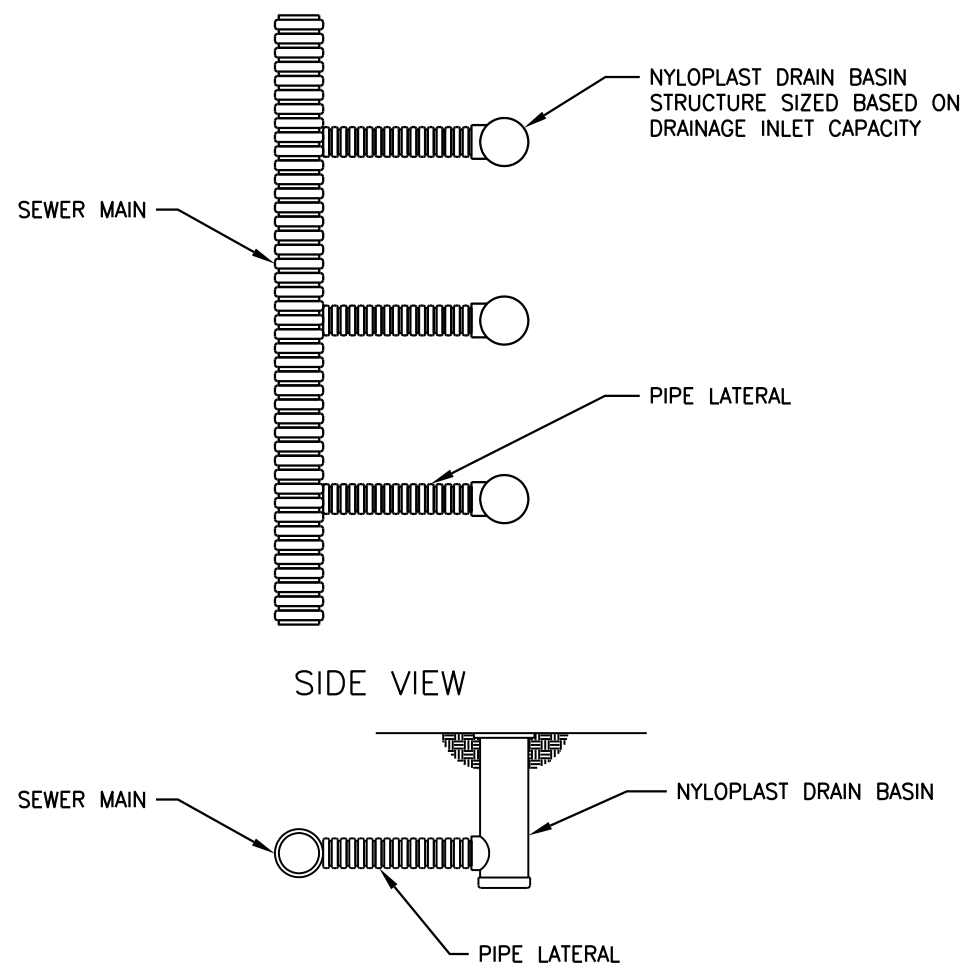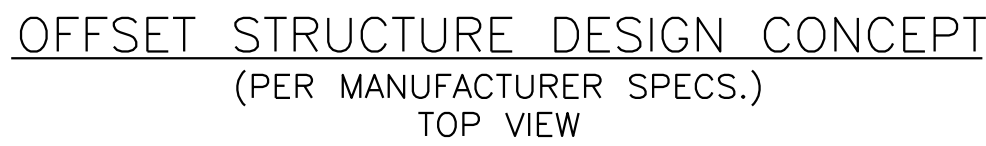

NOTE: THIS DETAIL IS FOR REFERENCE PURPOSES ONLY! REFER TO STORM SEWER PROFILE, COMPUTATIONS, AND MANUFACTURER SPECIFICATIONS FOR DETAILS.

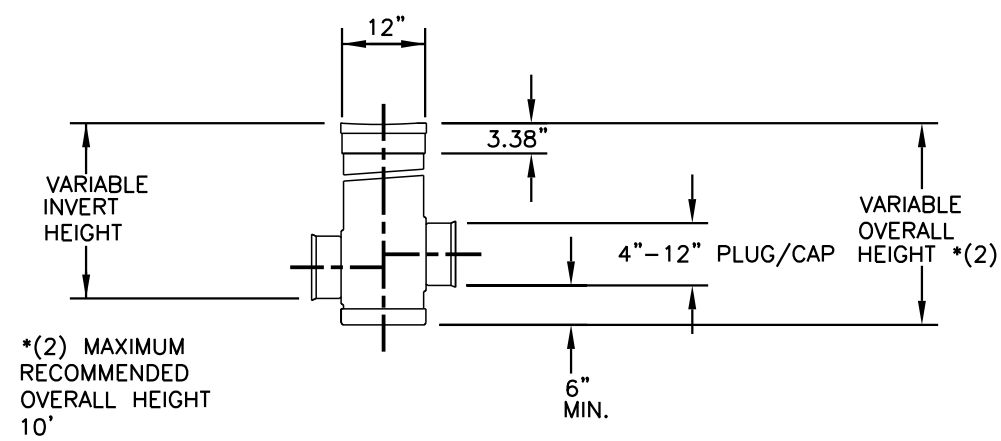

TYPICAL STORM DRAIN DETAIL
(PER MANUFACTURER SPECS.)
NOT TO SCALE

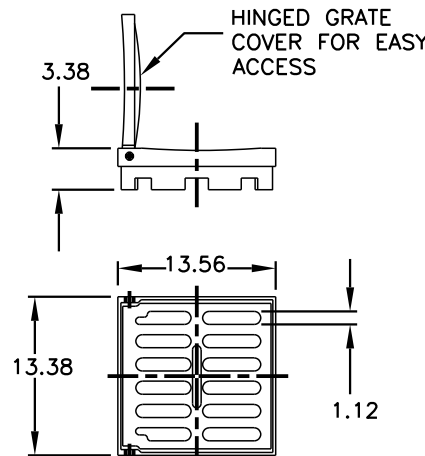

STANDARD
APPROX. DRAIN AREA = 60.62 SQ. IN.
APPROX. WEIGHT WITH FRAME = 40.68 LBS.

NYLOPLAST 12" GRATES/COVERS
STANDARD GRATE HAS H-25 HEAVY DUTY RATING
QUALITY: MATERIALS SHALL CONFORM TO ASTM
A536 GRADE 70-50-05 & A48-CLASS 30B
MATERIAL: DUCTILE IRON GRADE W/CAST IRON FRAME
PAINT: CASTINGS ARE FURNISHED WITH A BLACK PAINT
LOCKING DEVICE AVAILABLE UPON REQUEST
PRICE INCLUDES FRAME & GRATE/COVER


TYPICAL STORM DRAIN DETAIL
(PER MANUFACTURER SPECS.)
NOT TO SCALE

FROM POINT	TO POINT	DRAIN.	RUNOFF	CA		INLET TIME	RAINFALL INTENSITY	Q (RUNOFF)	Q (RUNOFF)	INVERT		LENGTH	SLOPE	DIA.	n	CAPACITY	VELOCITY	FLOW	REMARKS
		AREA	COEFF.	INCRM.	ACCU.			INCRM.	ACCU.	UPPER	LOWER					C.F.S.	F.P.S.	SEC.	
		ACRES	C																
SD1	T1	0.170	0.40	0.068	0.068	5.0	7.25	0.493	0.493	938.45	938.27	8.75	0.0200	12	0.012	5.46	4.27	2.05	
RD1	RD/T1	0.012	0.90	0.011	0.079	5.0	7.25	0.078	0.571	938.76	938.45	15.44	0.0200	6	0.010	1.03	3.03	5.09	
SD2	T2	0.020	0.40	0.008	0.087	5.0	7.25	0.058	0.629	938.05	937.90	7.51	0.0200	12	0.012	5.46	2.01	3.74	
SD3	T3	0.030	0.40	0.012	0.099	5.0	7.25	0.087	0.716	937.55	937.43	5.97	0.0200	12	0.012	5.46	2.42	2.47	
SD4	T4	0.020	0.40	0.008	0.107	5.0	7.25	0.058	0.774	937.20	937.10	5.00	0.0200	12	0.012	5.46	2.01	2.49	
RD2	RD/T2	0.012	0.90	0.011	0.118	5.0	7.25	0.079	0.853	937.17	936.81	17.90	0.0200	6	0.010	1.03	3.03	5.90	
RD3	RD/T3	0.012	0.90	0.011	0.129	5.0	7.25	0.079	0.932	936.09	935.74	17.73	0.0200	6	0.010	1.03	3.03	5.84	
T1	ES1	0.276	0.55	0.152	0.152	5.0	7.25	1.101	1.101	938.27	934.60	146.76	0.0250	12	0.012	6.10	5.80	25.28	
RD4	SD5	0.016	0.90	0.014	0.014	5.0	7.25	0.101	0.101	937.65	937.56	4.49	0.0200	6	0.010	1.03	3.23	1.39	
RD5	RD/T5	0.007	0.90	0.006	0.020	5.0	7.25	0.044	0.145	937.36	937.28	4.16	0.0200	6	0.010	1.03	2.60	1.60	
RD6	RD/T6	0.007	0.90	0.006	0.026	5.0	7.25	0.044	0.189	936.21	936.12	4.66	0.0200	6	0.010	1.03	2.60	1.79	
RD7	RD/T7	0.009	0.90	0.008	0.034	5.0	7.25	0.057	0.245	935.76	935.64	6.17	0.0200	6	0.010	1.03	2.60	2.37	
RD8	RD/T8	0.012	0.90	0.011	0.045	5.0	7.25	0.079	0.324	934.85	934.71	6.92	0.0200	6	0.010	1.03	3.03	2.28	
SD5	ES2	0.003	0.50	0.002	0.046	5.0	7.25	0.011	0.335	937.06	933.80	130.39	0.0250	12	0.012	6.10	1.09	119.18	

X-REF: 20280x1, 20280-PROFILES
8/03, ROANOKE, BSR
P:\20280\30\Drawings\Civil\

NOTES:

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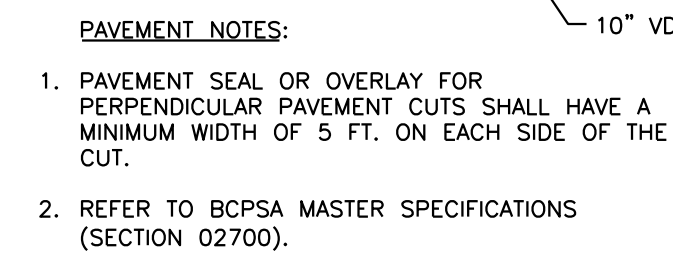
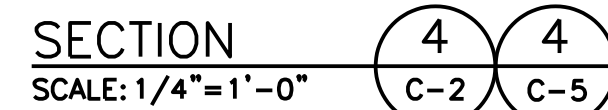
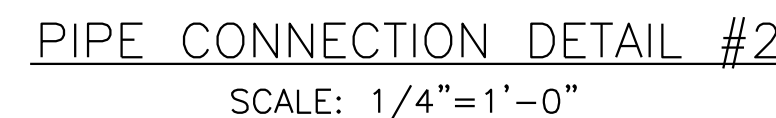
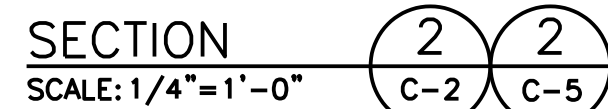
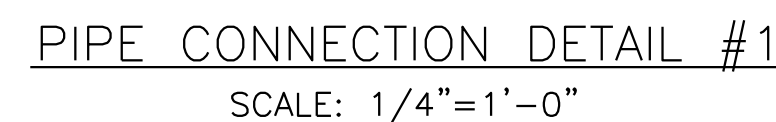
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Stearns & Wheler, LLC

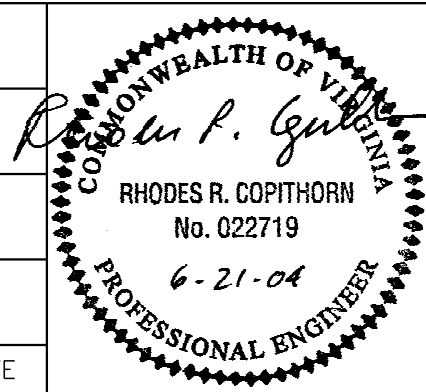Environmental Engineers and Scientists

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BEDFORD COUNTY PUBLIC SERVICE AUTHORITY			
HIGH POINT WTP EXPANSION – PROJECT NO. 2003 – 028			
YARD PIPING, STORM DRAIN DETAILS & CALCULATIONS			
JOB NO.	20280	DRAWING	C-4
		SHEET	9 OF 37




PAVEMENT DETAIL
(SEE GRADING PLAN FOR APPLICABLE
PAVEMENT AREAS)
N.T.S.

- 1 RAW WATER
- 2 FILTERED WATER
- 3 STORM SEWER
- 4 C.I.P. WASTE
- 5 PROCESS WASTE
- 6 BACKWASH RECOVERY

- 1 REDUCER
- 2 TEE
- 3 90° ELBOW
- 4 45° ELBOW
- 5 22.5° ELBOW
- 6 11.25° ELBOW
- 7 WYE CONNECTION
- 8 TEE W/ BLIND FLANGE

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1	FOR APPROVAL				RRC	1/23/04							
	BSR	11/03	WPJ	CMT									
ISSUE NO.	DRAWN	DATE	CHECKED	DESIGNER	APPROVED	DATE							
PROJECT SUPERVISOR					DEPARTMENT SUPERVISOR								
							ISSUE NO.	DRAWN	DATE	CHECKED	DESIGNER	APPROVED	DATE

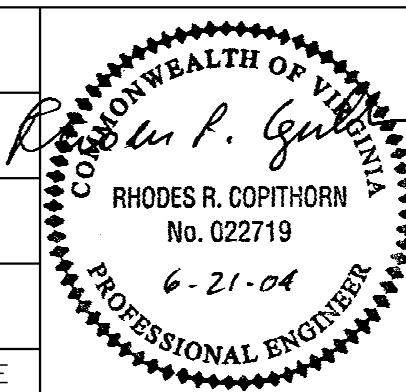


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HIGH POINT WTP EXPANSION – PROJECT NO. 2003 – 028

YARD PIPING CROSS SECTIONS & MISCELLANEOUS DETAILS


JOB NO.	20280	DRAWING	C-5	SHEET	10 OF 37
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WEST ELEVATION
SCALE: 1/8"=1'-0"


SOUTH ELEVATION
SCALE: 1/8"=1'-0"

FLOOR PLAN
SCALE: 1/8"=1'-0"

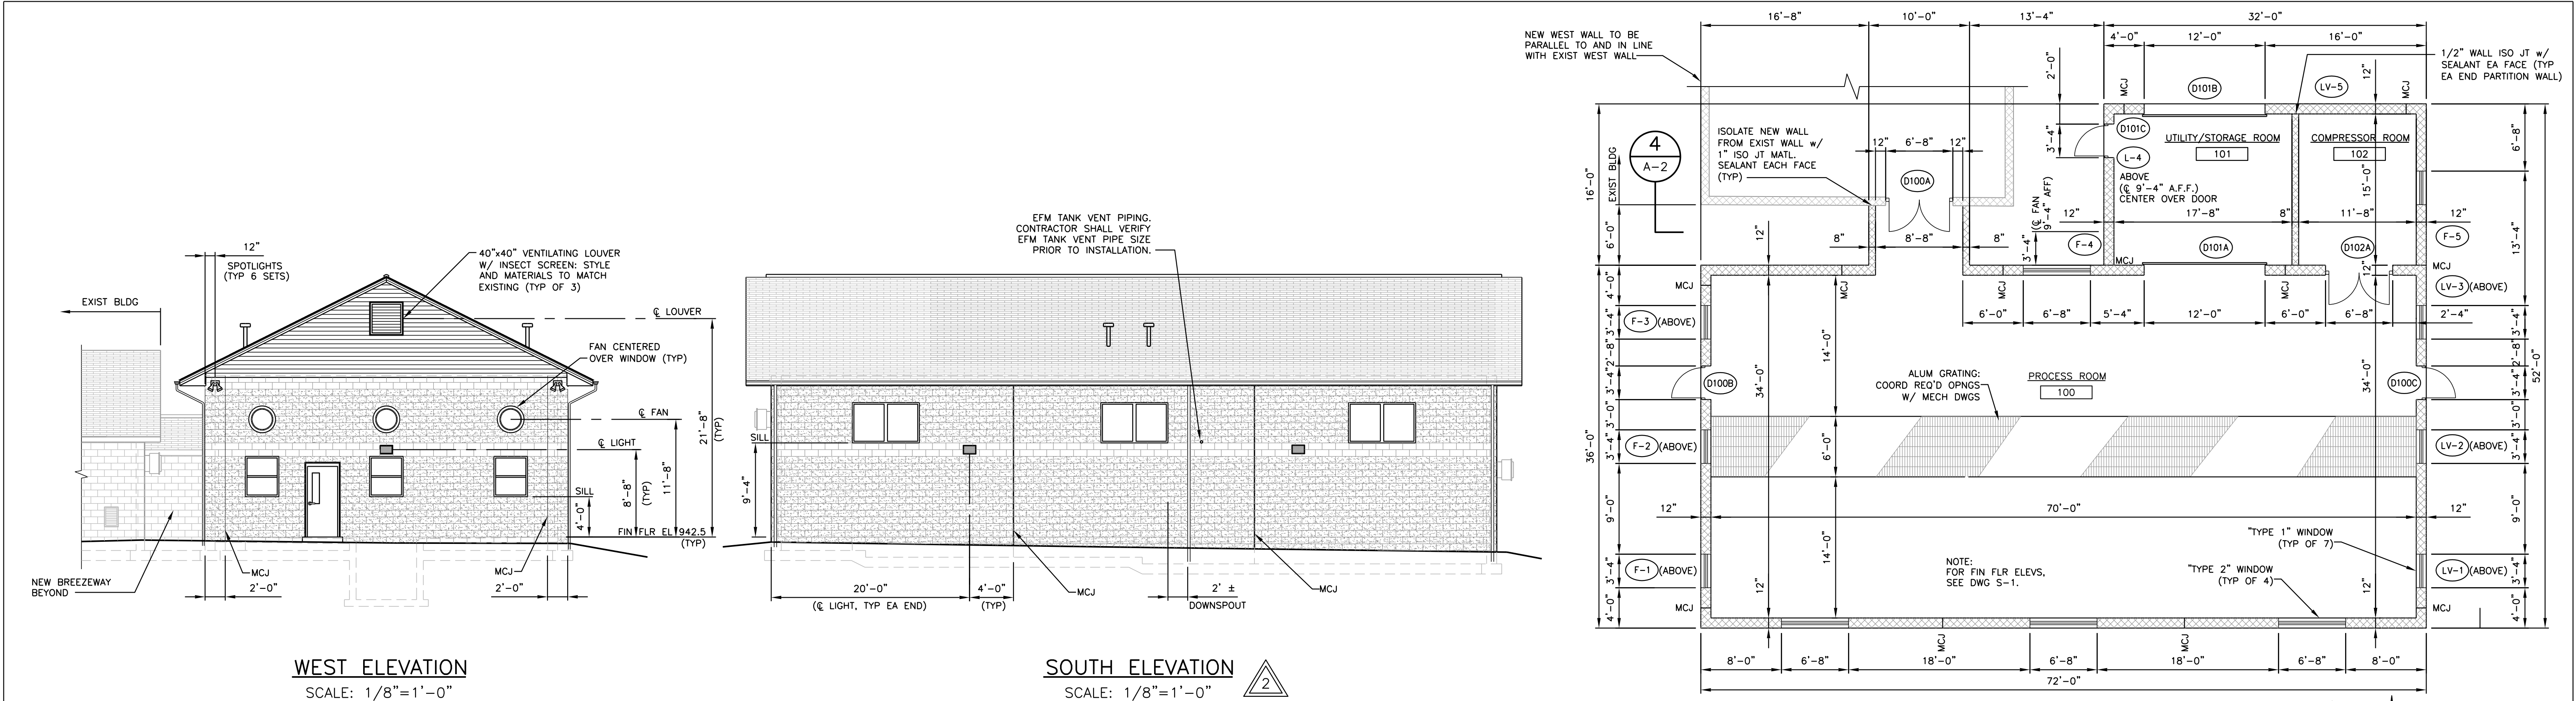

EAST ELEVATION
SCALE: 1/8"=1'-0"

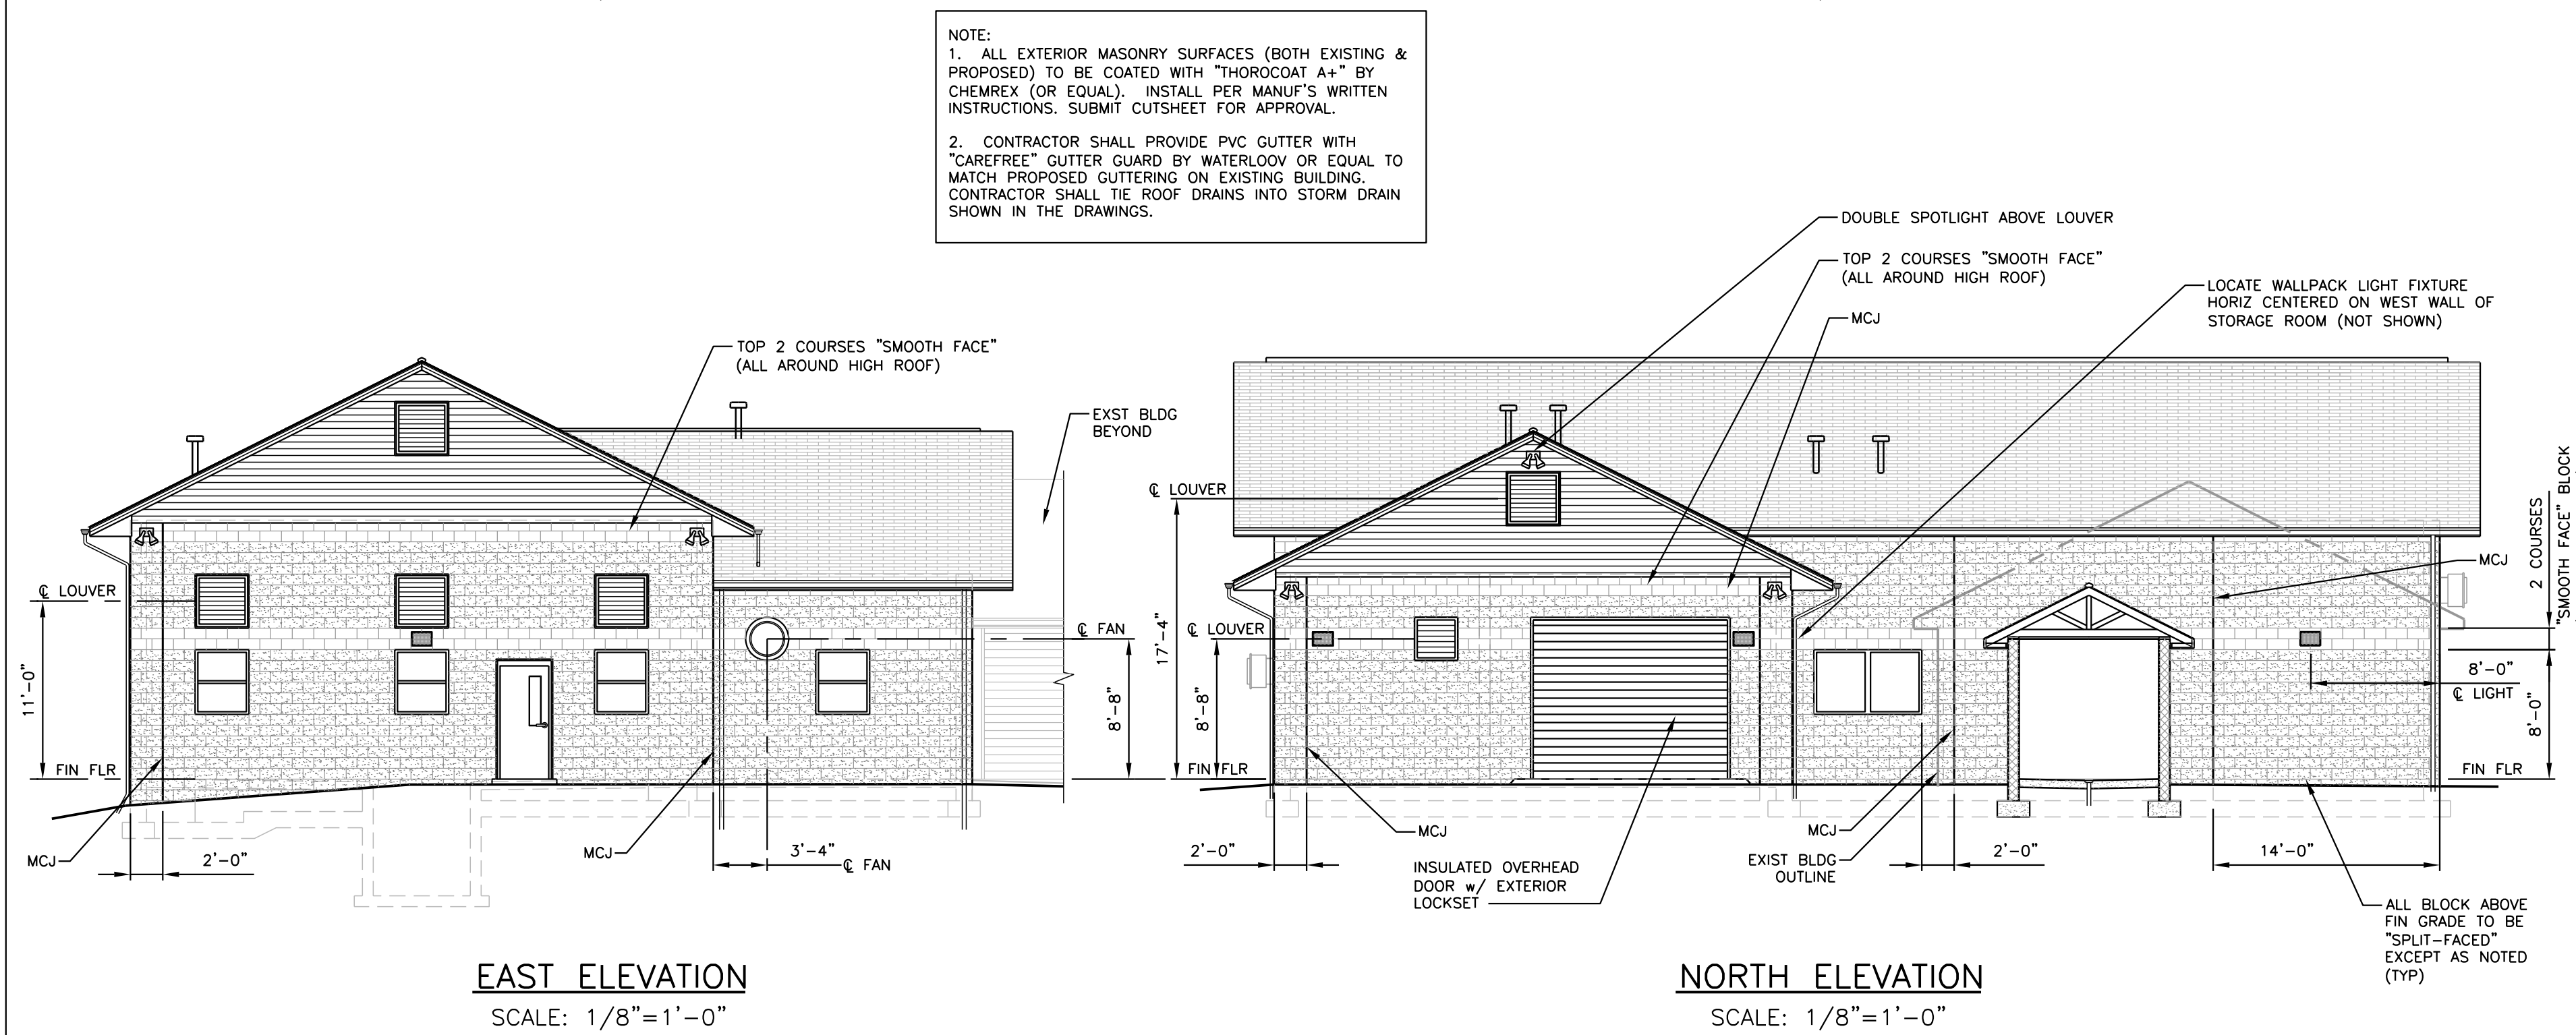
NORTH ELEVATION
SCALE: 1/8"=1'-0"

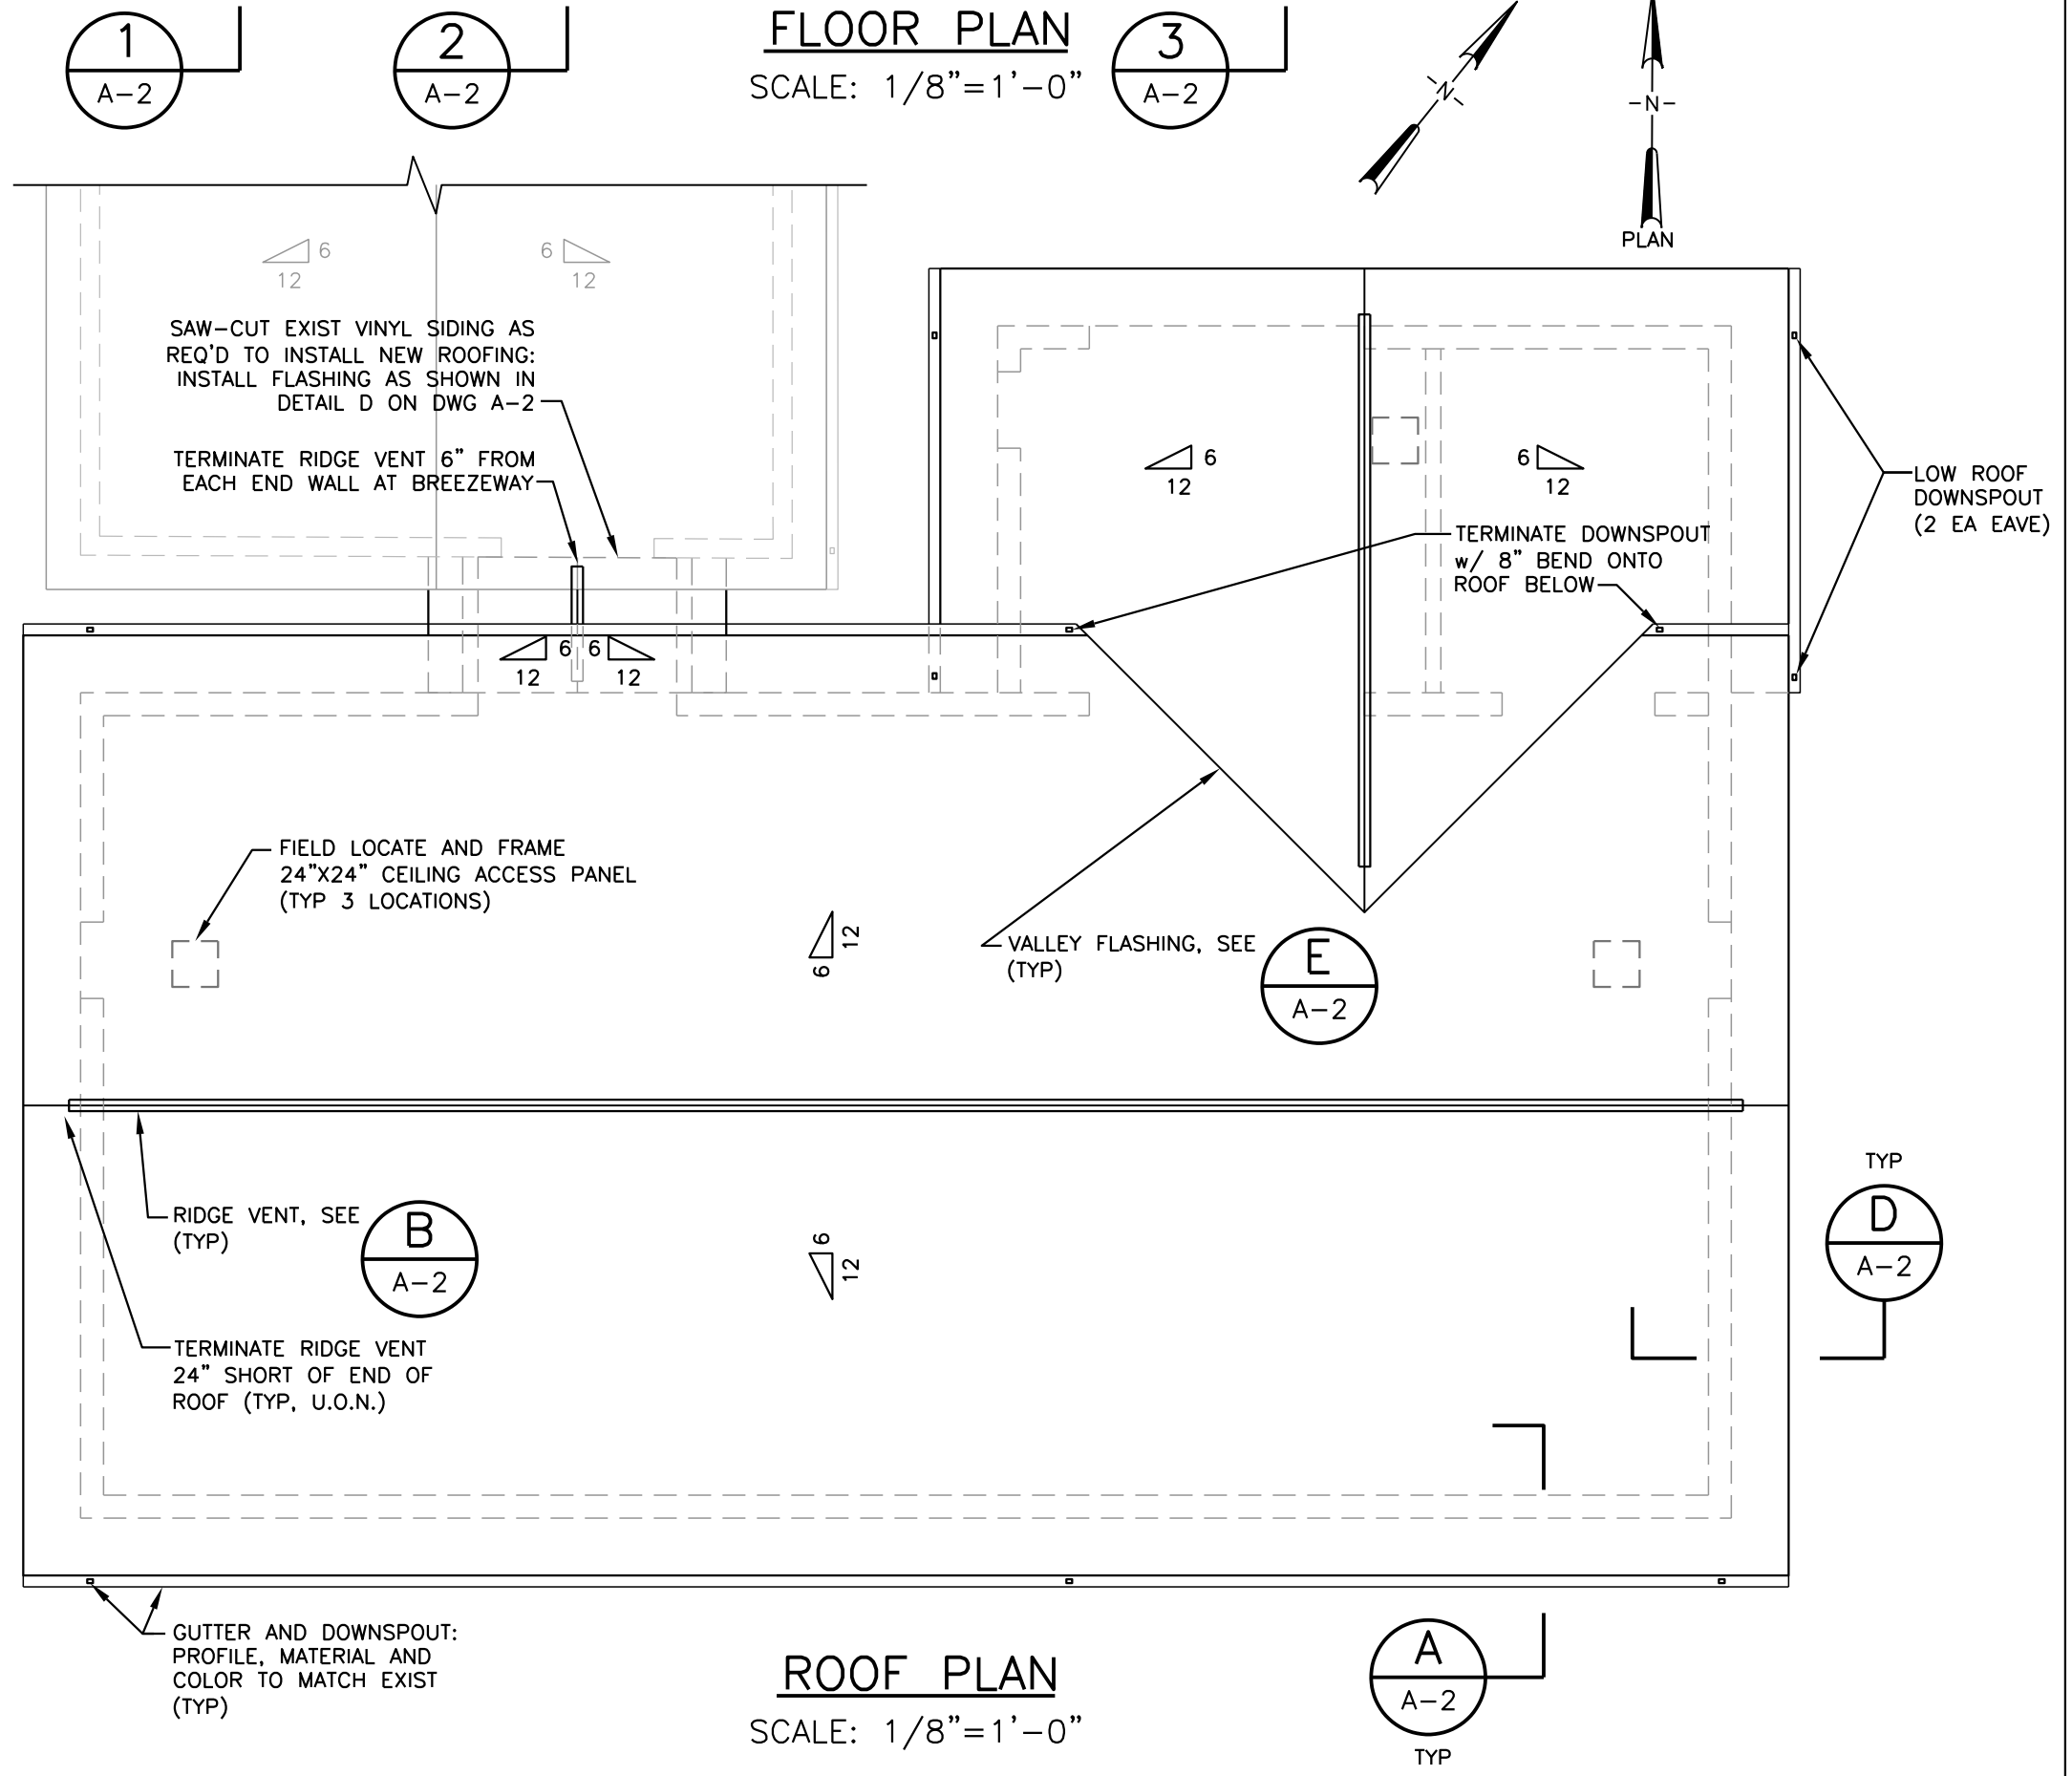

ROOF PLAN
SCALE: 1/8"=1'-0"






NOTES:
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3	ISSUED FOR CONSTRUCTION				RRC	6/21/04						
2	REVISED PER OWNER & VDH COMMENTS				RRC	6/21/04						
	SHA	6/04	WPJ	SHA								
1	FOR APPROVAL				RRC	1/23/04						
	SHA	11/03	WPJ	SHA								
ISSUE NO.	DRAWN	DATE	CHECKED	DESIGNER	APPROVED	DATE						
PROJECT SUPERVISOR					DEPARTMENT SUPERVISOR							
ISSUE NO.	DRAWN	DATE	CHECKED	DESIGNER	APPROVED	DATE						

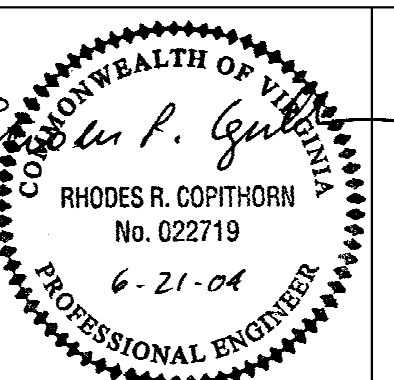


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Environmental Engineers and Scientists
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ROANOKE, VIRGINIA 24011
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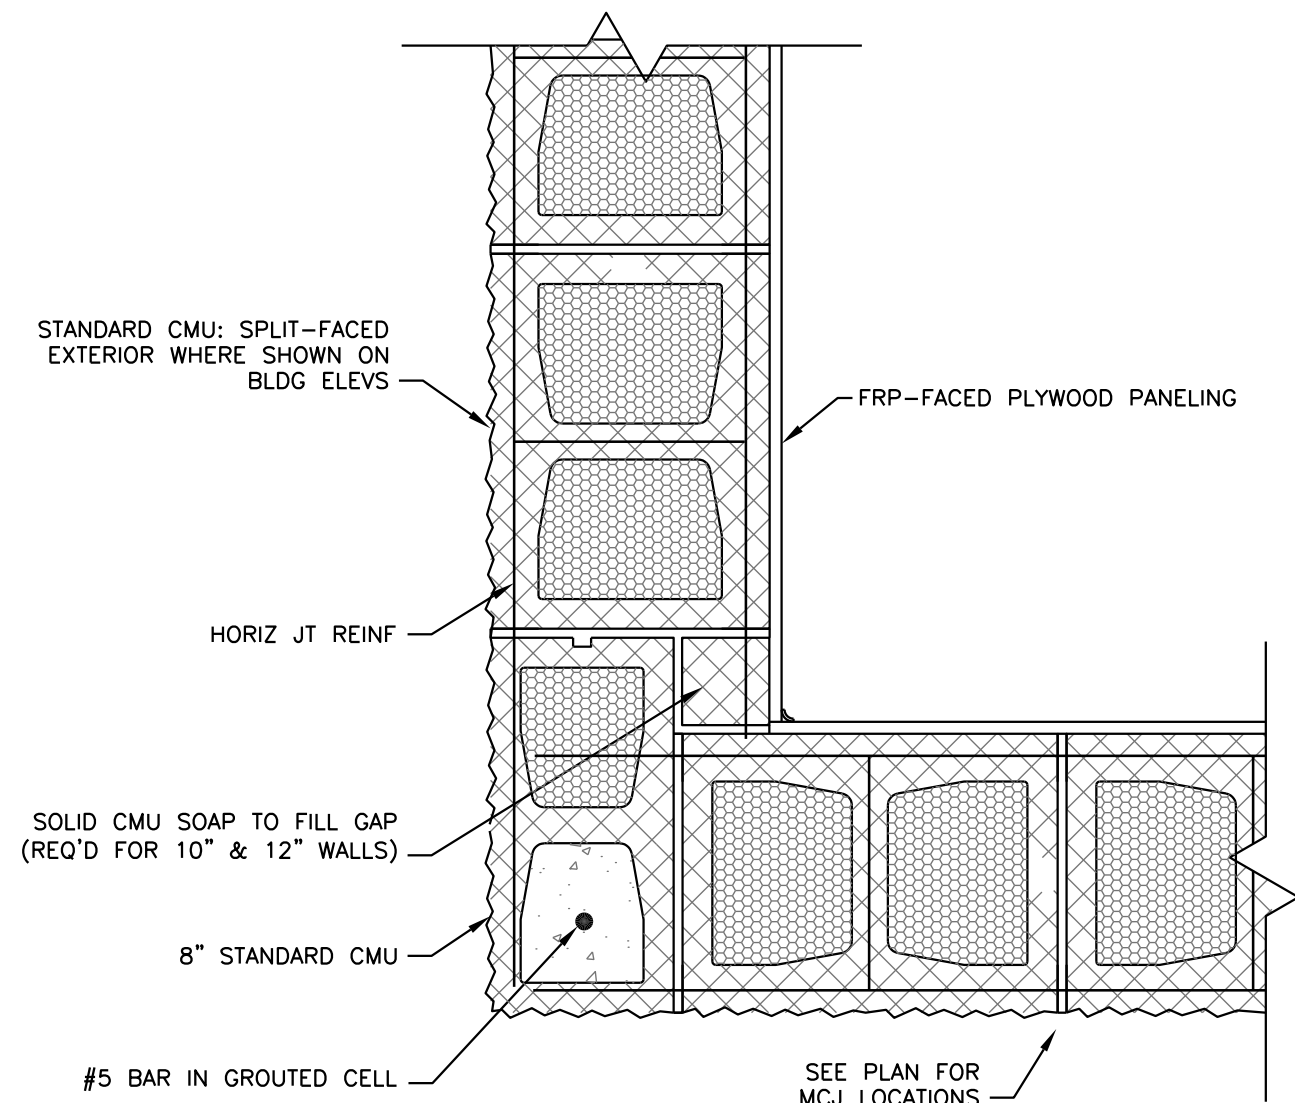
BEDFORD COUNTY PUBLIC SERVICE AUTHORITY			
HIGH POINT WTP EXPANSION - PROJECT NO. 2003 - 028			
PLANS & ELEVATIONS			
JOB NO.	20280	DRAWING	A-1
SHEET	11	OF	37




BEDFORD COUNTY PUBLIC SERVICE AUTHORITY		
HIGH POINT WTP EXPANSION -- PROJECT NO. 2003 -- 028		
WALL SECTIONS		
JOB NO. 20280	DRAWING A-2	SHEET 12 OF 37

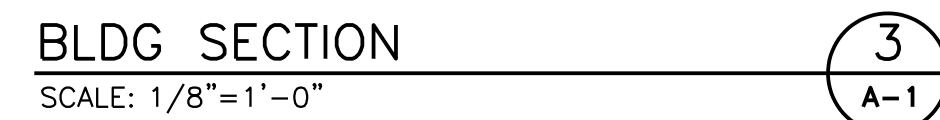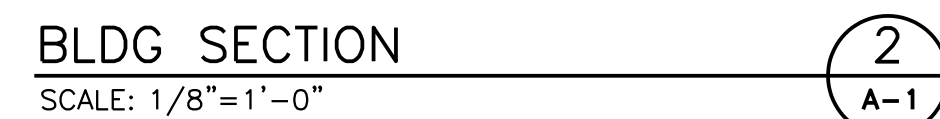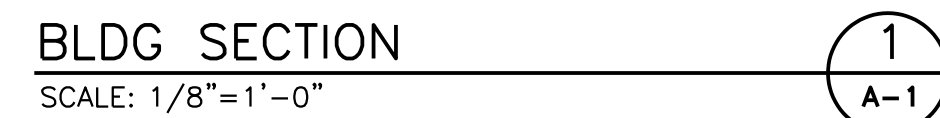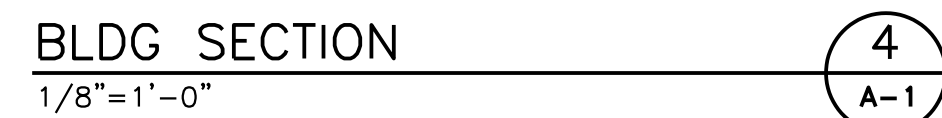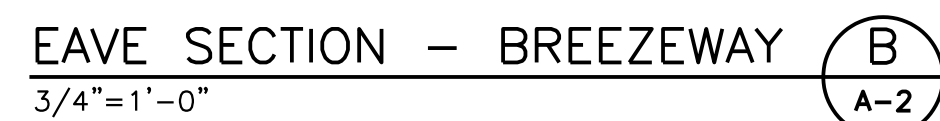

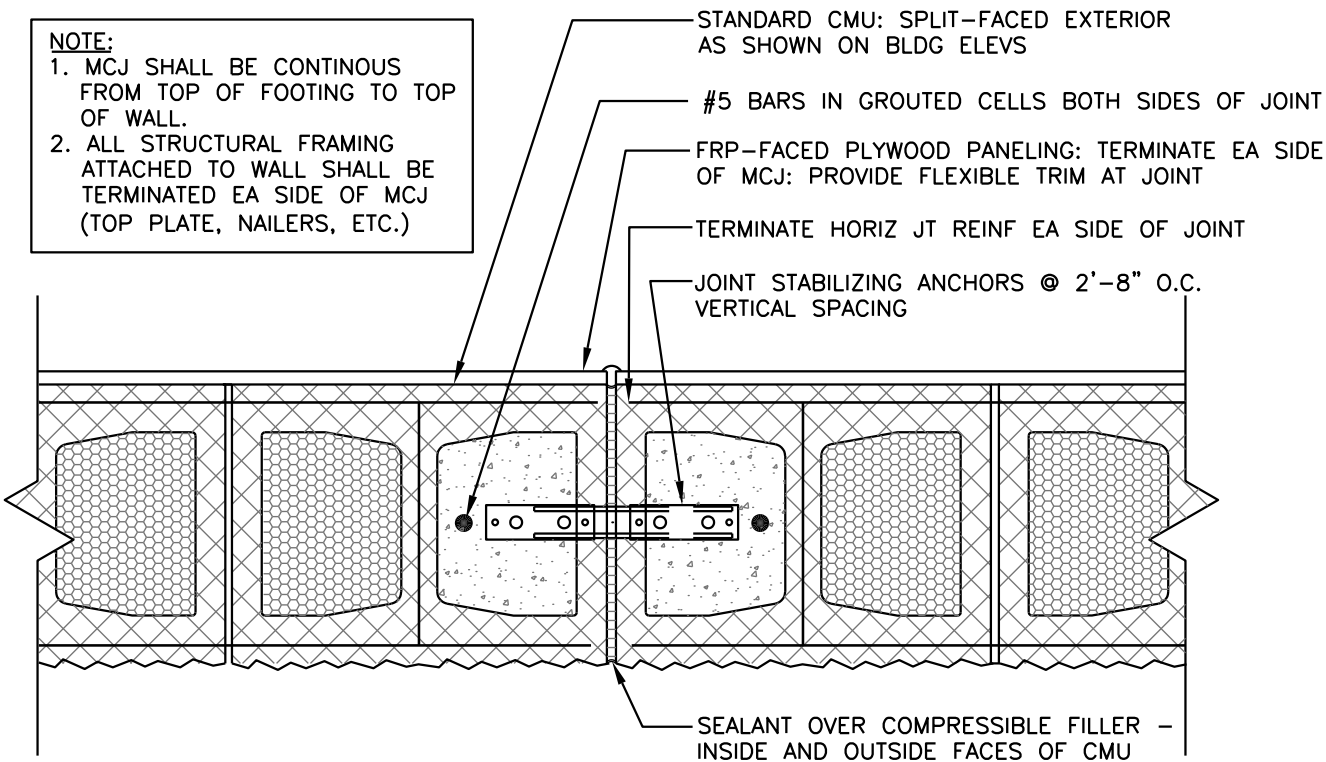CONTROL JOINT DETAIL — INSULATED CMU WALL
NOT TO SCALE




CORNER DETAILS — INSULATED CMU WALL
NOT TO SCALE

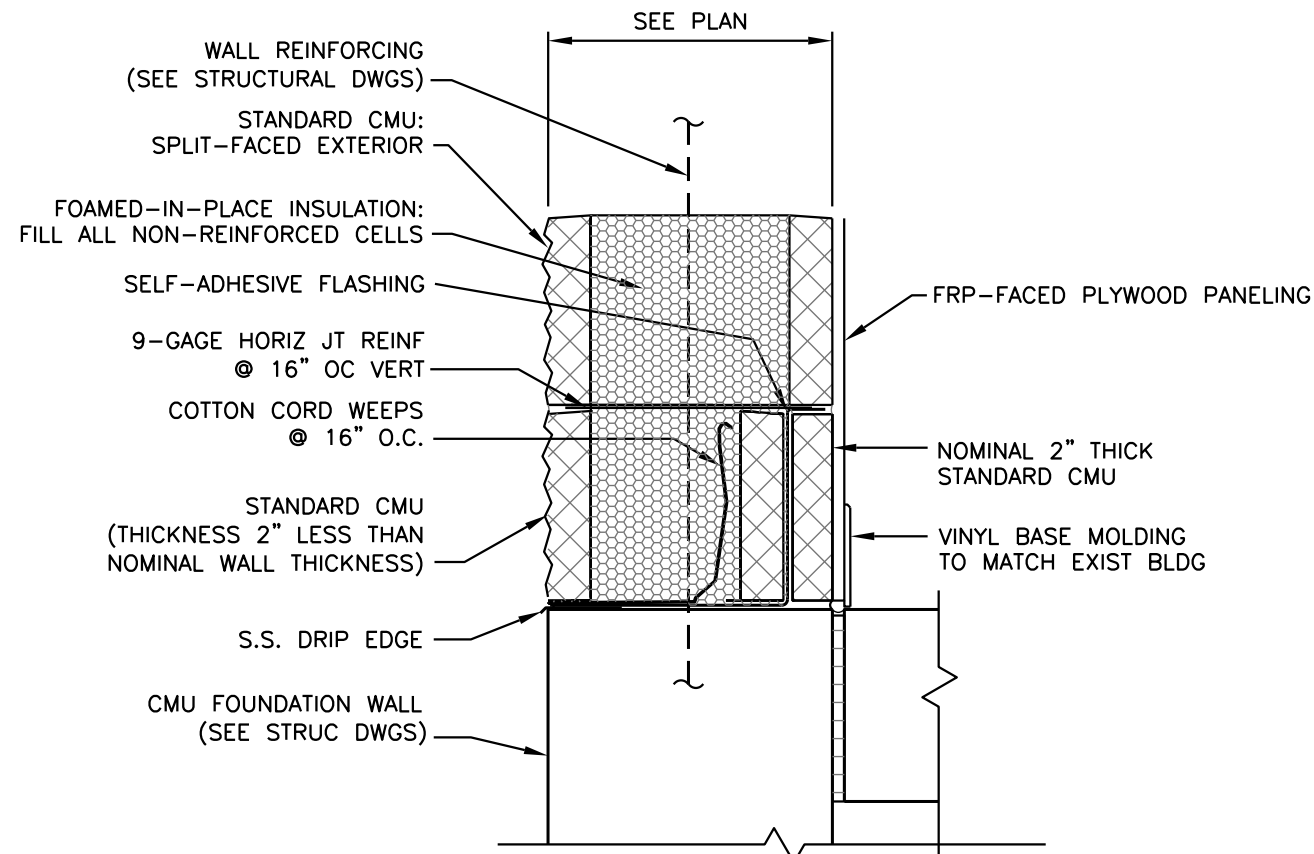


WALL BASE DETAILS — INSULATED CMU WALL
NOT TO SCALE

DOOR AND FRAME SCHEDULE													
DOOR						FRAME					HARDWARE		PAINT
DOOR No.	MATERIAL	TYPE	SIZE			MATERIAL	ELEV.	DETAILS			SET No.	KEYSIDE	
			WIDTH	HEIGHT	THICK.			HEAD	JAMB	SILL			
D100A	FRP	B	6'-4"	7'-2"	MANF.	FRP	B	H4	J4	S4	MANF.	EXIST RM	FAF
D100B	FRP	A	3'-0"	7'-2"	1 3/4"	FRP	A	H1	J1	S1	1	EXTERIOR	FAF
D100C	FRP	A	3'-0"	7'-2"	1 3/4"	FRP	A	H1	J1	S1	1	EXTERIOR	FAF
D101A	ALUM	C	12'-0"	10'-0"	MANF.	MANF.	-	H2	J2	S2	MANF.	EXTERIOR	FAF
D101B	ALUM	C	12'-0"	10'-0"	MANF.	MANF.	-	H2	J2	S2	MANF.	EXTERIOR	FAF
D101C	FRP	A	3'-0"	7'-2"	1 3/4"	FRP	A	H1	J1	S1	1	EXTERIOR	FAF
D102A	FRP	B	6'-4"	7'-2"	MANF.	FRP	B	H1	J1	-	1	RM 100	FAF


- = NOT REQUIRED
X = REQUIRED
FAF = FACTORY APPLIED FINISH
MANF. = AS SUPPLIED BY MANUFACTURER AND IN CONFORMANCE WITH SPECIFICATIONS
NOTE: NEW LOCKSETS TO MATCH EXISTING. COORD W/ OWNER FOR REQ'D KEYING.

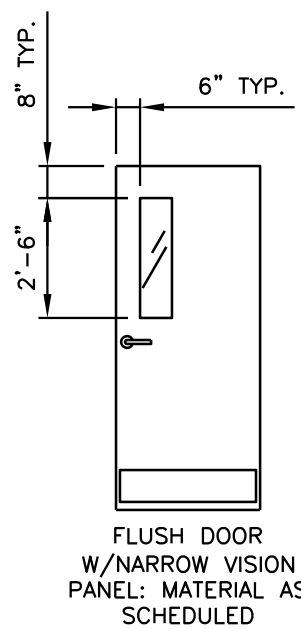


(A)

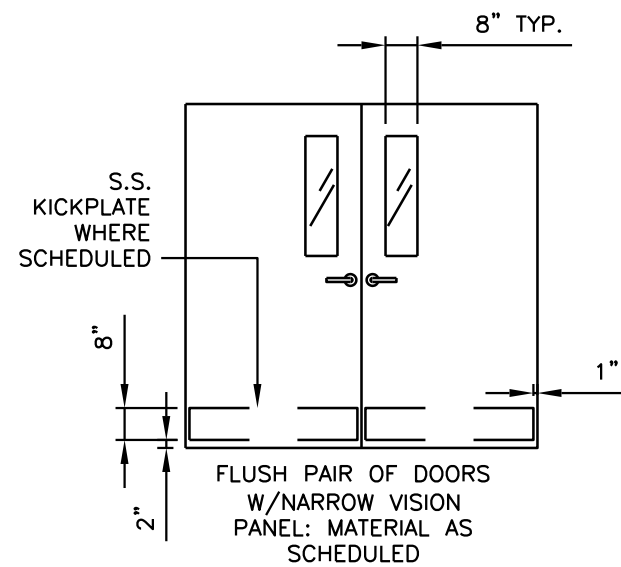


(B)

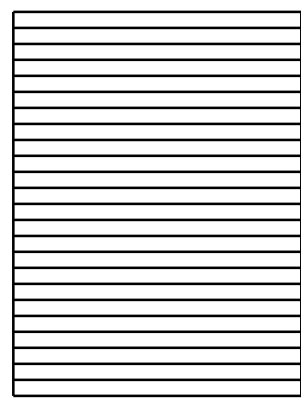

(C)

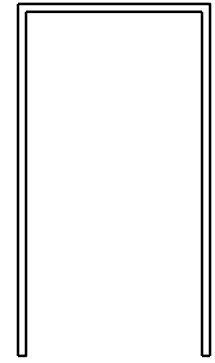


(A)

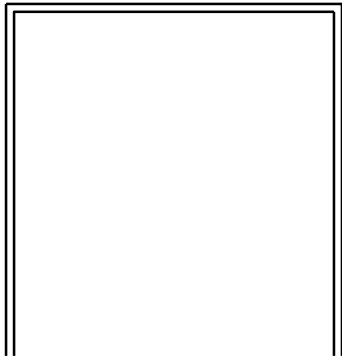


(B)

DOOR TYPES
NOT TO SCALE

DOOR FRAME TYPES
NOT TO SCALE

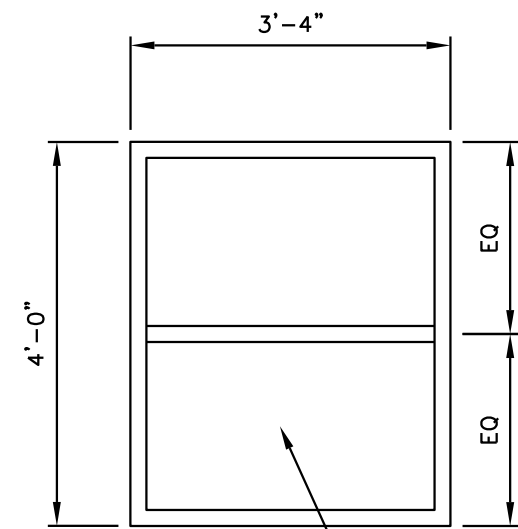

TYPE 1

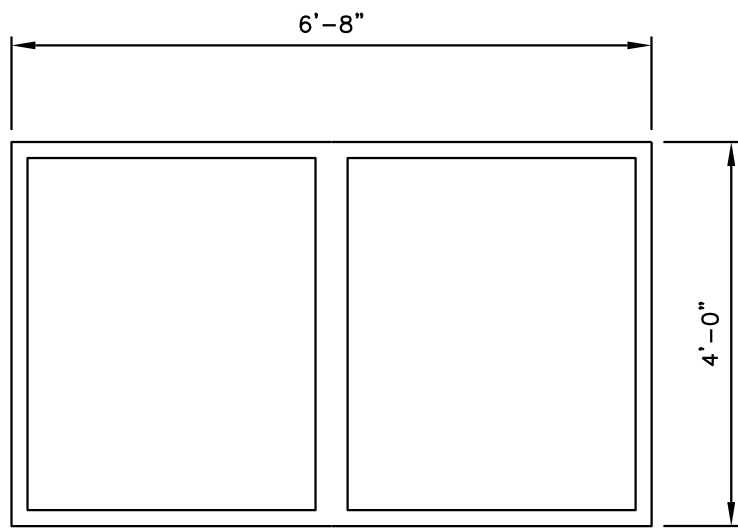

TYPE 2

DOUBLE THERMAL PANE
FILLED w/ ARGON GAS (TYP)

WINDOW TYPES
1/4" = 1'-0"


- NOTE:
- SEE BLEG ELEVS AND PLANS FOR REQ'D LOCATIONS, DWG A-1.
 - WINDOW STYLES, MATERIALS AND CONSTRUCTION TO MATCH EXISTING WINDOWS.
 - DOUBLE WINDOWS ON NORTH AND SOUTH SIDE OF BUILDING SHOWN IN THESE PLANS SHALL BE FIXED WINDOWS AND SHALL MATCH EXISTING WINDOWS.

X-REF: 20280a1
8/03, ROANOKE, BSR
P:\20280\30\Drawings\Arch

NOTES:

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ISSUE NO.	SHA	DATE	CHECKED	DESIGNER	APPROVED	DATE													
PROJECT SUPERVISOR					DEPARTMENT SUPERVISOR					ISSUE NO.	DRAWN	DATE	CHECKED	DESIGNER	APPROVED	DATE			

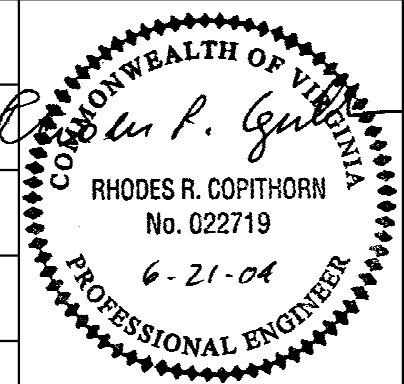

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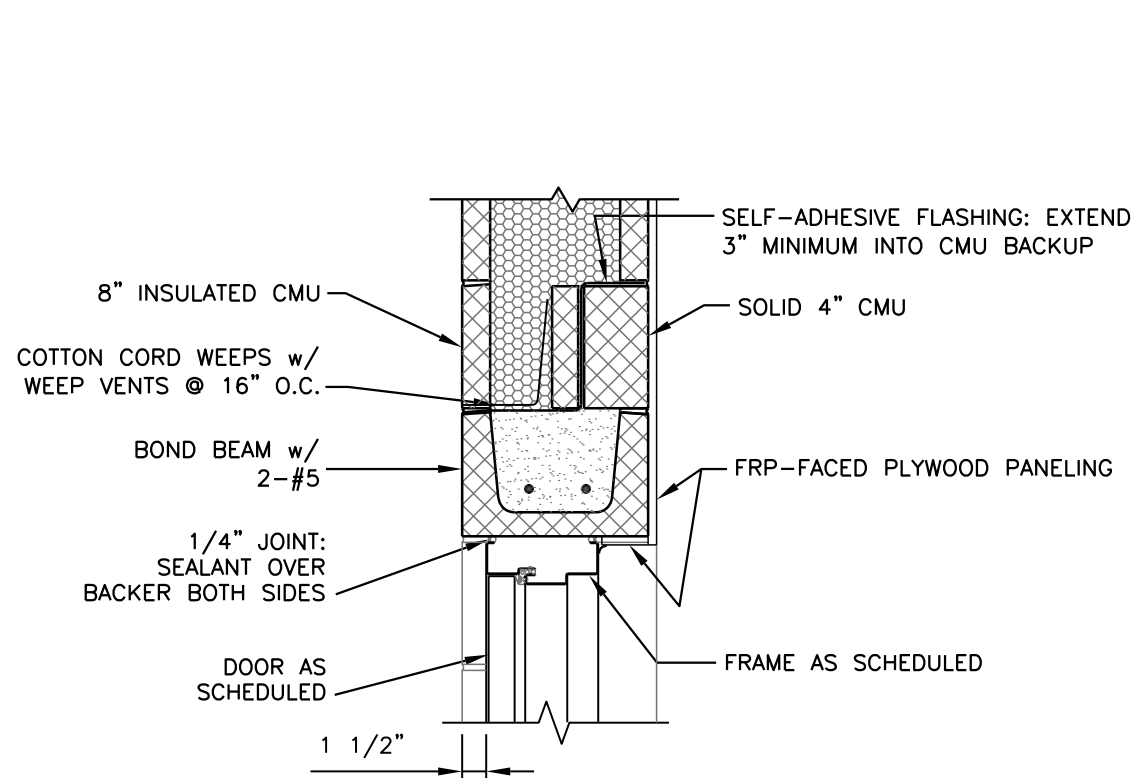
HIGH POINT WTP EXPANSION — PROJECT NO. 2003 — 028

DETAILS & SCHEDULES

JOB NO. 20280 DRAWING A-3 SHEET 13 OF 37

GENERAL HEAD/SILL/JAMB NOTES:


1. ALL NEW EXPOSED WALL AND CEILING SURFACES (INCLUDING RETURNS AROUND DOORS, WINDOWS AND LOUVERS) TO BE COVERED WITH FRP-FACED PLYWOOD WHETHER SHOWN OR NOT. INSTALL VINYL TRIM AT JOINTS TO MATCH EXISTING.
2. SEE BLDG ELEVATIONS ON DWG A-1 FOR LOCATIONS WHERE "SPLIT-FACED" OR "SMOOTH FACED" CMU SHALL BE INSTALLED.
3. FIELD VERIFY EXISTING DIMENSIONS BEFORE FABRICATION OF ANY COMPONENTS THAT ARE TO BE INSTALLED IN OR ON EXISTING CONSTRUCTION. CONSULT WITH ENGINEER OF RECORD IF FIELD CONDITIONS DIFFER FROM WHAT IS SHOWN.
4. DETAILS AT WINDOWS TO BE SIMILAR TO DETAILS AT LOUVERS.



HEAD

SCALE: 1"=1'-0"


H1

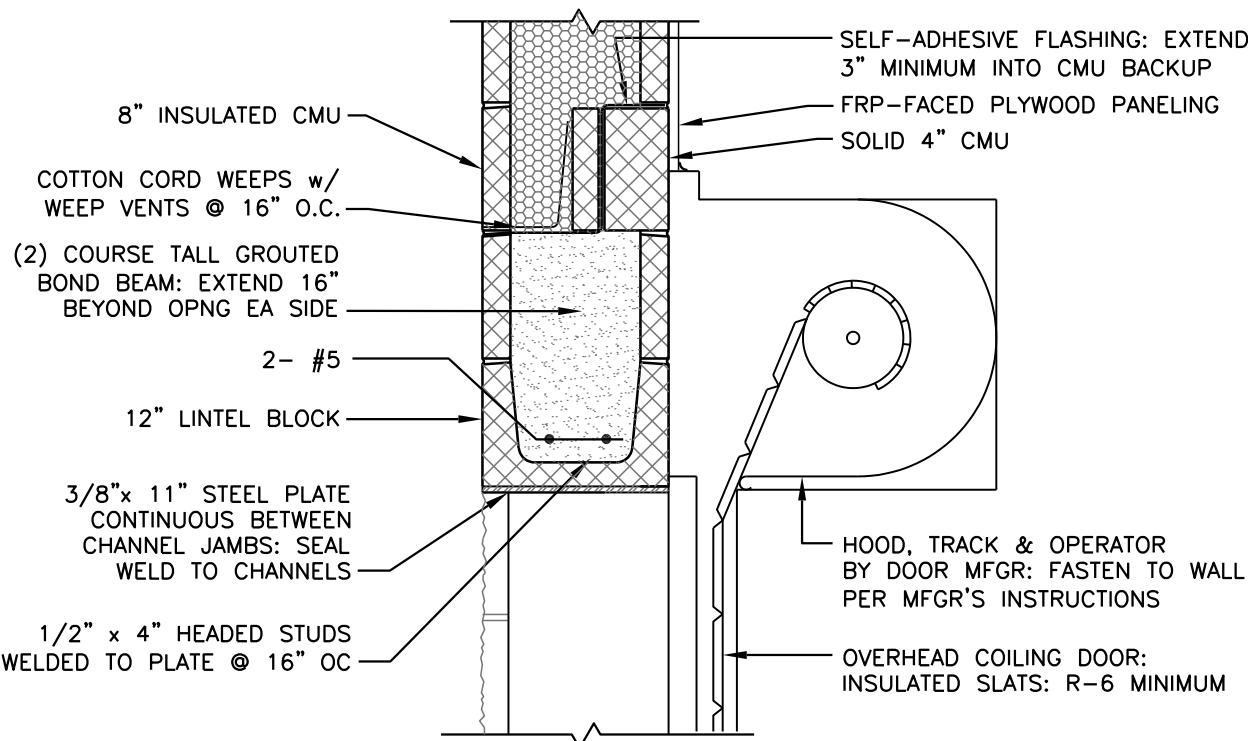

HEAD

SCALE: 1"=1'-0"


H2

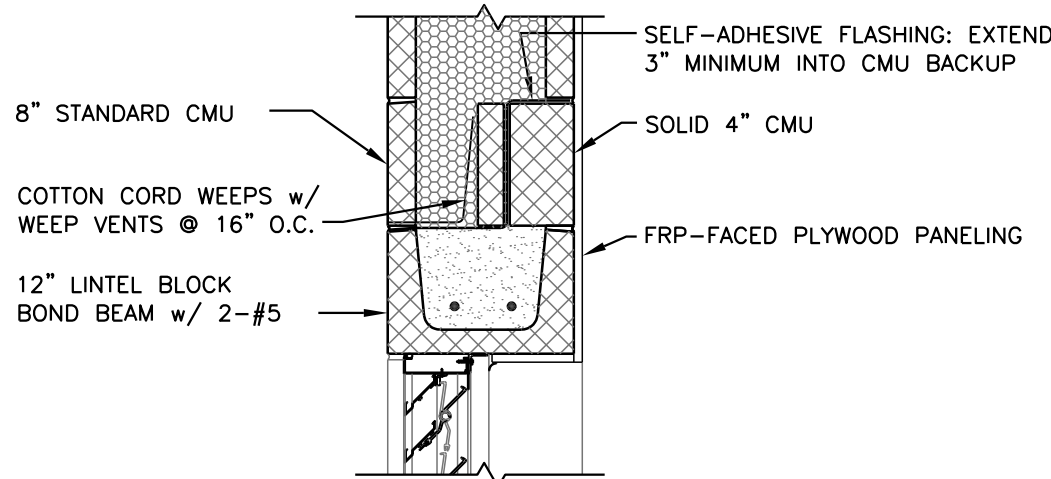

HEAD

SCALE: 1"=1'-0"


H3

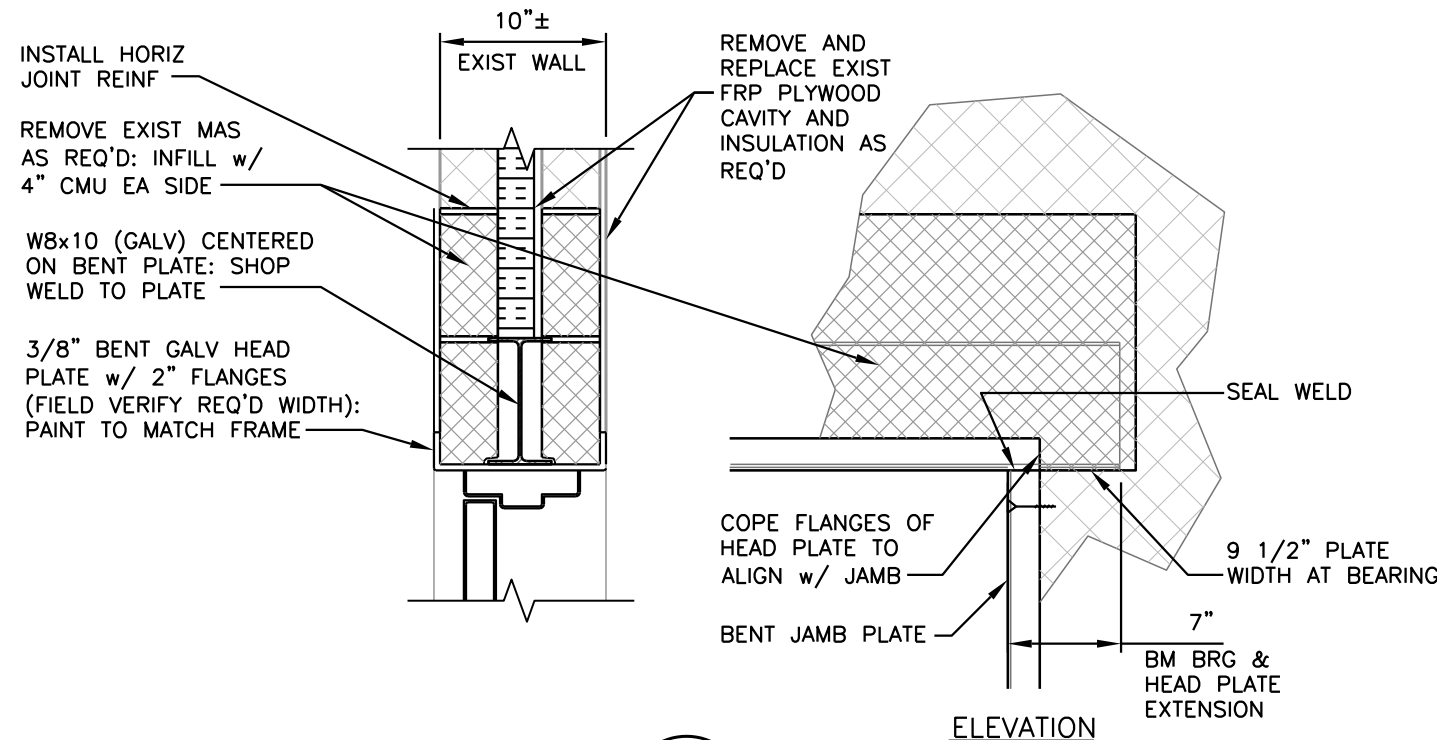

HEAD

SCALE: 1"=1'-0"


H4

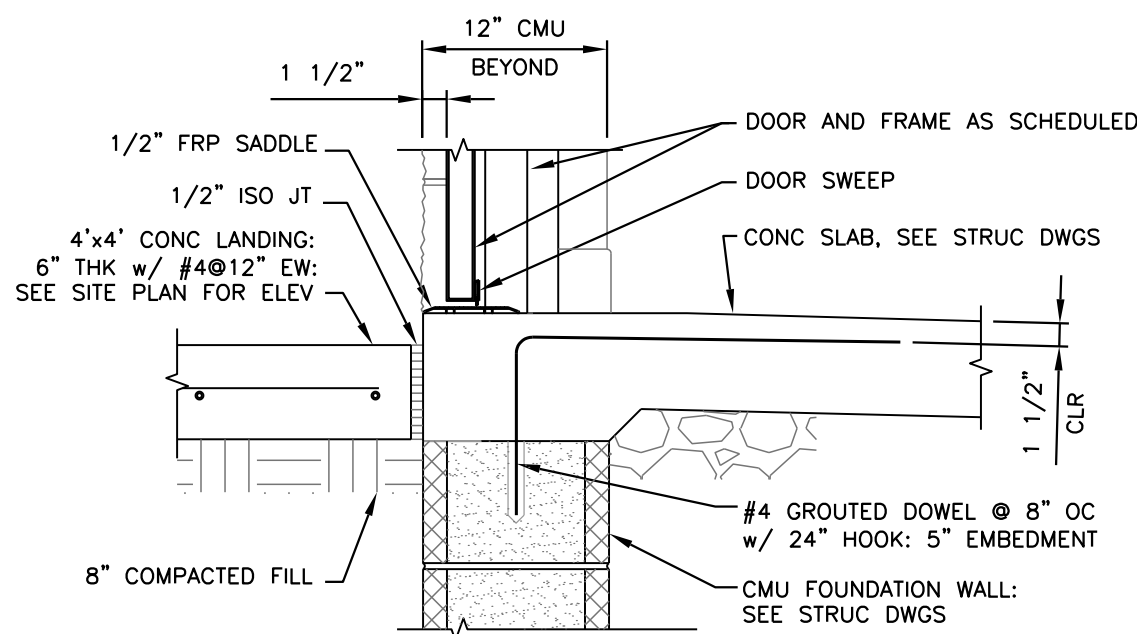

SILL

SCALE: 1"=1'-0"


S1

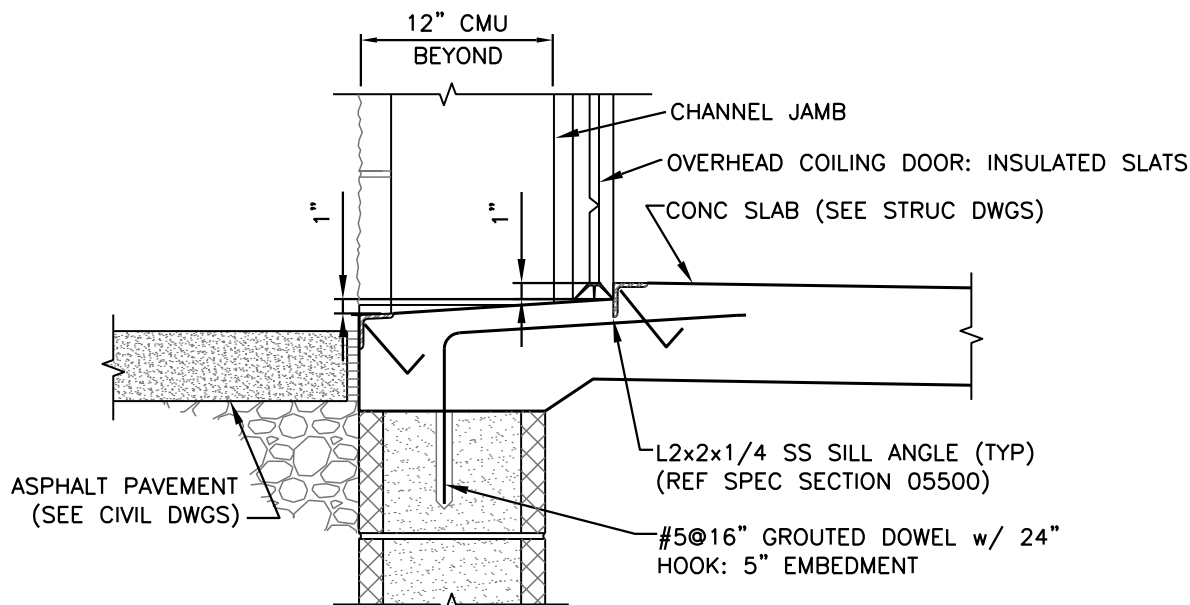

SILL

SCALE: 1"=1'-0"


S2

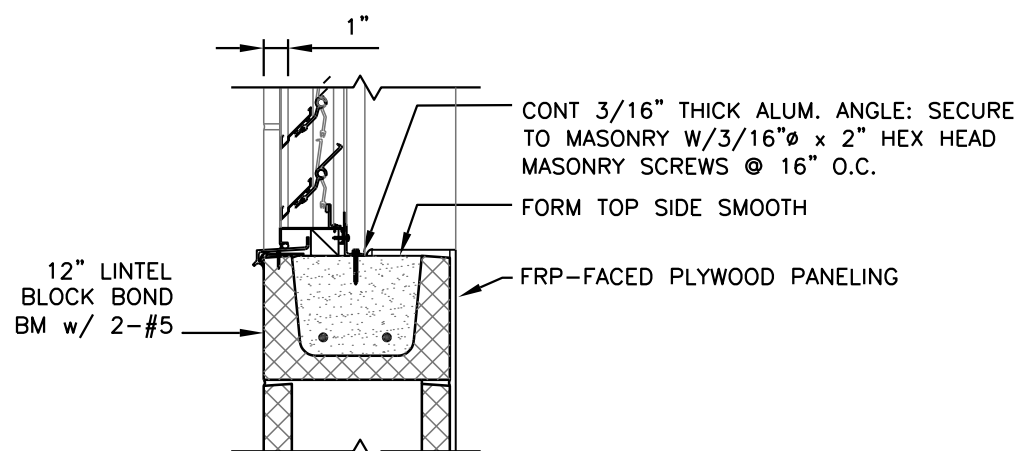

SILL

SCALE: 1"=1'-0"


S3

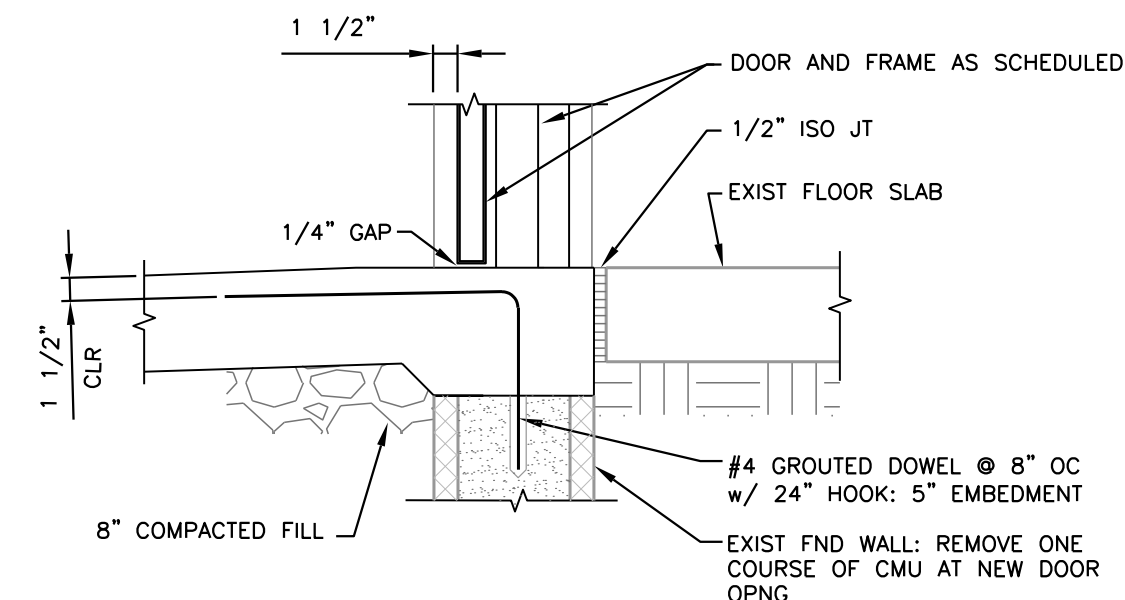

SILL

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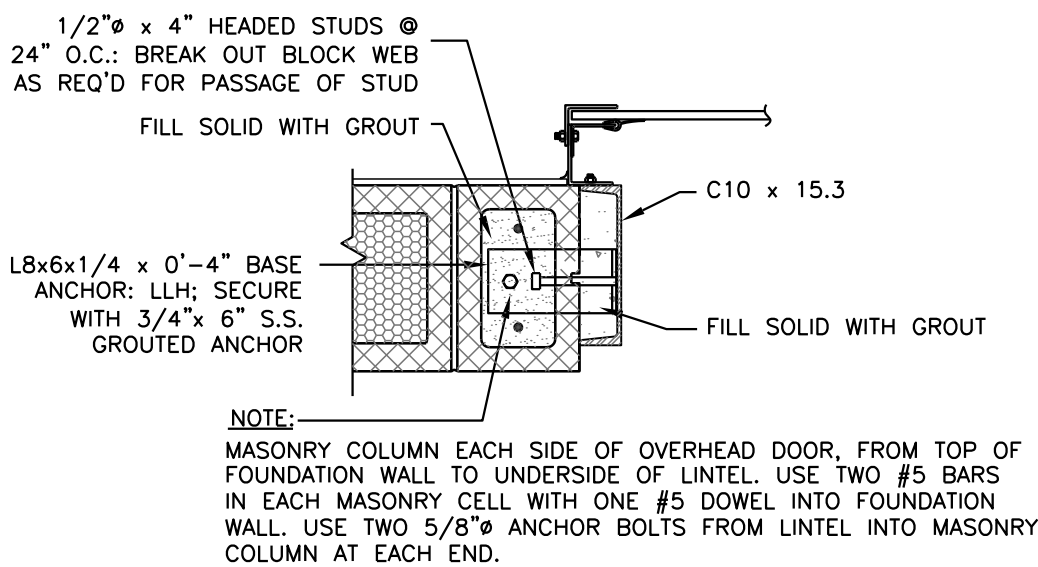
S4

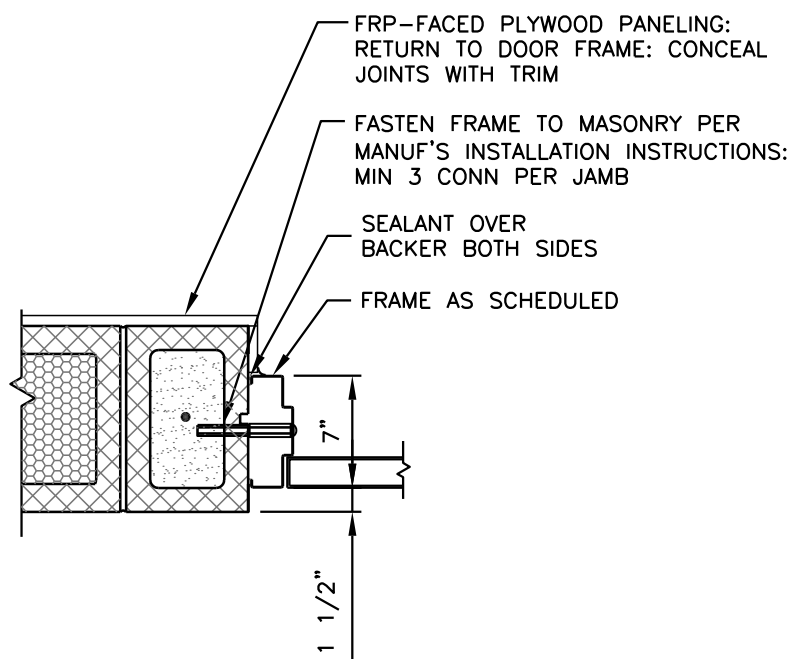

JAMB

SCALE: 1"=1'-0"


J1



JAMB

SCALE: 1"=1'-0"


J2

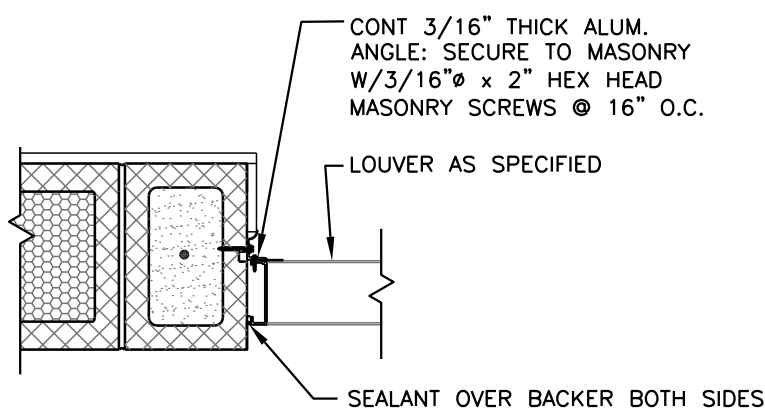

JAMB

SCALE: 1 1/2"=1'-0"

J3

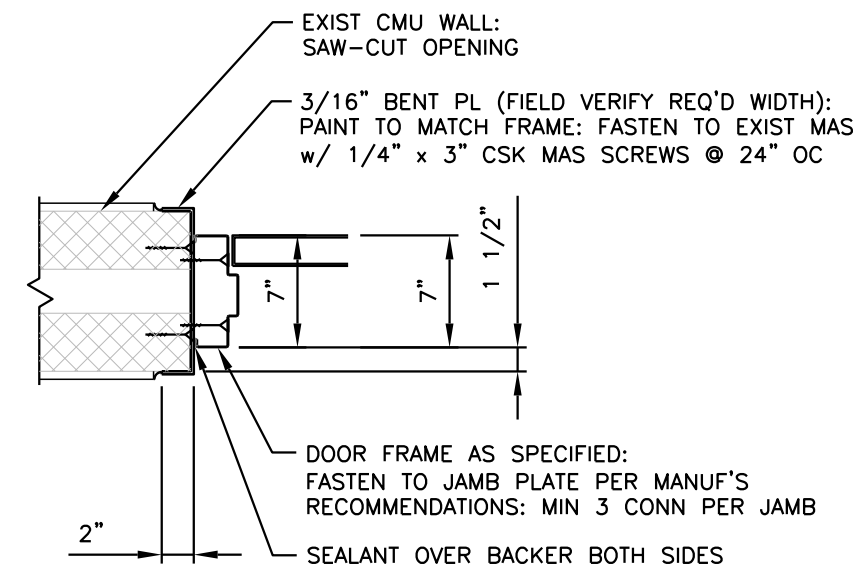

JAMB

SCALE: 1"=1'-0"


J4

3-REF: 20280a1
8/03, 8/04/06, 8/08
P:20280/30 (Drawings/Arch)

NOTES:

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ISSUE NO.	DRAWN	DATE	CHECKED	DESIGNER	APPROVED	DATE									
PROJECT SUPERVISOR			DEPARTMENT SUPERVISOR												
-----							ISSUE NO.	DRAWN	DATE	CHECKED	DESIGNER	APPROVED	DATE		

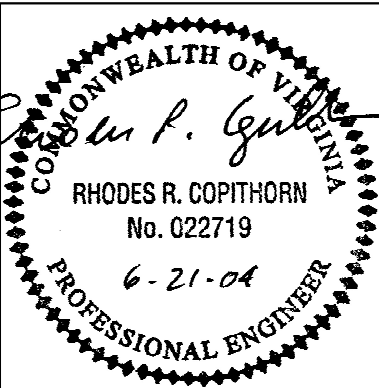

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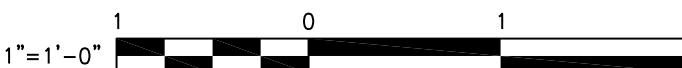
310 FIRST STREET, S.W., SUITE 150
ROANOKE, VIRGINIA 24011
PHONE: (540) 982-1910 FAX: (540) 982-1913


BEDFORD COUNTY PUBLIC SERVICE AUTHORITY

HIGH POINT WTP EXPANSION – PROJECT NO. 2003 – 028


HEAD, SILL & JAMB DETAILS

JOB NO. 20280 DRAWING A-4 SHEET 14 OF 37



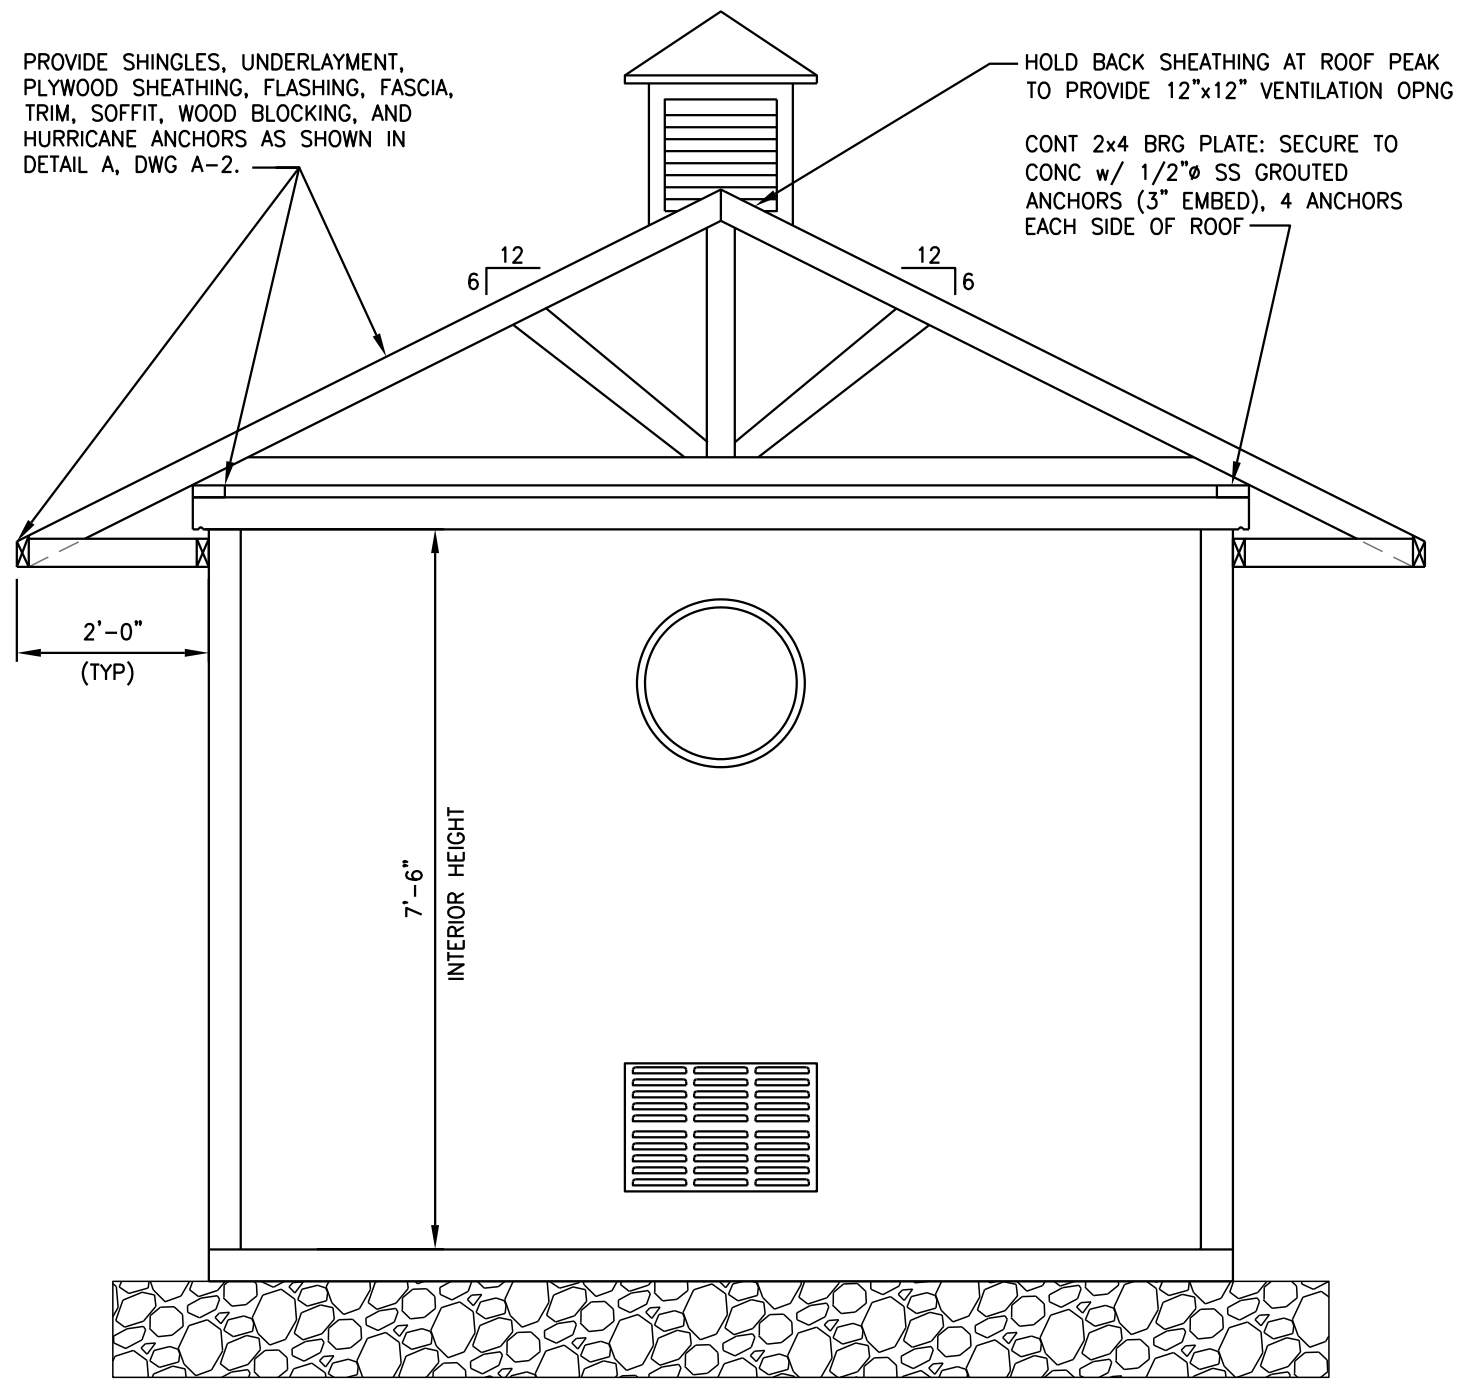


BLDG SECTION 1 A-5
SCALE: 1/2"=1'-0"

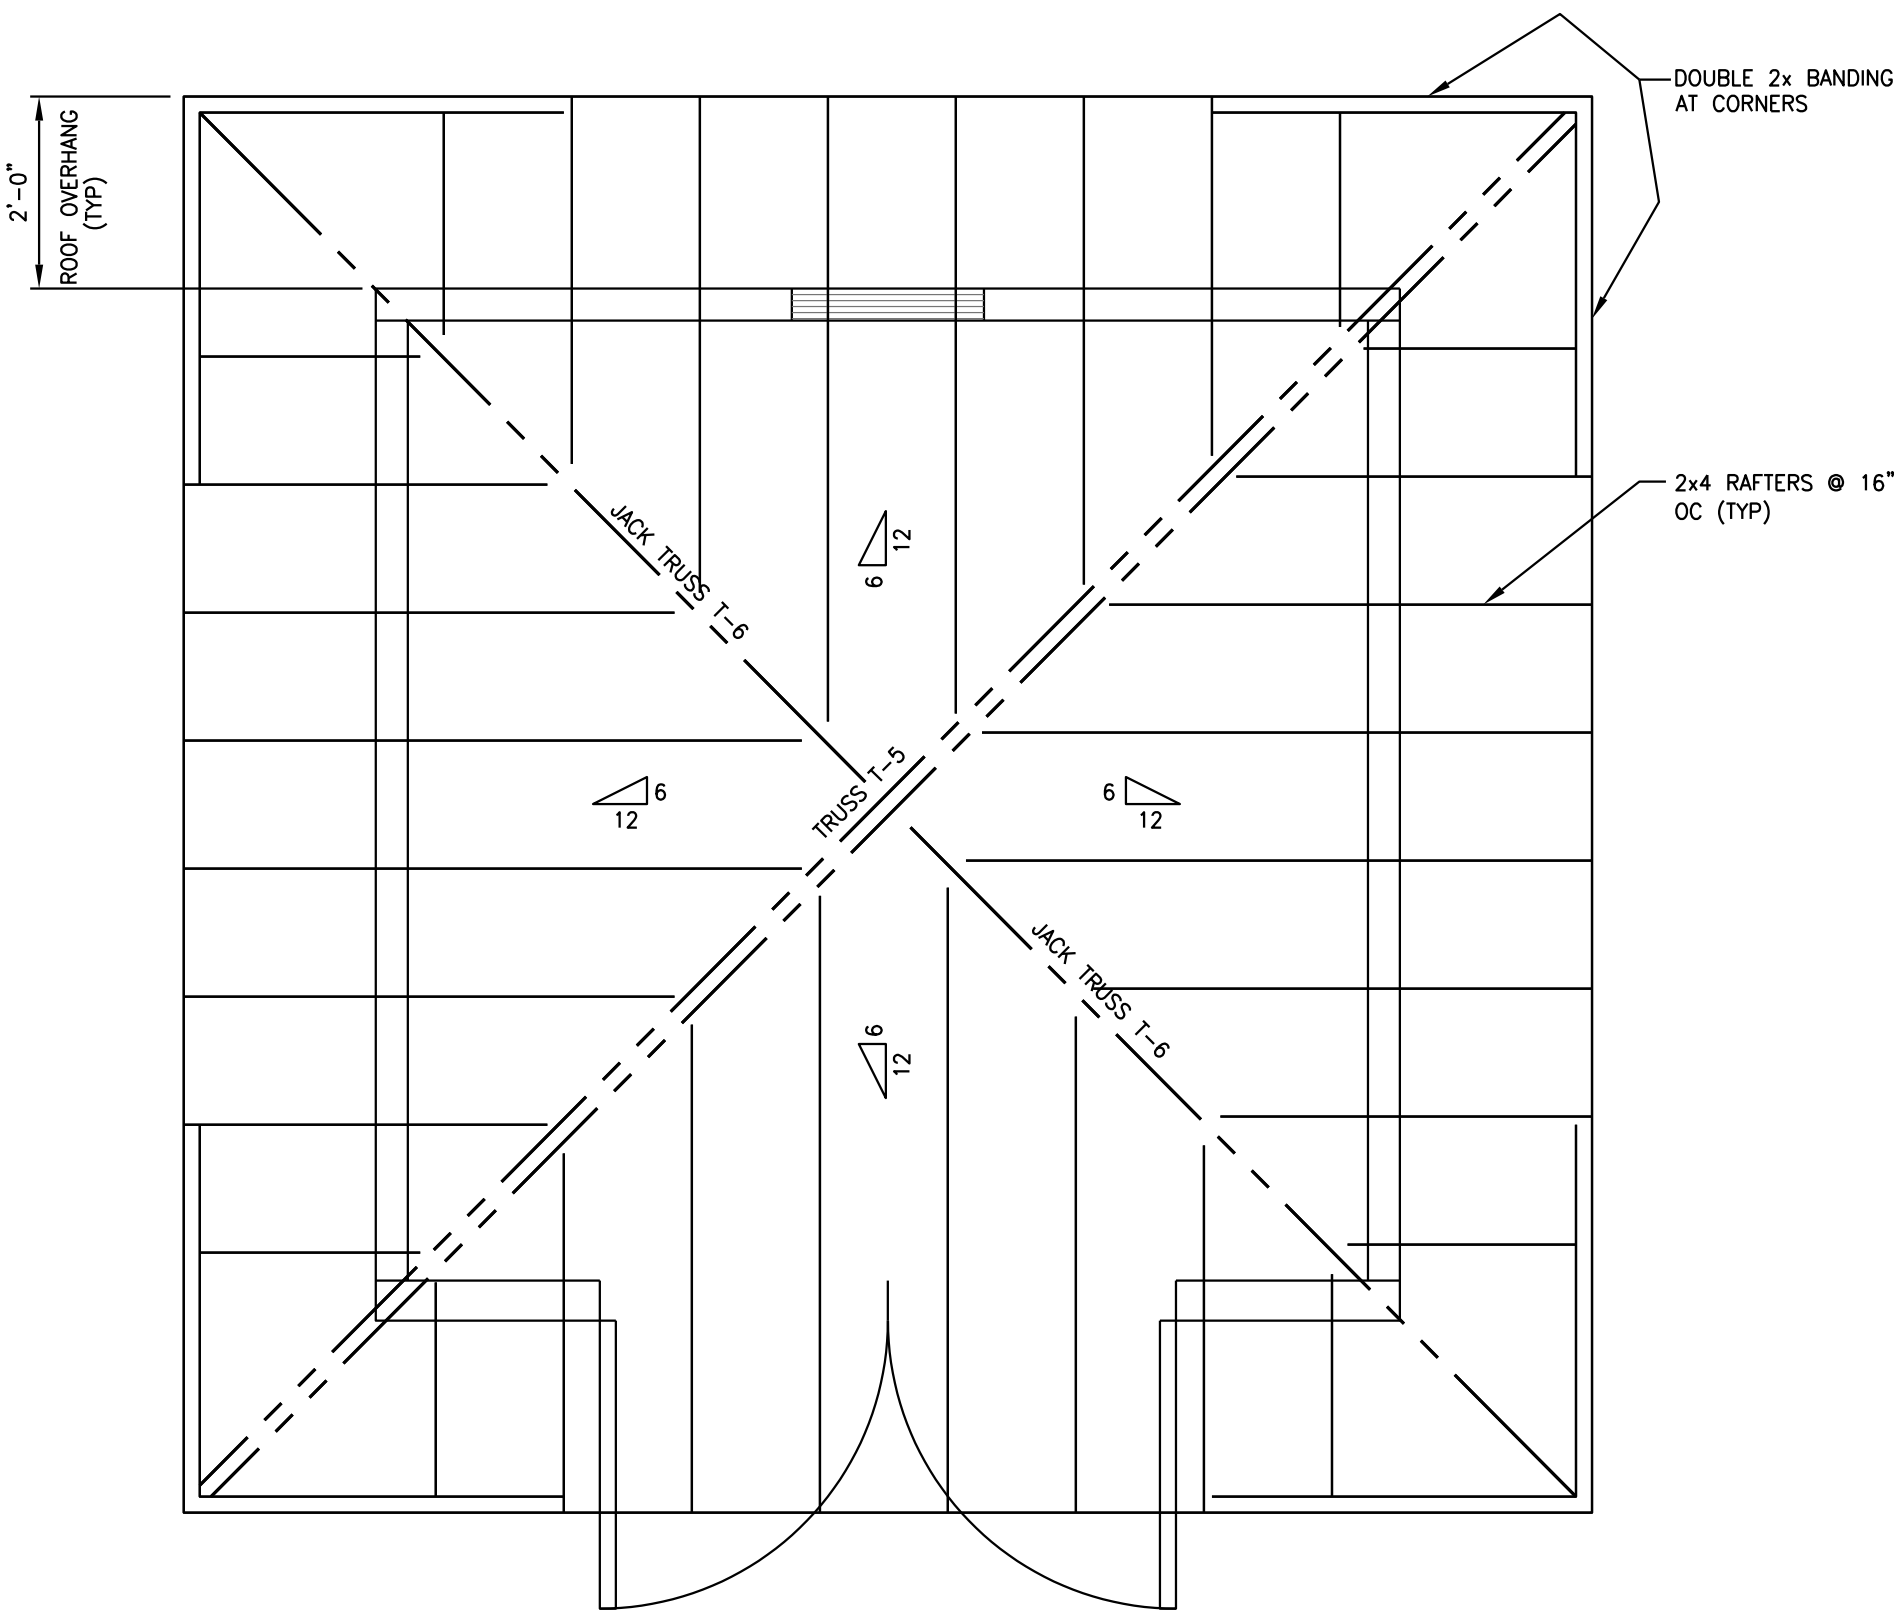


ROOF FRAMING PLAN
SCALE: 1/2"=1'-0"

NOTE:
1. SEE DWG S-2 FOR WOOD TRUSS NOTES.
2. PROVIDE MULTIPLE TRUSS T-5 (AND T-6) AS REQ'D BY TRUSS DESIGN.

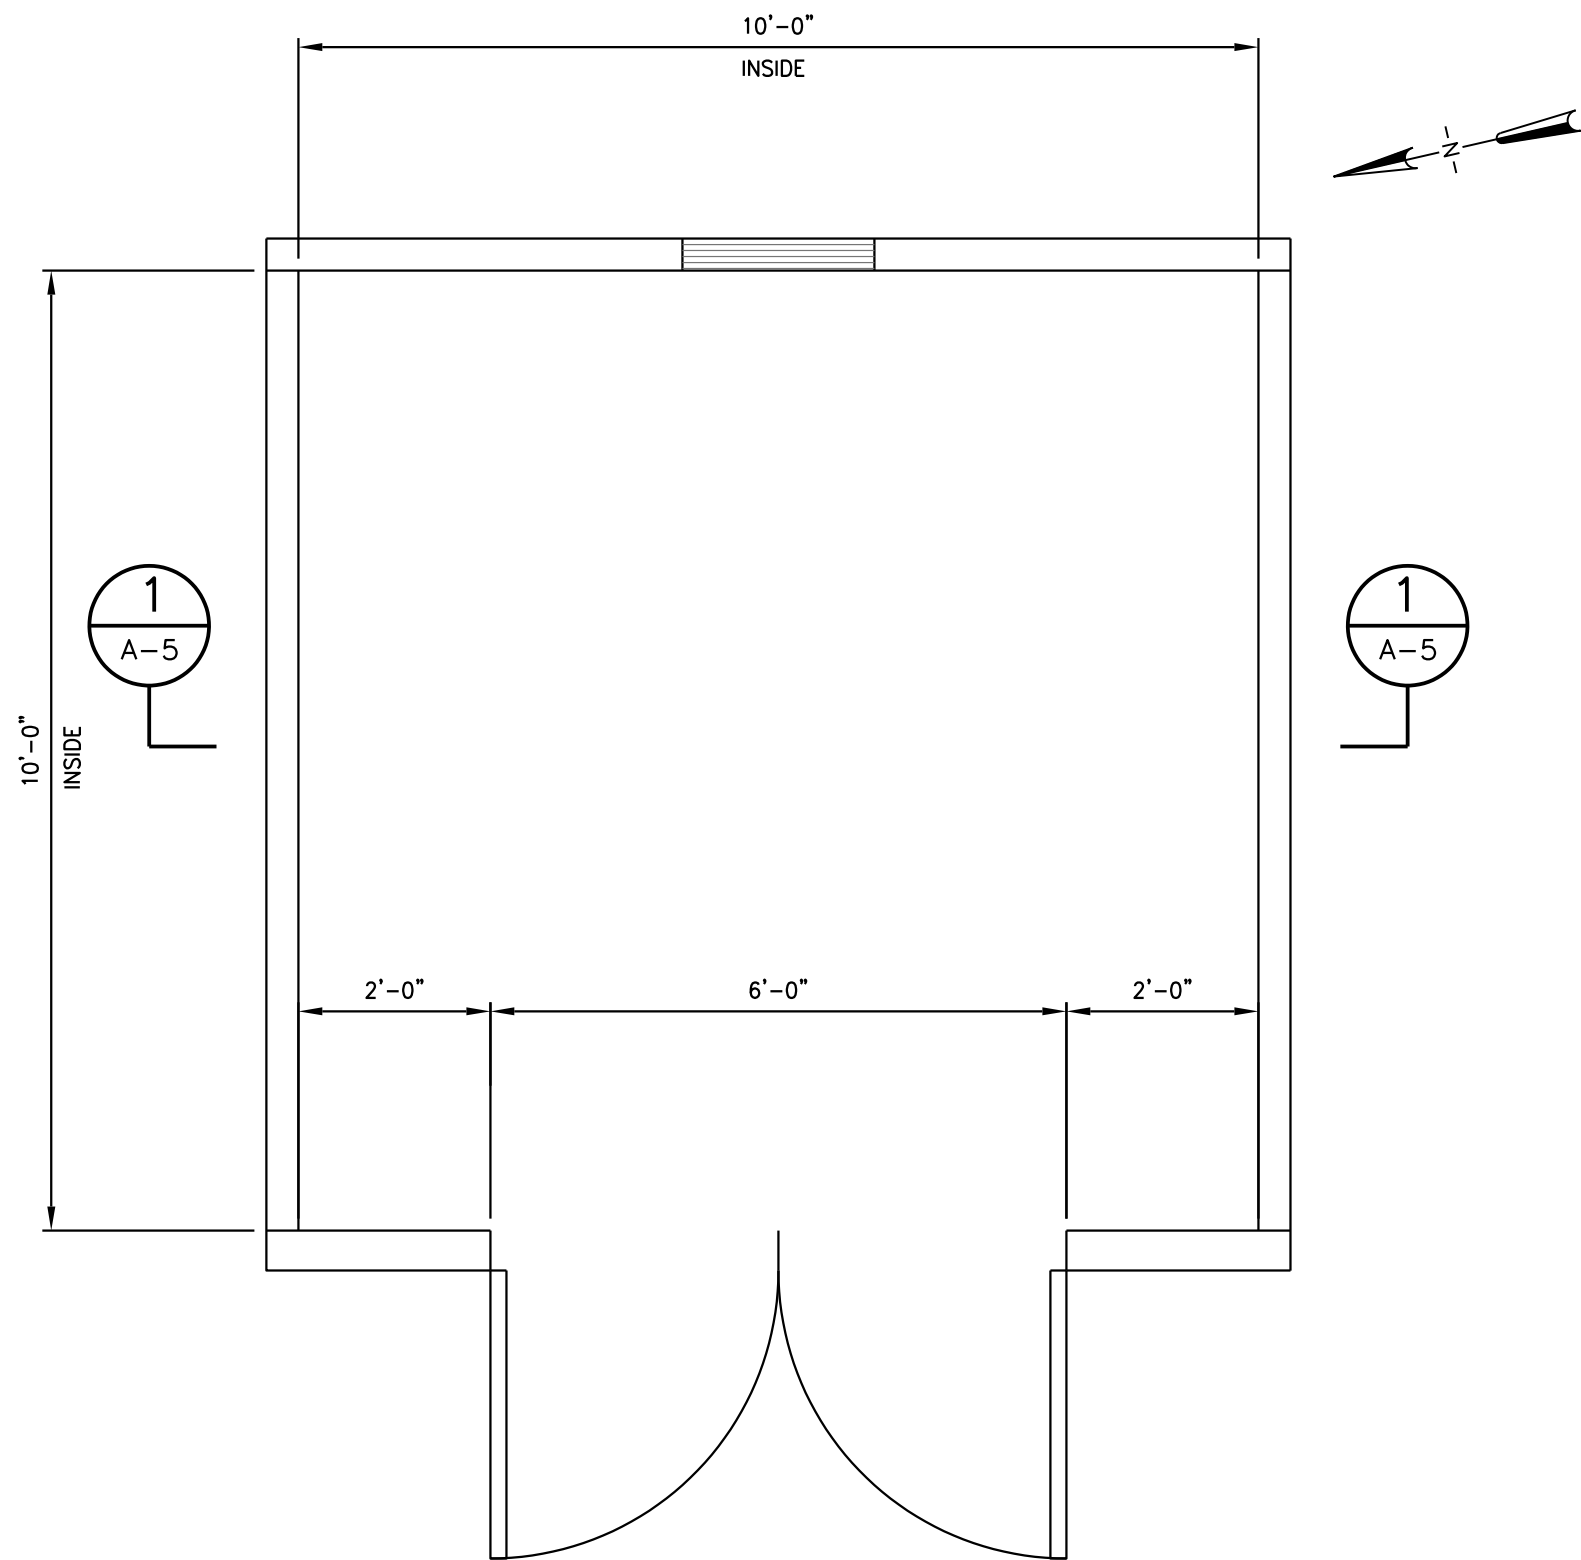


PLAN
SCALE: 1/2"=1'-0"

NOTE:
1. PRE-ENGINEERED, PRE-CAST CONCRETE BUILDING BY THE CLEAR FLOW CO., WAYNESBORO, VA, (OR EQUAL) 1-800-868-8366. CONTRACTOR MAY SUBMIT FOR ALTERNATE MANUFACTURER.
2. DOORS, LOUVERS AND HARDWARE SHALL BE MANUFACTURER'S STANDARD.
3. PRECAST CONC SHALL HAVE MINIMUM 5,000 PSI 28-DAY COMPRESSIVE STRENGTH.
4. ROOF SHALL BE CONSTRUCTED "FLAT" TO ACCOMMODATE ROOF FRAMING.

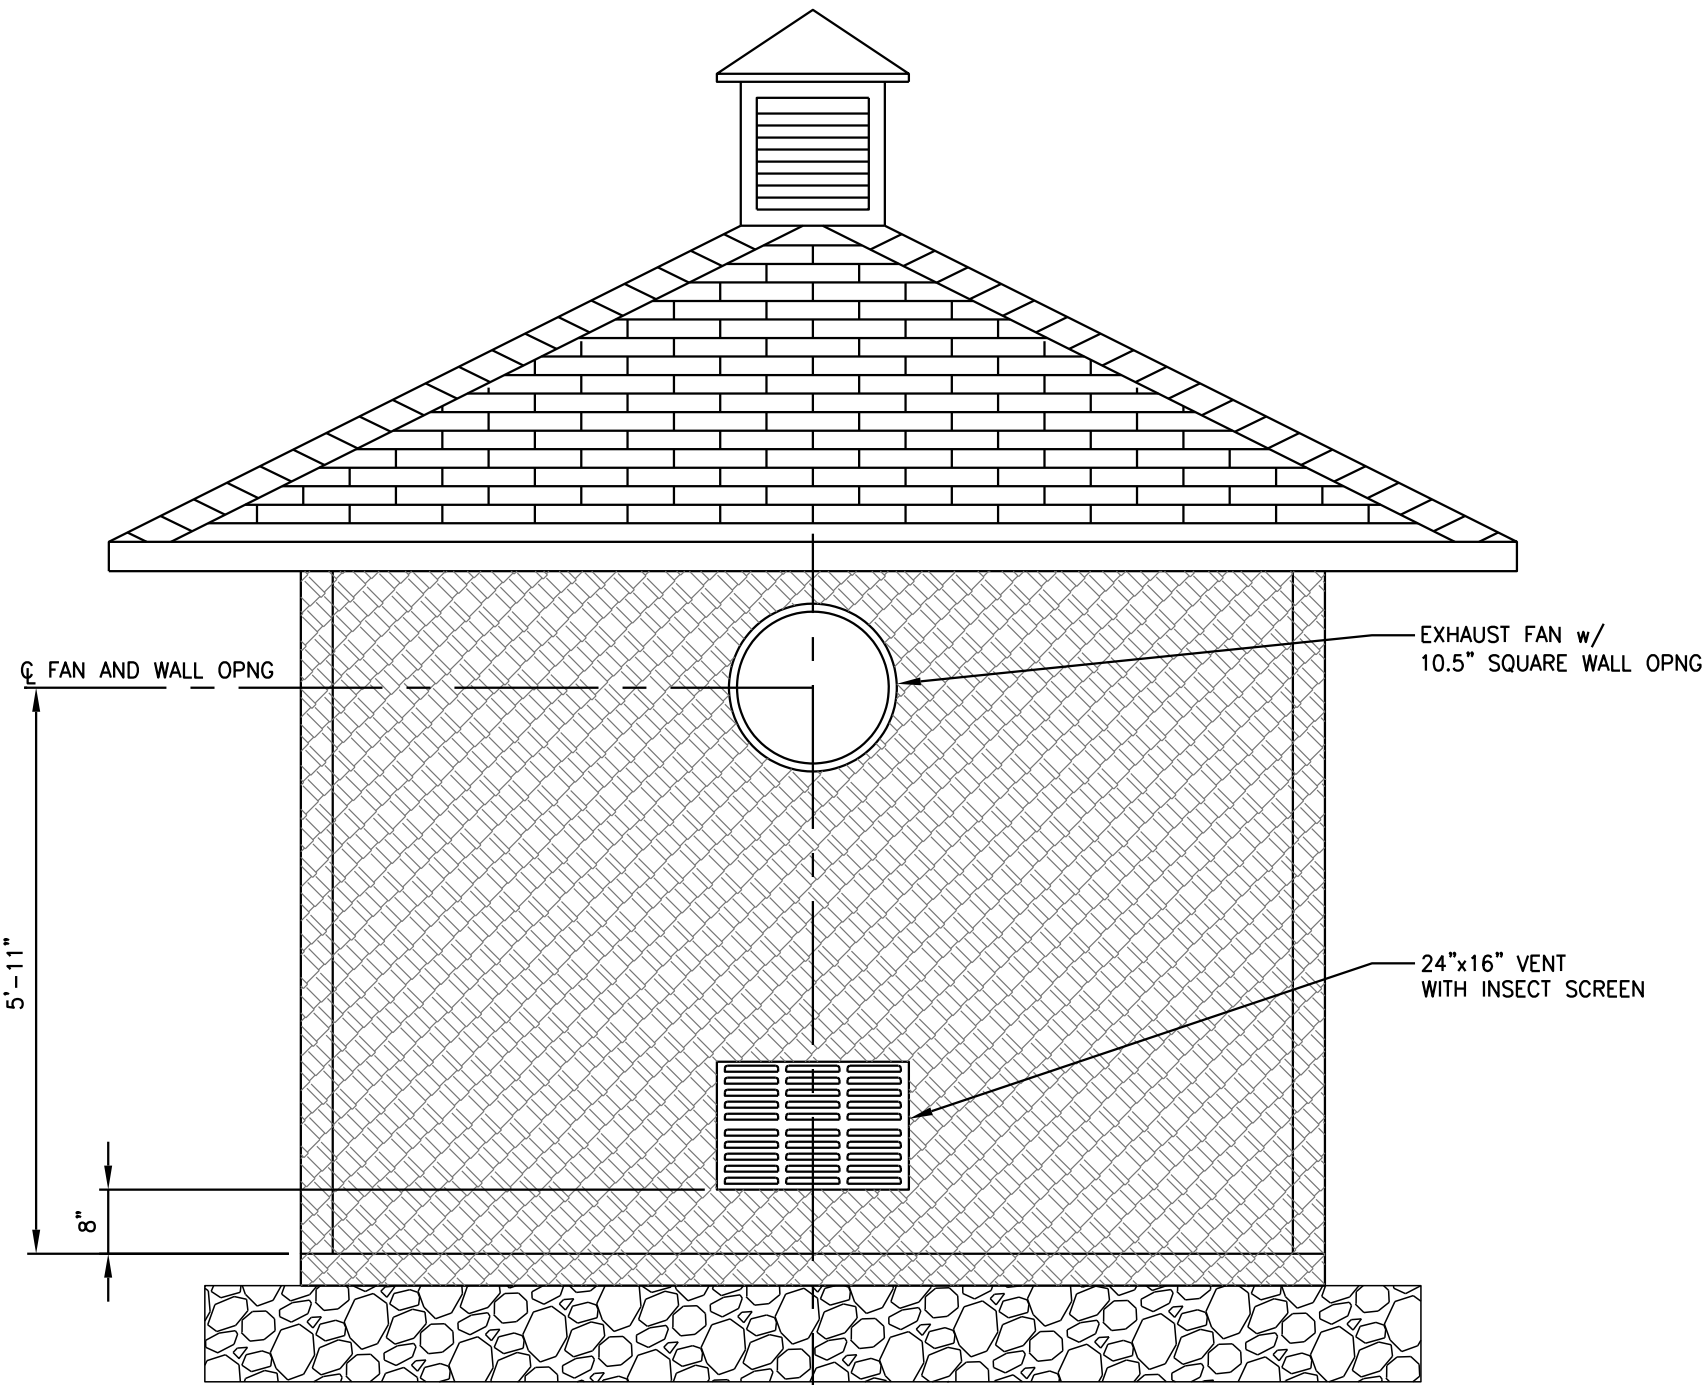

REAR ELEVATION
SCALE: 1/2"=1'-0"

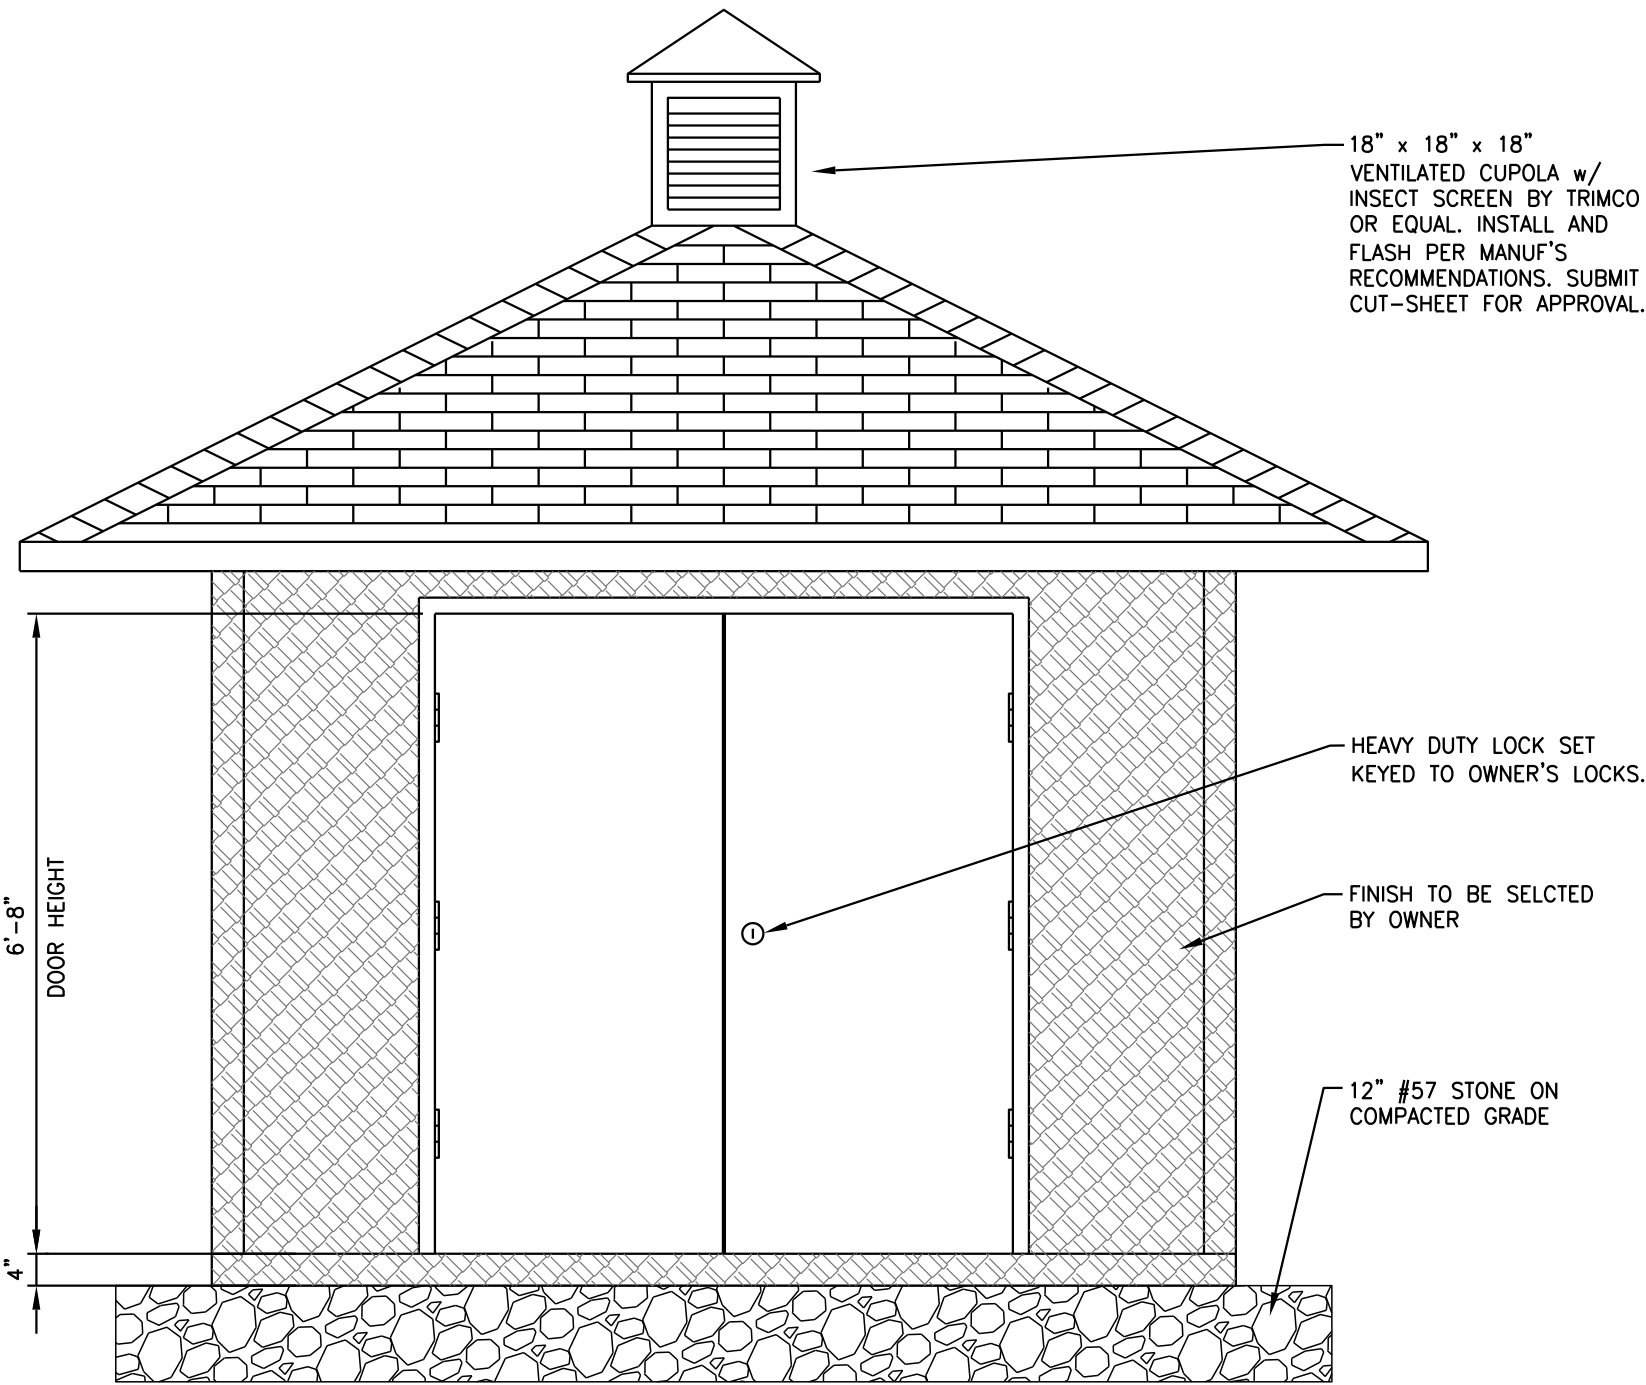


FRONT ELEVATION
SCALE: 1/2"=1'-0"

X-REF: 20280-A-RWPS-PL
8/03, ROANOKE, ISB
P: (20280) 30 (Preliminary)

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PROJECT SUPERVISOR					DEPARTMENT SUPERVISOR														
										ISSUE NO.	DRAWN	DATE	CHECKED	DESIGNER	APPROVED	DATE			

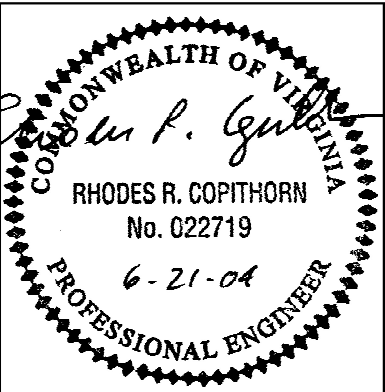

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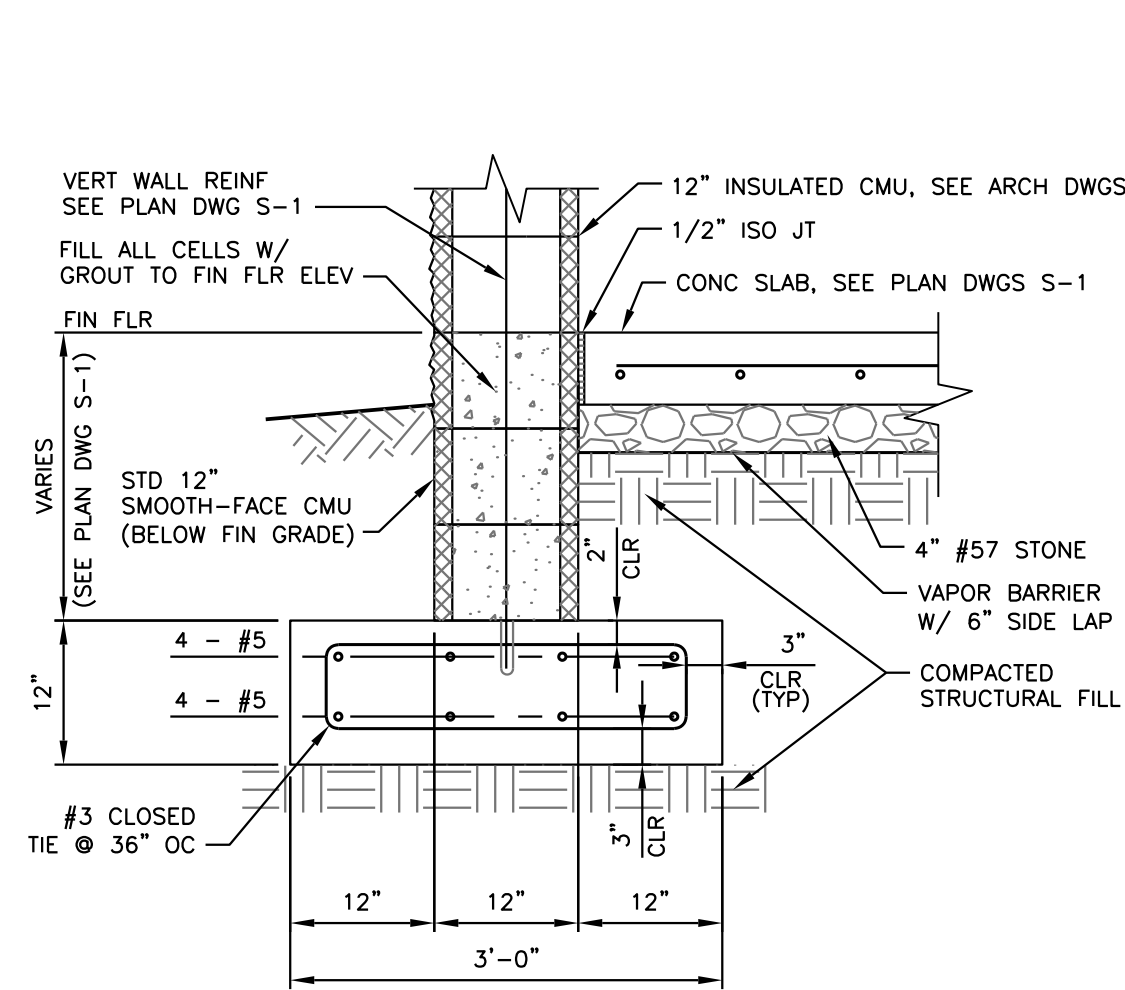
310 FIRST STREET, S.W., SUITE 150
ROANOKE, VIRGINIA 24011
PHONE: (540) 982-1910 FAX: (540) 982-1913

BEDFORD COUNTY PUBLIC SERVICE AUTHORITY


HIGH POINT WTP EXPANSION – PROJECT NO. 2003 – 028

RAW WATER PUMP STATION
ELECTRICAL BUILDING
PLANS, ELEVATIONS & DETAILS


JOB NO.	20280	DRAWING	A-5	SHEET	15 OF 37
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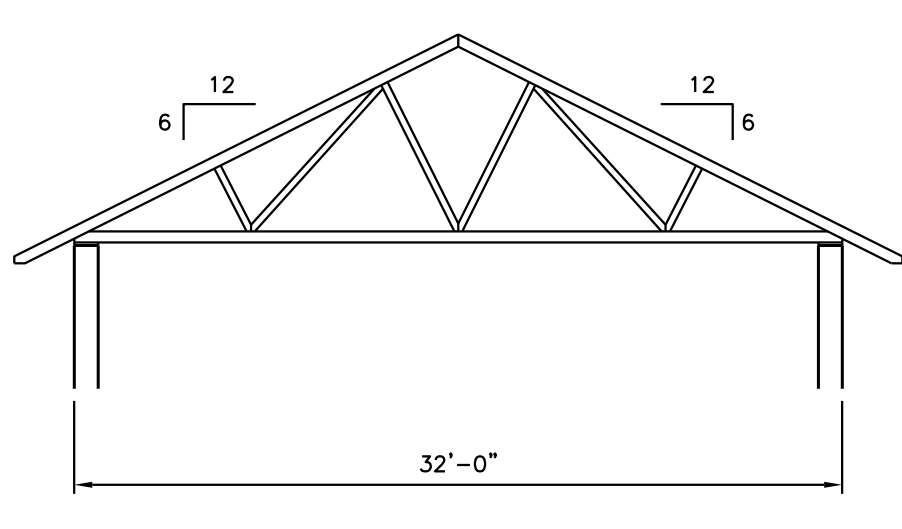
TYP FOUNDATION WALL SECTION **1**
3/4"=1'-0" S-1




TYP TRENCH SECTION **2**
1/2"=1'-0" S-1

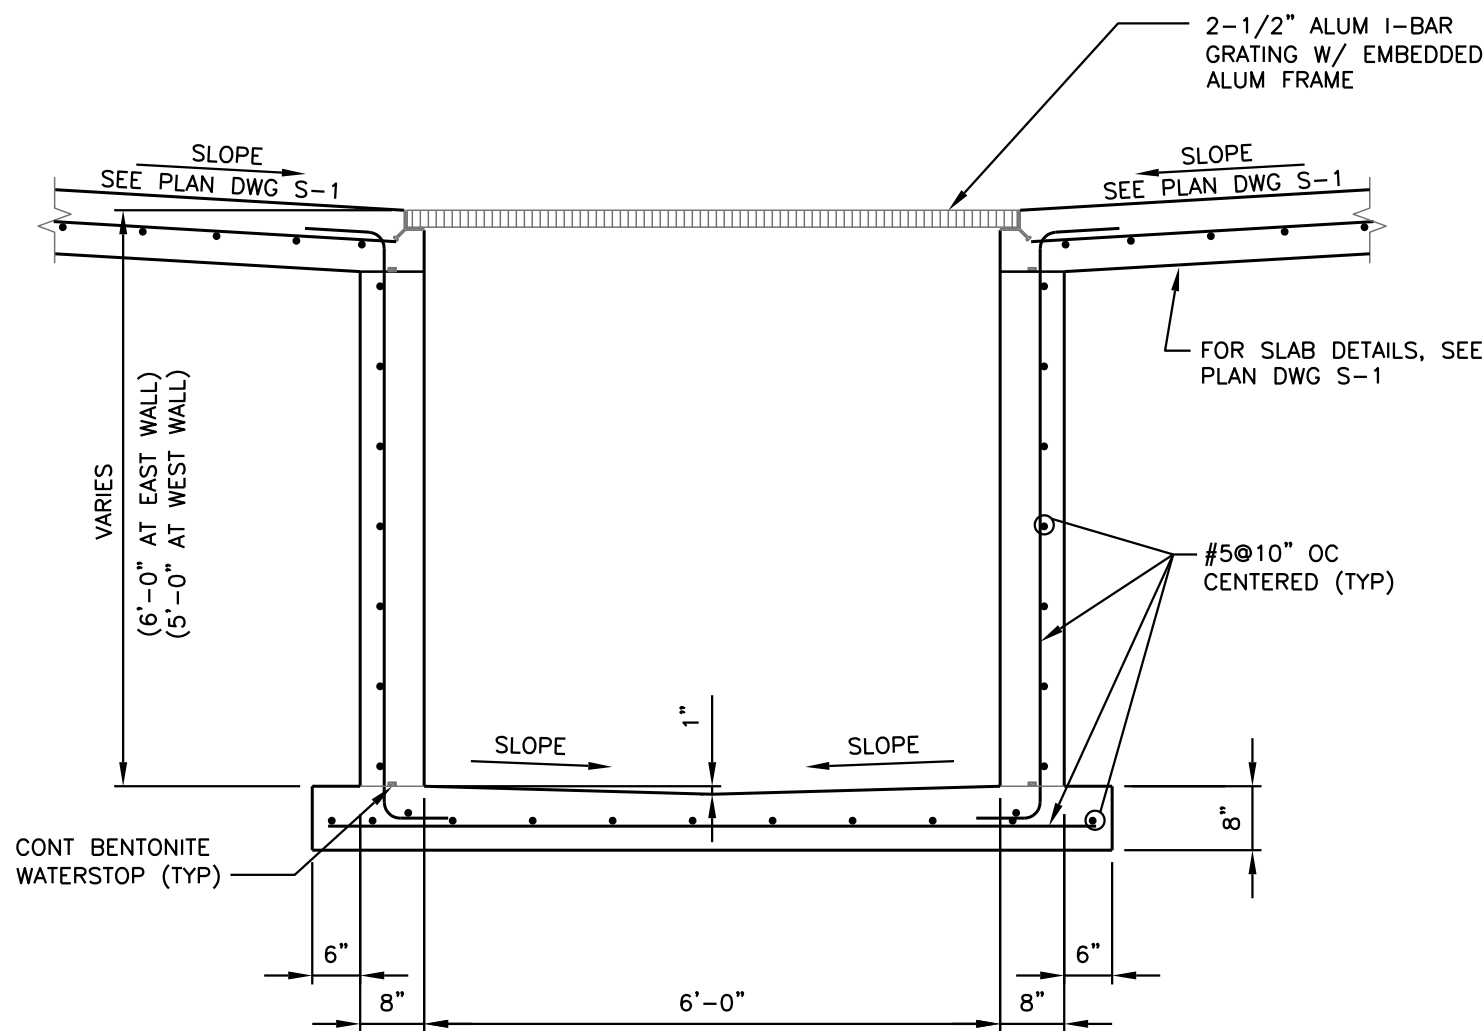


TRUSS T-1

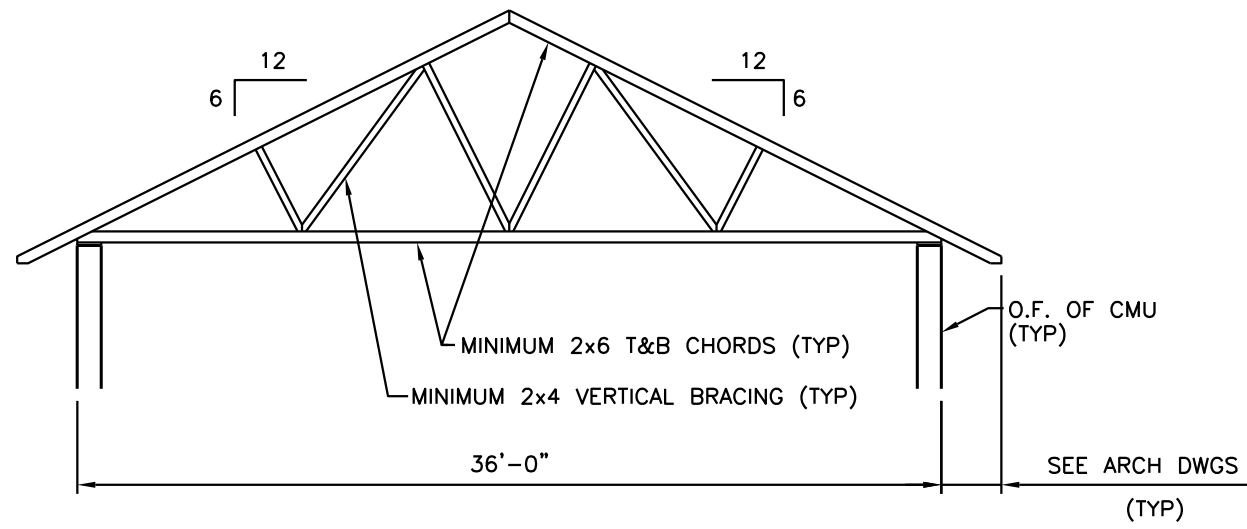


TRUSS T-3

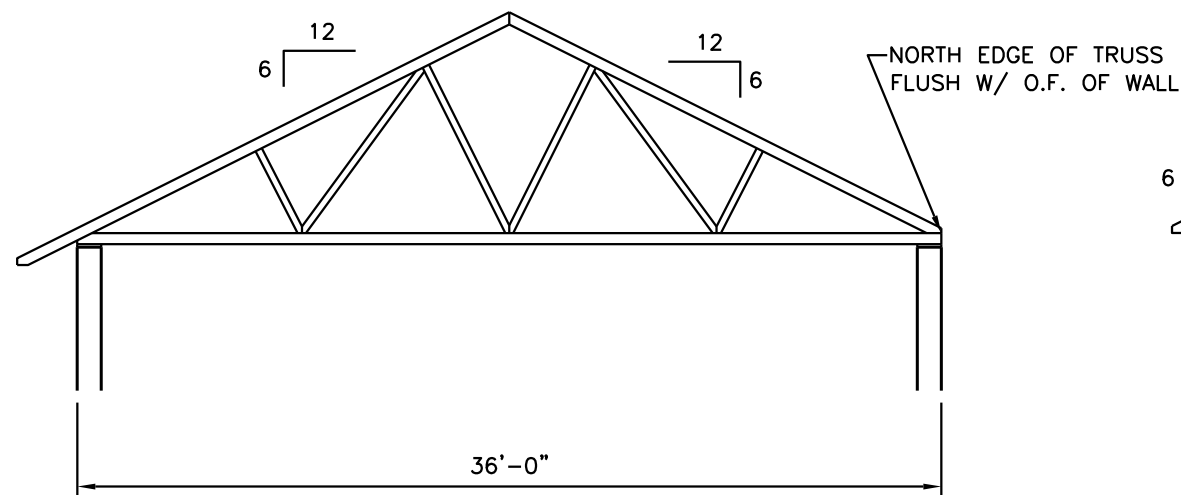


TRUSS T-2

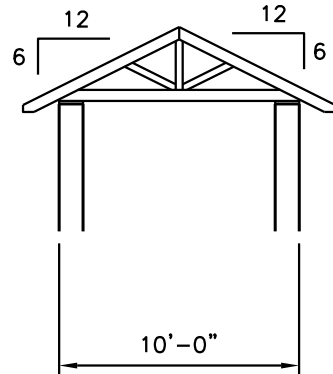

TRUSS T-4

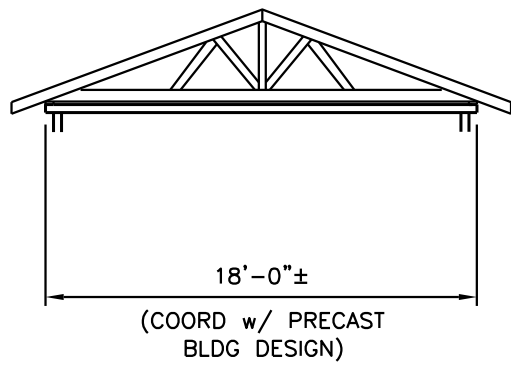

DIAGONAL TRUSS T-5
(REFER DWG A-5)

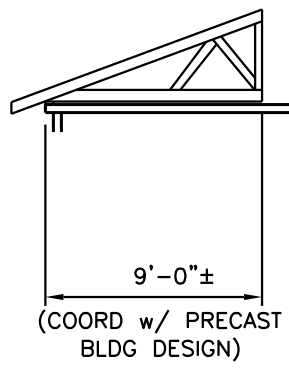

JACK TRUSS T-6
(REFER DWG A-5)

ROOF TRUSS ELEVATIONS

SCALE: 1/8"=1'-0"

SHOP-FABRICATED WOOD ROOF TRUSS NOTES:


1. PRE-FABRICATED WOOD ROOF TRUSSES SHALL BE DESIGNED FOR, IN ADDITION TO SELF-WEIGHT LOADS, THE FOLLOWING MINIMUM LOADS:

TOP CHORD LIVE LOAD - 20 PSF
TOP CHORD DEAD LOAD - 10 PSF
BOTTOM CHORD LIVE LOAD - 10 PSF
BOTTOM CHORD DEAD LOAD - 5 PSF


WIND LOADS IN ACCORDANCE WITH IBC-2001
EXPOSURE CATEGORY C, IMPORTANCE FACTOR 1.1
BASIC WIND SPEED (3 SECOND GUST) - 90 MPH

LIVE LOAD DEFLECTION OF ROOF TRUSS AT MID-SPAN SHALL BE LIMITED TO L/240 (WHERE L IS SPAN LENGTH).

2. SEE SPECIFICATION SECTION 06193 FOR ADDITIONAL NOTES.

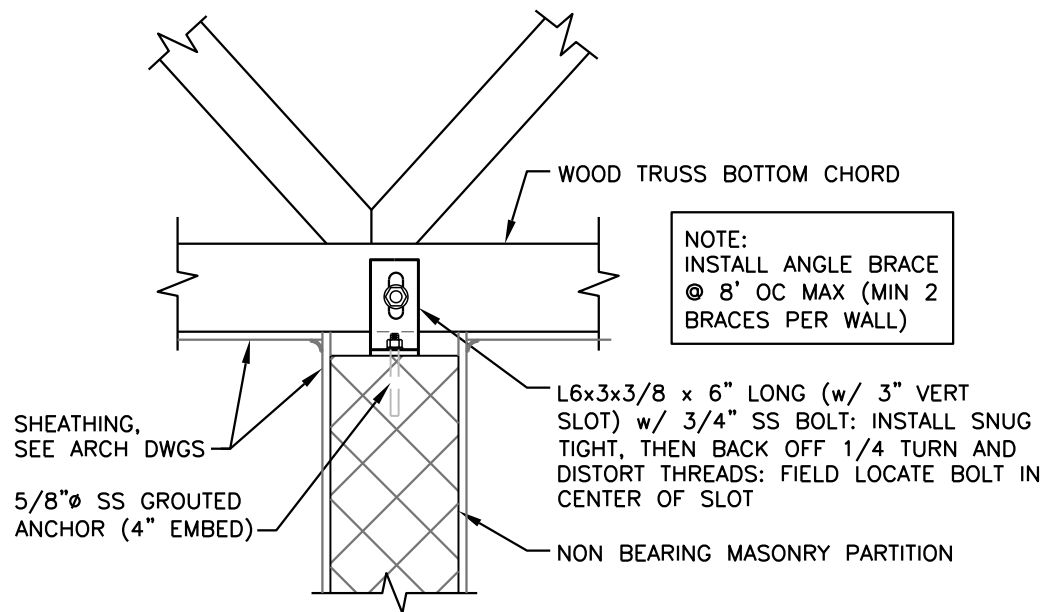

CMU PARTITION WALL BRACE **4**
1"=1'-0" S-1

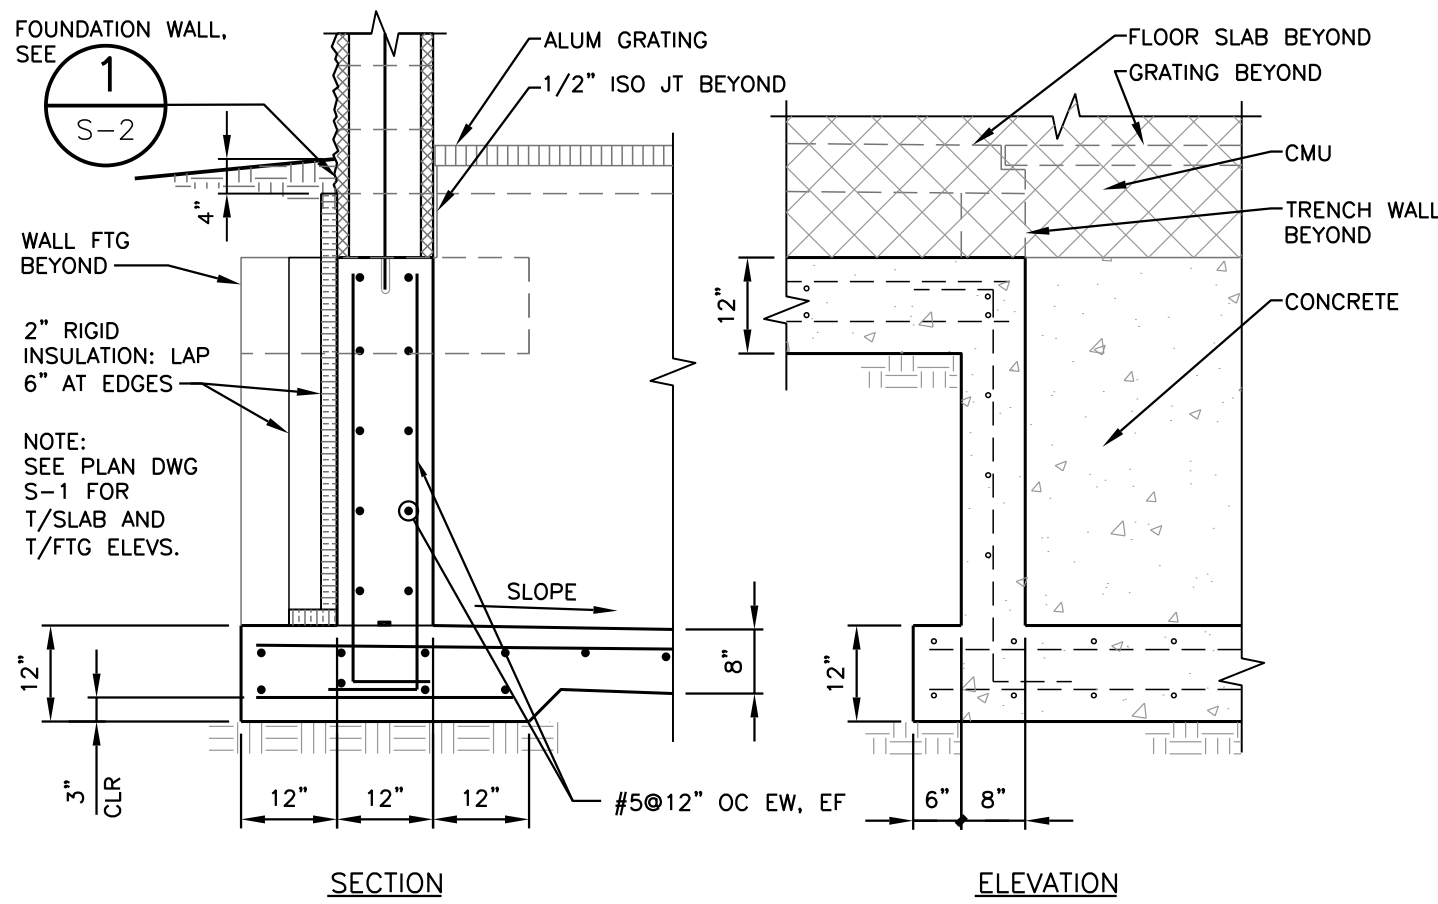


TRENCH END WALL DETAILS **3**
1/2"=1'-0" S-1

X-REF: 20280a-1, 20280-A-TB-SC, TB-TRENCH, TRENCH END-WALL, TYPF14
8/03, ROANOKE, VIR
P:\20280\30\Drawings\Struct

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	FOR APPROVAL					
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PROJECT SUPERVISOR		DEPARTMENT SUPERVISOR		ISSUE NO.	DRAWN	DATE
				DATE	CHECKED	DESIGNER
				APPROVED	DATE	



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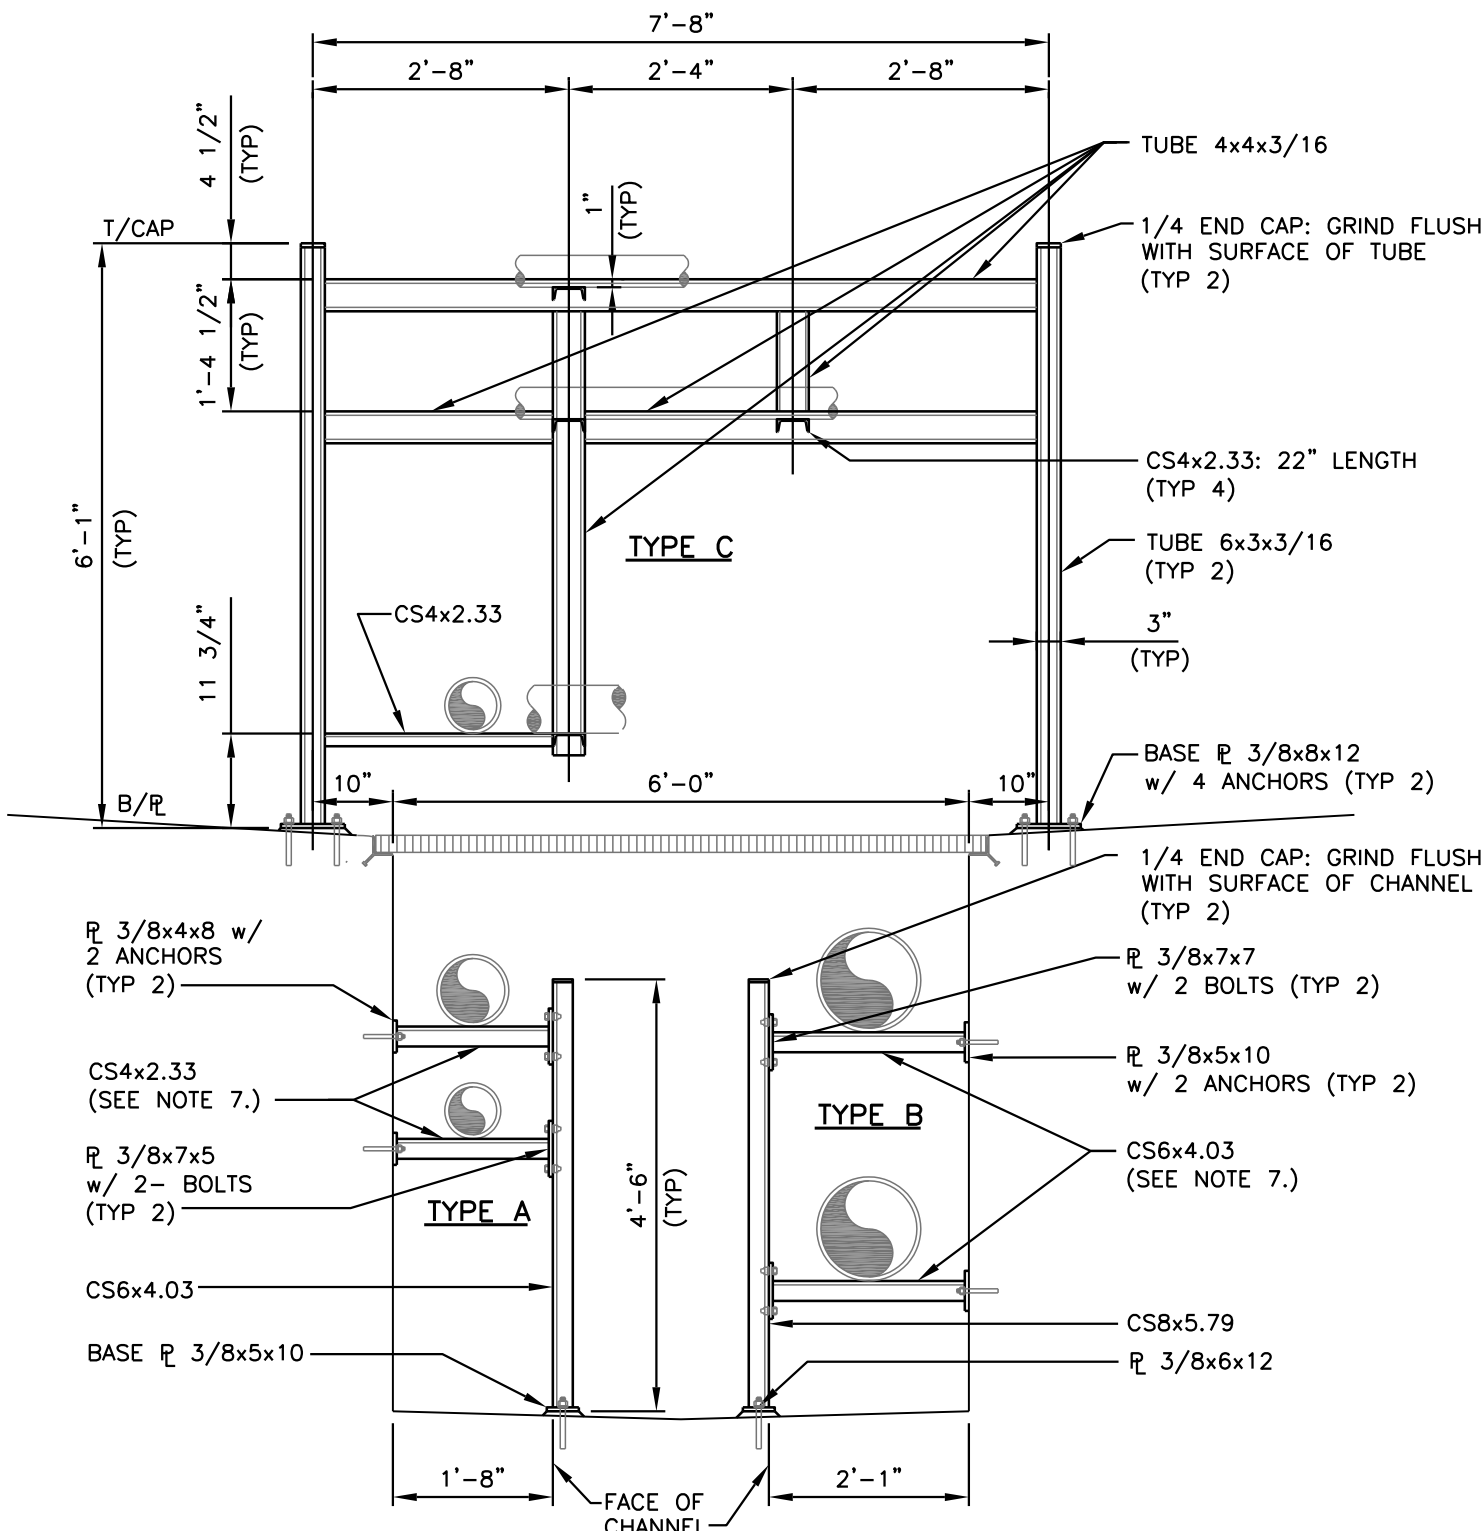
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ROANOKE, VIRGINIA 24011
PHONE: (540) 982-1910 FAX: (540) 982-1913

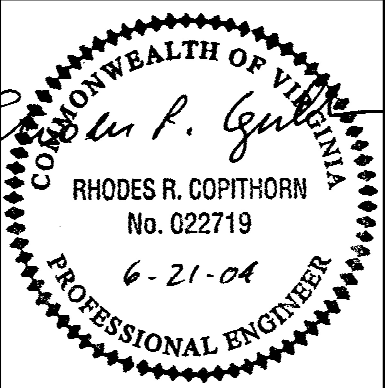BEDFORD COUNTY PUBLIC SERVICE AUTHORITY

HIGH POINT WTP EXPANSION - PROJECT NO. 2003 - 028

SECTIONS & DETAILS


JOB NO. 20280 DRAWING S-2 SHEET 17 OF 37



- NOTE:
1. ALL SECTIONS & PLATES SHALL BE ALUM 6061-T6.
 2. ALL ANCHORS SHALL BE 5/8"Ø SS GROUTED, 4" EMBEDMENT.
 3. ALL BOLTS SHALL BE 5/8"Ø SS.
 4. SHOP-WELD ALL CONNECTIONS (3/16" ALL-AROUND FILLET), EXCEPT WHERE NOTED TO BE FIELD-BOLTED.
 5. MAX 1" NON-SHRINK GROUT UNDER BASE PLATES AS REQ'D.
 6. ANCHOR PIPES TO SUPPORTS W/ 1/2"Ø SS FIELD-DRILLED U-BOLTS, SIZE AS REQ'D.
 7. FIELD LOCATE REQ'D ELEV OF SUPPORT AND FIELD-DRILL POST FOR BOLTED ATTACHMENT.
 8. SEE MECH PLANS FOR REQUIRED LOCATIONS OF PIPE SUPPORT FRAMES.
 9. PIPE SUPPORT LOCATIONS ARE SHOWN BASED ON PROPOSED PIPE LAYOUT. CONTRACTOR SHALL COORDINATE FINAL SUPPORT LOCATIONS WITH ACTUAL PIPING LAYOUT.

PIPE SUPPORT DETAILS


TRENCH SECTION 1/2"=1'-0"

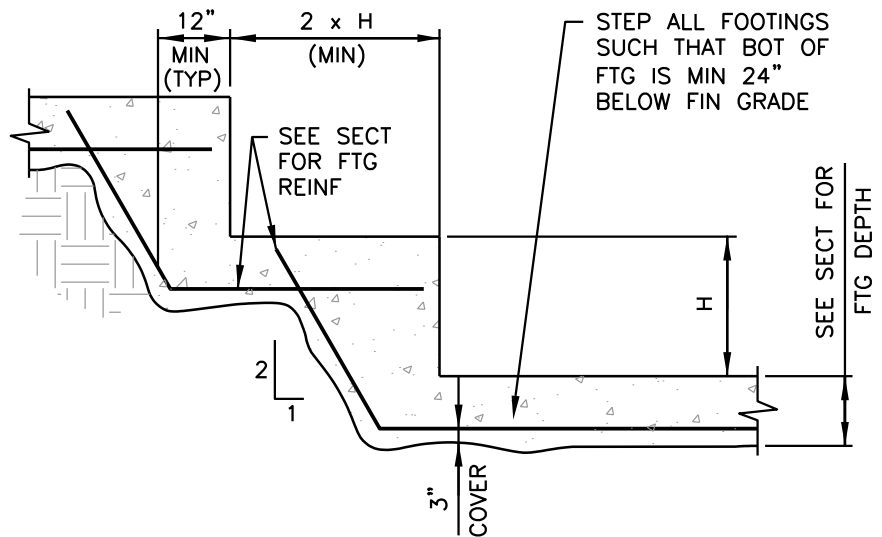

NOTE: SEE FOUNDATION PLAN FOR OTHER LOCATIONS WHERE FOOTING STEP REQ'D.


STEPPED FOOTING DETAIL

NOT TO SCALE

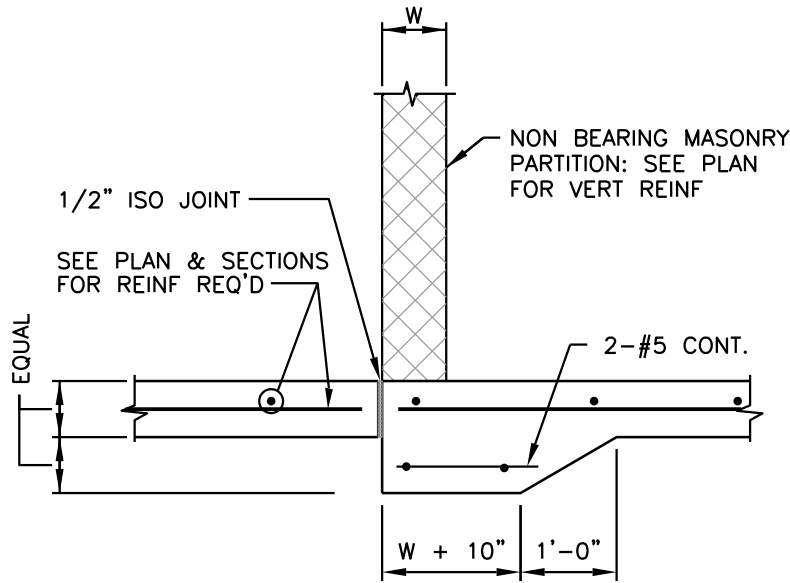

THICKENED SLAB DETAIL

NOT TO SCALE

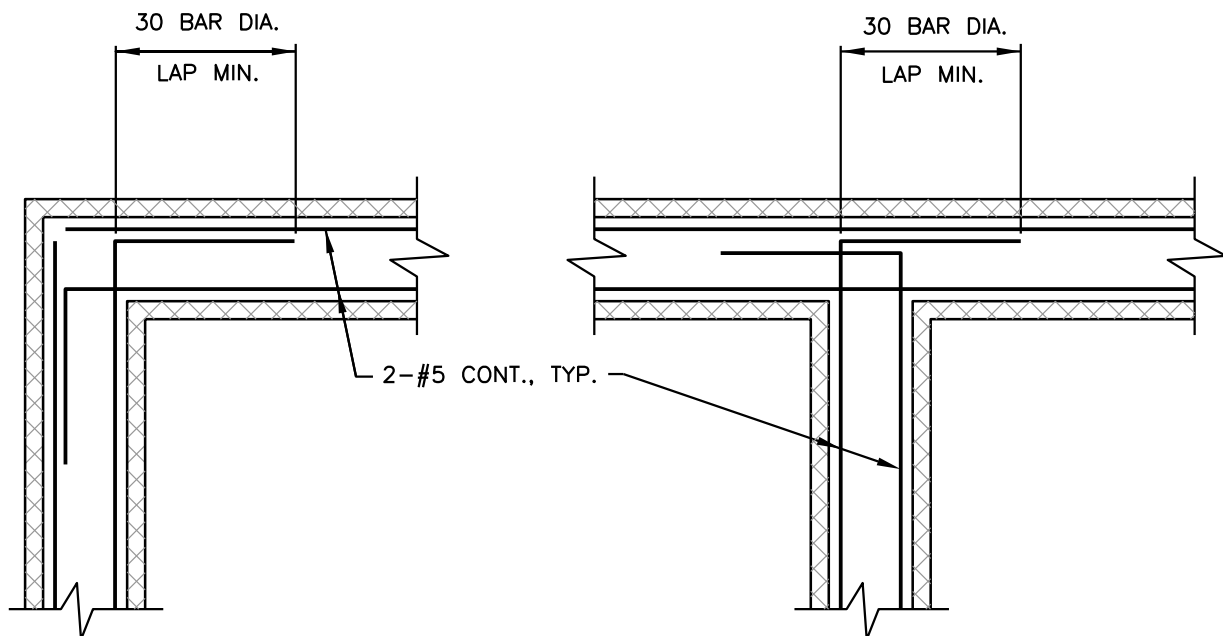


EXTERIOR CORNER

INTERIOR CORNER

BOND BEAM REINFORCING PLACEMENT DETAIL


NOT TO SCALE

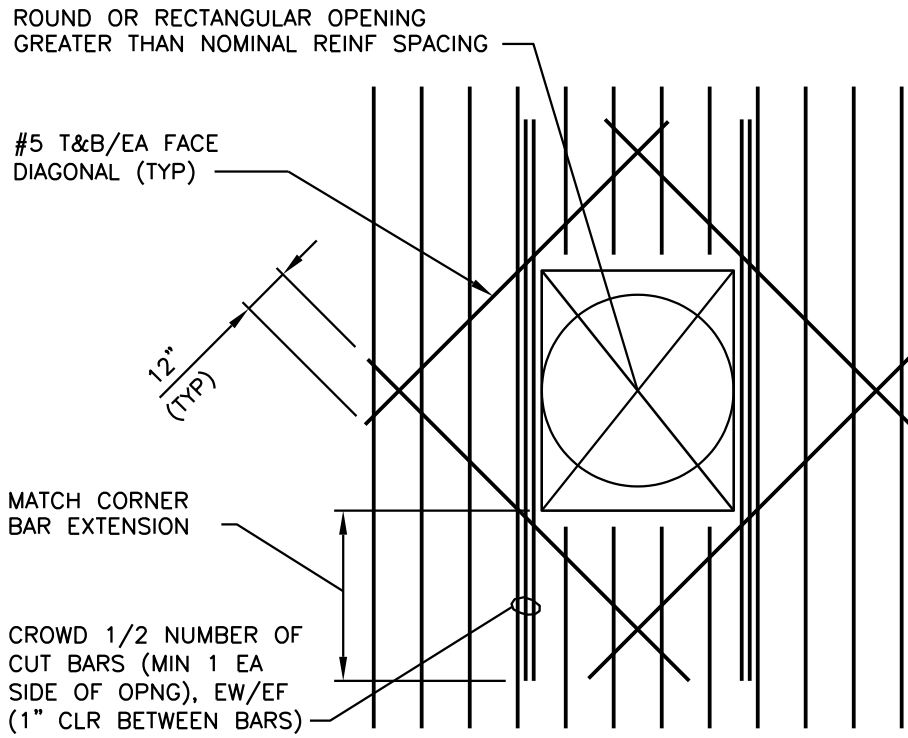

- NOTE:
1. BARS SHOWN IN VERT DIRECTION ONLY FOR CLARITY. TREAT BARS IN HORIZ DIRECTION IN SAME MANNER.
 2. DETAIL IS APPLICABLE AT ALL FORMED OPNGS LARGER IN ANY DIRECTION THAN THE NOMINAL BAR SPACING.


WALL/SLAB OPENING DETAIL

NOT TO SCALE

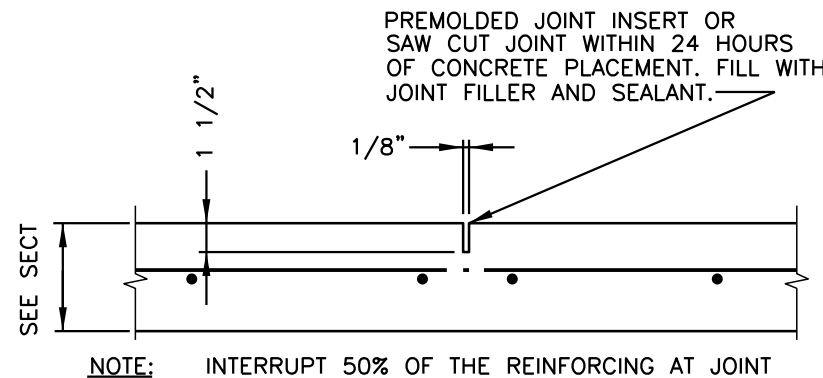

SLAB ON GRADE CONTROL JOINT DETAIL

NOT TO SCALE

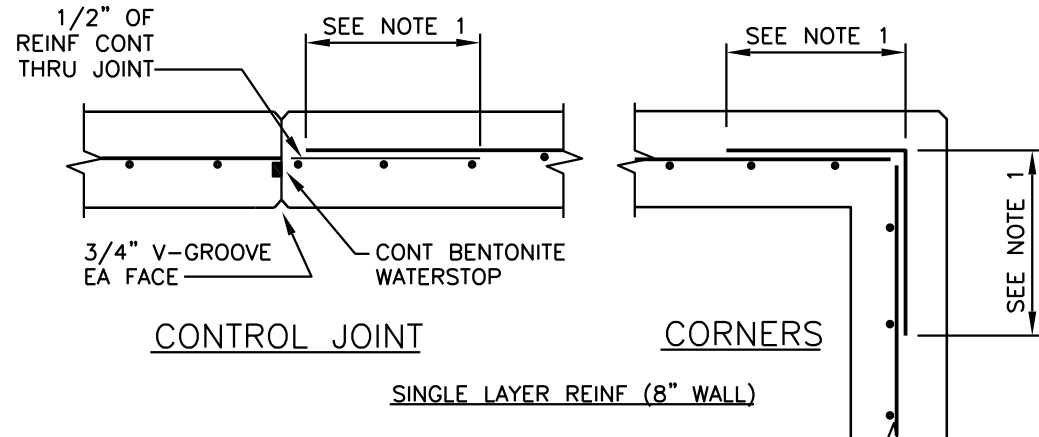


NOTE:

1. REINFORCING STEEL SHALL BE LAPPED PER SPECIFICATION SECTION 03001.

HORIZONTAL WALL REINFORCING DETAILS

PLAN VIEW

NOT TO SCALE

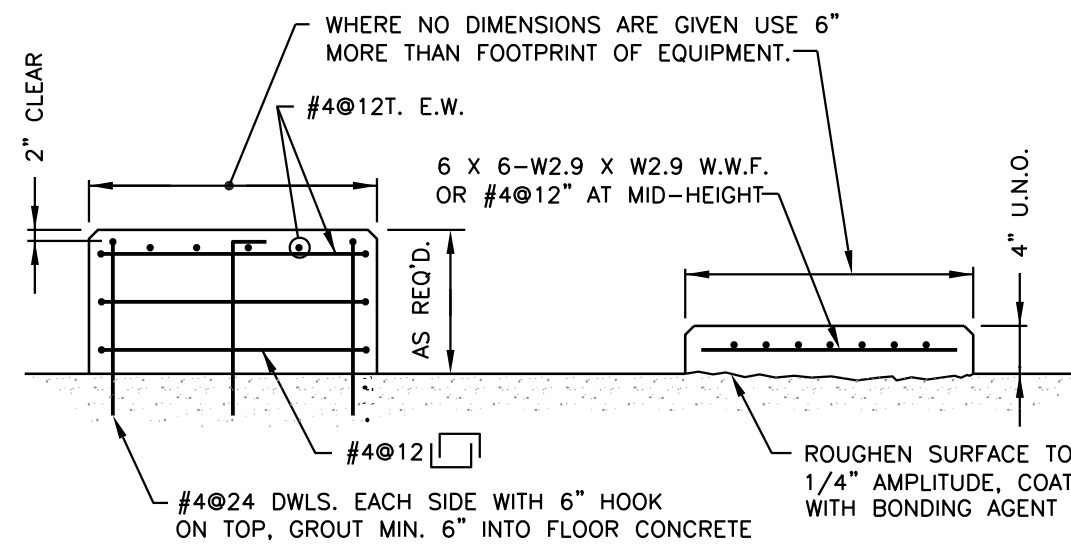

TYPICAL EQUIP./PUMP PAD

HOUSE KEEPING PAD

(USE WHERE NOTED ON DWGS.)

REINFORCEMENT DETAILS FOR EQUIPMENT PADS

NOT TO SCALE

GENERAL STRUCTURAL NOTES

A. FOUNDATIONS

1. MAXIMUM ALLOWABLE SOIL PRESSURE = 2,000 PSF.
2. EXCAVATIONS AND FORMS SHALL BE REVIEWED BY THE ENGINEER PRIOR TO PLACING CONCRETE.
3. ALL FILL INSIDE BUILDING SHALL BE SELECT MATERIAL FREE FROM ROOTS, TRASH, WOOD SCRAPS, AND OTHER EXTRANEOUS MATERIALS. PLACE FILL IN LIFTS NOT EXCEEDING 8 INCHES AND COMPACT EACH LIFT TO 95% DENSITY AT OPTIMUM MOISTURE CONTENT AS MEASURED BY ASTM D698, EXCEPT THE TOP 12 INCHES OF SUBGRADE SHALL BE COMPACTED TO AT LEAST 98% DENSITY AT OPTIMUM MOISTURE CONTENT.

B. CONCRETE

1. CONCRETE SHALL DEVELOP A MINIMUM COMPRESSIVE STRENGTH AT 28 DAYS AS FOLLOWS:
SIDEWALKS AND LANDINGS 5,000 PSI
ALL OTHER CONCRETE 4,500 PSI
2. ANCHOR BOLT LENGTHS SHOWN ON THE DRAWINGS SHALL INCLUDE HOOKS OF NOT LESS THAN 3 INCHES IN LENGTH. PROVIDE ONE NUT AND ONE WASHER WITH EACH ANCHOR BOLT UNLESS OTHERWISE NOTED.

C. REINFORCING STEEL

1. BARS SHALL BE ROLLED FROM NEW BILLET-STEEL CONFORMING TO ASTM A615, GRADE 60.
2. WELDED WIRE FABRIC SHALL CONFORM TO ASTM A185 OR ASTM A497.
3. DETAIL AND FABRICATE REINFORCING STEEL IN ACCORDANCE WITH "ACI DETAILING MANUAL - 1994," PUBLICATION SP-66(94).
4. REINFORCING STEEL IN PLACE SHALL BE REVIEWED BY THE ENGINEER PRIOR TO PLACING CONCRETE.
5. PROVIDE BARS AT CORNERS AND INTERSECTIONS OF THE SAME NUMBER AND SIZE AS LONGITUDINAL BARS IN SLABS, FOOTINGS AND WALLS.

D. GROUT

1. PROVIDE NON-SHRINK GROUT UNDER ALL COLUMN BASE PLATES AND BEAM BEARING PLATES. NON-SHRINK GROUT SHALL CONFORM TO CORPS OF ENGINEERS SPECIFICATION CRD-C 621-83.


E. DESIGN LIVE LOADS

STRUCTURAL MEMBERS SHALL BE DESIGNED FOR FULL DEAD LOADS AND THE FOLLOWING LIVE LOADS:

1. ROOF 20 PSF
2. WIND 90 MPH (MAX 3-SEC GUST) IBC-2001, I = 1.1, EXPOSURE C
3. FLOOR 100 PSF (LIGHT INDUSTRIAL)
4. LATERAL EARTH PRESSURE 60 PCF (AT REST)
5. SEISMIC 45 PCF (ACTIVE)
S_g = 0.25g, S₁ = 0.09g
SEISMIC USE GROUP = II, SPC = B

F. CONSTRUCTION SAFETY

1. THESE STRUCTURAL DRAWINGS DO NOT CONTAIN NECESSARY COMPONENTS FOR SAFETY DURING CONSTRUCTION.
2. THE CONTRACTOR SHALL PROVIDE ADEQUATE TEMPORARY BRACING, SHORING AND GUYING OF FRAMING AGAINST WIND, CONSTRUCTION LOADS AND OTHER TEMPORARY FORCES UNTIL SUCH PROTECTION IS NO LONGER REQUIRED FOR THE SAFE SUPPORT OF THE FRAMING.

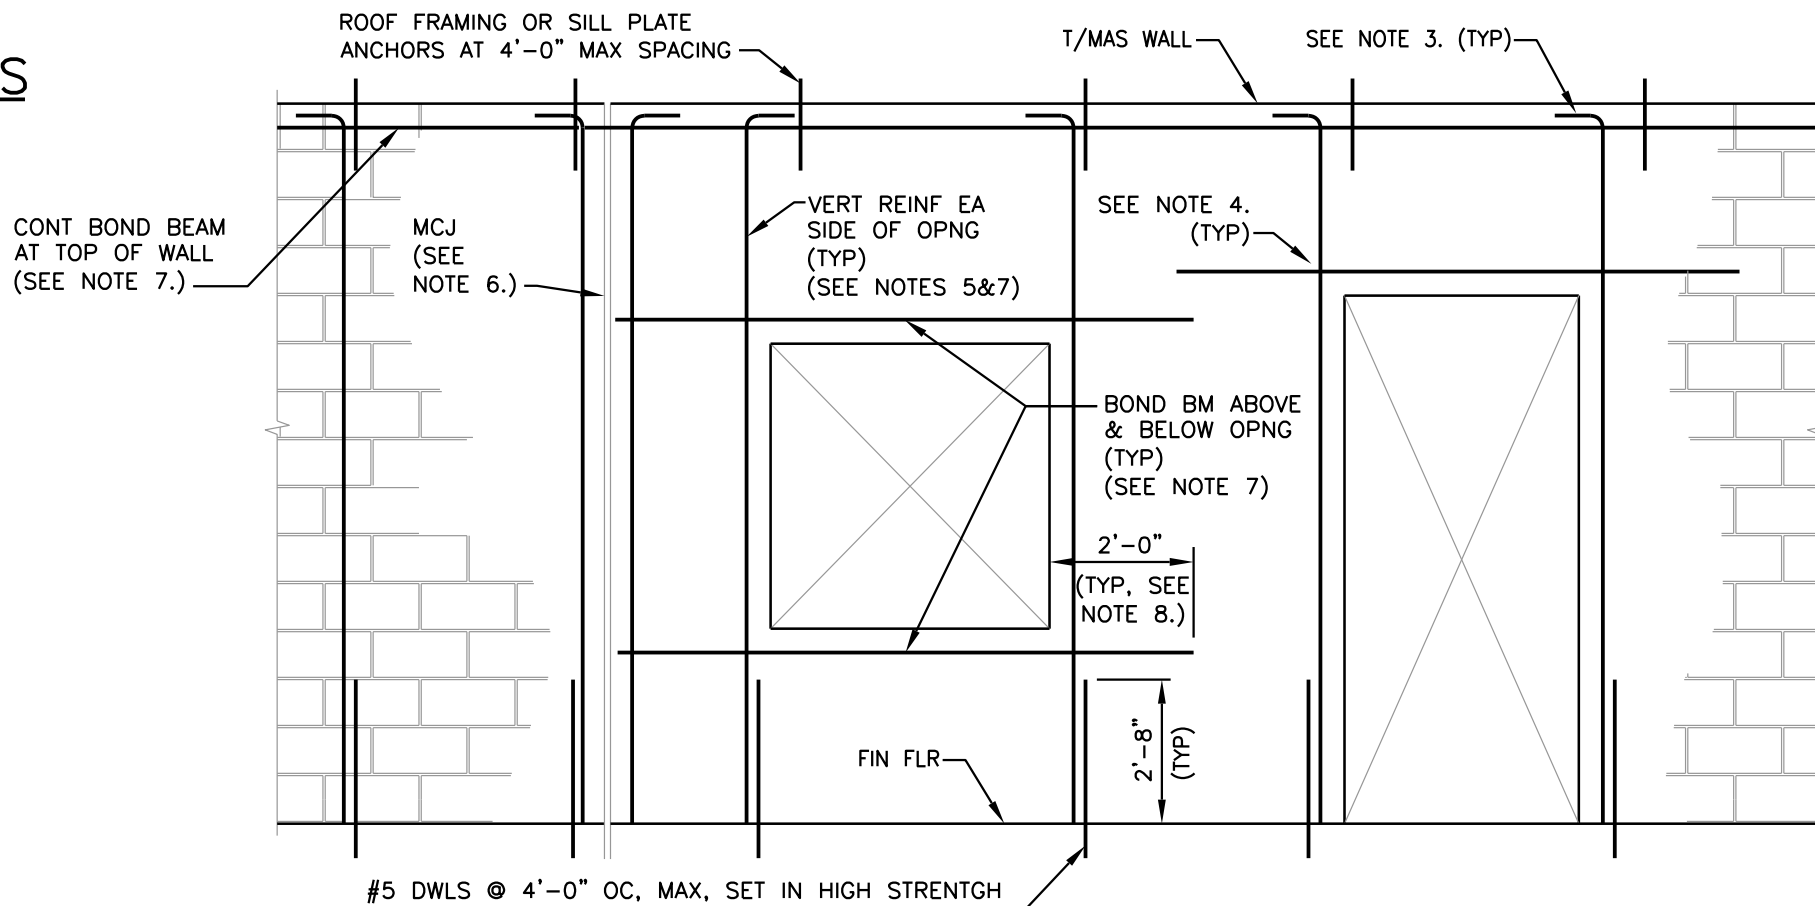

NOTE:

1. REINFORCING TYPICAL AT INTERIOR AND EXTERIOR WALLS AS NOTED.
2. MAXIMUM SPACING BETWEEN VERT REINF FOR EXTERIOR WALLS SHALL BE 8'-0". MAXIMUM VERT REINF SPACING FOR INTERIOR MASONRY PARTITION WALL SHALL BE 4'-0". SEE STRUCTURAL DWGS FOR ADDL REINF LOCATIONS.
3. VERT REINF FOR EXTERIOR WALLS SHALL TERMINATE W/ STANDARD HOOK 2" CLR FROM TOP OF BOND BEAM.
4. VERT REINF SHALL BE CONTINUOUS THROUGH BOND BEAM BY PROVIDING 3" DIAMETER OPENING IN BOTTOM OF BOND BEAM.
5. WHERE OPNG OCCURS ABOVE A HORIZ BOND BM, BOTTOM OF VERT REINF SHALL BE TERMINATED IN BOTTOM OF BOND BM W/ STD HK.
6. PROVIDE VERT REINF CELL EA SIDE OF MASONRY CONTROL JOINT. JOINT SHALL BE CONTINUOUS FROM TOP OF FOOTING TO TOP OF WALL. SEE ARCH DWGS FOR MCJ LOCATIONS.
7. BOND BM REINF & VERT REINF SHALL BE 1-#5 CONT, U.N.O. VERT REINF SHALL BE CENTERED IN CELL. BOND BM REINF SHALL BE CENTERED IN WALL AND LOCATED 2" ABOVE BOT OF BOND BM.
8. WHERE ADJACENT OPNG OCCURS WITHIN 2'-0", TERMINATE BOND BM AT EDGE OF ADJACENT OPENING.

MASONRY WALL SEISMIC REINFORCING DETAIL

(SINGLE WYTHE WALL)
NTS


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AUTOMATIC STRAINER NOTES

1. AUTOMATIC STRAINER SHALL BE HAYWARD 6" MODEL 596 AUTOMATIC SELF CLEANING STRAINER. STRAINER SHALL BE CAST IRON CLASS 125 FLANGE 150 PSI WITH THREADED BACKWASH CONNECTION, ½ HP BACKWASH ARM MOTOR, AND A DURAWEDGE STAINLESS STEEL SCREEN ELEMENT HAVING AN OPENING OF 0.015" (40 MESH).
2. AUTOMATIC STRAINER CONTROL SYSTEM SHALL BE HAYWARD AUTOMATIC CONTROL SYSTEM (ACS-4) WITH THE CAPABILITY OF CONNECTING & TRANSMITTING INFORMATION TO THE PLANT PLC.
3. ACS-4 CONTROL SYSTEM COMPONENTS:

SYSTEM FEATURES A NEMA 4 RATED (WATER & DUST TIGHT) PANEL BOX COMPLETE WITH ADJUSTABLE TIMER, DIFFERENTIAL PRESSURE OVERRIDE, 10 AMP CONTROL RELAY FOR BACKWASH VALVE ACTIVATION, DISPLAY LIGHTS TO INDICATE POWER ON BACKWASH VALVE OPEN - AND HIGH DIFFERENTIAL PRESSURE. A SELECTOR SWITCH IS ALSO INCLUDED TO MANUALLY CONTROL THE BACKWASH VALVE FUNCTIONS OF OFF OR ON-AUTO. THE PANEL ALSO HAS CONTACT TERMINALS FOR A MOTOR STARTER, AN EXTERNAL ALARM CONNECTION, A MOTOR STARTER, A 460V/120V DUAL VOLTAGE TRANSFORMER, & INCLUDES THE MOTOR STARTER & NECESSARY CONTROLS FOR THE AURORA MODEL 321 PUMP. THE PANEL REQUIRES 110 VAC INPUT & IS CSA APPROVED. THE PANEL HAS A DIFFERENTIAL PRESSURE SWITCH & AN ELECTRICALLY ACTUATED BALL VALVE THAT CONTROLS THE BACKWASH FUNCTION.
4. CONTROL SYSTEM OPERATION:

SYSTEM SHALL OPERATE IN WHAT HAYWARD DEFINES AS "AUTOMATIC INTERMITTENT" MODE. THIS MODE IS ADJUSTABLE BY SETTING THE TIMER IN THE PANEL THAT CONTROLS THE FREQUENCY OF BACKWASHING & THE "OPEN" TIME OF THE BACKWASH VALVE. THE CONTROL SYSTEM SHALL ALSO MONITOR THE DIFFERENTIAL PRESSURE ACROSS THE STRAINER. BACKWASH SHALL BE INITIATED IF THE DIFFERENTIAL PRESSURE RISES ABOVE 2 PSI ACROSS THE STRAINER. THE DIFFERENTIAL PRESSURE SWITCH SHALL COMPENSATE FOR SUDDEN HIGH LOADINGS BY OVERRIDING THE TIME CYCLE & INITIATING BACKWASH SHOULD THE DIFFERENTIAL PRESSURE RISE ABOVE THE SET POINT.

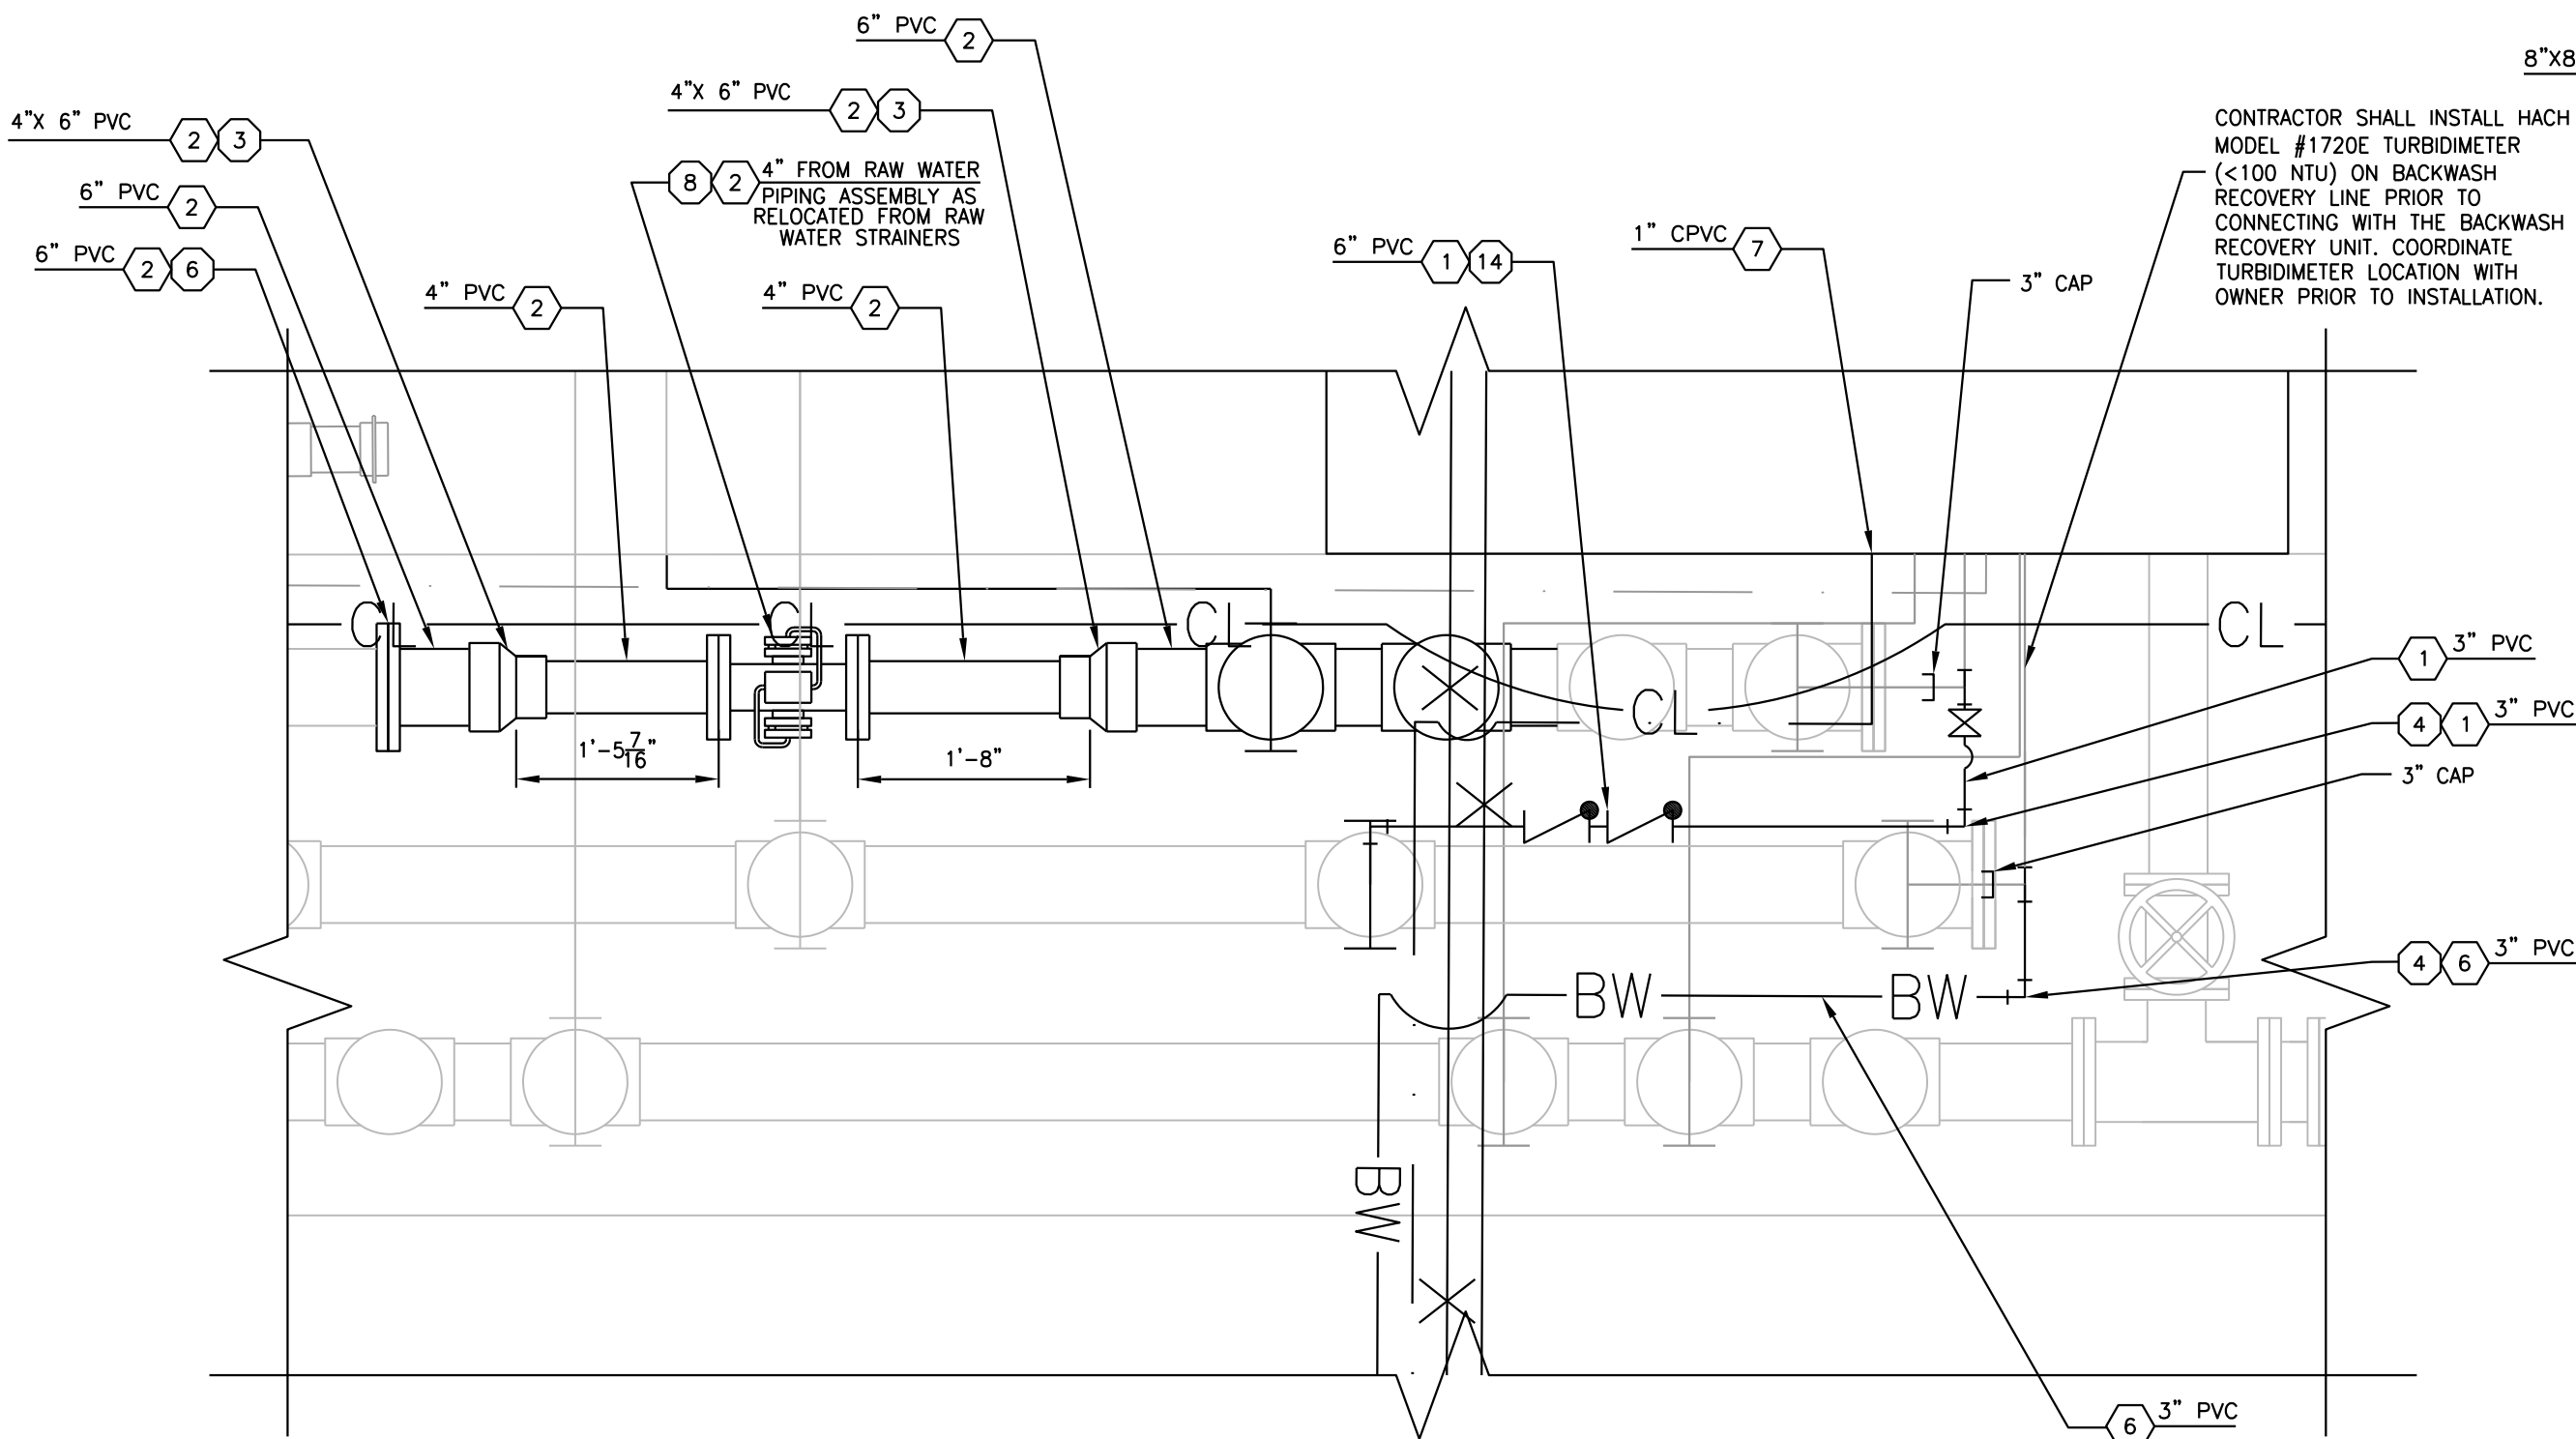

FLOWMETER & BACKWASH RECOVERY CONNECTION DETAIL

NOT TO SCALE

FLOWMETER SPECIFICATIONS:

1. CONTRACTOR SHALL FURNISH AND INSTALL AN ELECTROMAGNETIC FLOW METER (ISCO OR APPROVED EQUAL) SUITABLE FOR FIXED-SITE MEASUREMENT OF BI-DIRECTIONAL FLOW IN A FULL PIPE. THE FLOW METER SHALL CONSIST OF A FLOW TUBE AND A FLOW TRANSMITTER, WHICH SHALL INDICATE, TOTALIZE AND TRANSMIT FLOW. THE FLOW TUBE SHALL USE A SPOOL PIECE CONFIGURATION WITH FIELD-INTERCHANGEABLE SENSORS CONTAINING COILS AND ELECTRODES.
2. THE FLOW METER SHALL MEASURE, INDICATE, AND TOTALIZE FLOW RATES TO WITHIN ±0.5 PERCENT OF ACTUAL FLOW FOR VELOCITIES OF 1-50 FEET PER SECOND.

3. ACCURACY SHALL NOT BE AFFECTED BY CHANGES IN PERCENT SOLIDS OR CHANGES IN FLUID DENSITY, TEMPERATURE OR VISCOSITY. ACCURACY SHALL NOT BE AFFECTED BY THE PRESENCE OF AIR BUBBLES TO A GREATER EXTENT THAN THE FLUID VOLUME REPRESENTED BY SUCH AIR BUBBLES.
4. MAXIMUM PRESSURE SHALL BE 150 PSI.

5. THE FLOW TRANSMITTER SHALL BE MICROPROCESSOR-BASED, SHALL CONTAIN A KEYPAD AND A 2 LINE, 32 CHARACTER, BACKLIT ALPHANUMERIC LIQUID CRYSTAL DISPLAY WITH CHARACTERS, AND SHALL BE HOUSED IN A NEMA 4X AND IP65 CAST ALUMINUM, EPOXY PAINTED ENCLOSURE SUITABLE FOR CONDUIT CONNECTIONS.

6. THE FLOW TRANSMITTER SHALL INCLUDE 2 ISOLATED CONTACT INPUTS, ACTIVATED BY CONTACT CLOSURE OR TRANSISTOR, PROGRAMMABLE TO ACKNOWLEDGE ALARMS, RESET TOTALIZERS, SELECT THE CURRENT FLOW RANGE IN FORWARD FLOW/MULTI RANGE MODE, OR INDICATE NON-FULL PIPE CONDITION, RATED 25 VOLTS DC, 15 mA.

7. THE FLOW TRANSMITTER SHALL INCLUDE AN ISOLATED, INTERNALLY POWERED 4 TO 20 mA OUTPUT INTO A MAXIMUM OF 500 OHMS. THE 4 TO 20 mA OUTPUT SHALL BE PROGRAMMABLE TO OPERATE IN EITHER FORWARD FLOW RATE, FORWARD FLOW RATE/MULTI RANGE, BIDIRECTIONAL FLOW RATE, OR BIDIRECTIONAL FLOW RATE/SPLIT RANGE MODE.

HAYWARD ACS-4 CONTROL SYSTEM PANEL. CONTRACTOR SHALL FIELD VERIFY PANEL LOCATION & COORDINATE WITH OWNER PRIOR TO INSTALLATION.

CONTRACTOR SHALL INSTALL 2" STAINLESS STEEL PIPE SUPPORTS FOR ADEQUATELY SUPPORTING THE PIPING ARRANGEMENT SHOWN ON THE DRAWINGS.

RAW WATER FLOWMETER/STRAINER MODIFICATIONS

SCALE: 3/4"=1'-0"

PIPE LEGEND


- ① RAW WATER
- ② FILTERED WATER
- ③ STORM SEWER
- ④ C.I.P. WASTE
- ⑤ PROCESS WASTE
- ⑥ BACKWASH RECOVERY
- ⑦ EFM PROCESS WATER

VALVE/FITTING LEGEND

- ① TEE
- ② TEE W/ BLIND FLANGE
- ③ REDUCER
- ④ 90° ELBOW
- ⑤ 90° ELBOW W/ BLIND FLANGE
- ⑥ FLANGE CONNECTION
- ⑦ GATE VALVE
- ⑧ FLOWMETER
- ⑨ INJECTION POINT
- ⑩ BUTTERFLY VALVE W/ PNEUMATIC ACTUATOR
- ⑪ PLUG VALVE
- ⑫ EXPANSION JOINT
- ⑬ AUTOMATIC STRAINER
- ⑭ RPZ VALVE
- ⑮ FLOW CONTROL VALVE
- ⑯ ORIFICE PLATE ASSEMBLY
- ⑰ SWING CHECK VALVE
- ⑱ BALL VALVE W/ELECTRIC ACTUATOR


FLOW CONTROL VALVE SPECIFICATIONS:

1. FLOW CONTROL VALVE SHALL BE CLA-VAL MODEL 640-01 8" BSYKC, GLOBE VALVE W/ DUCTILE IRON BODY, BRONZE TRIM OR APPROVED EQUAL.
2. ORIFICE PLATE ASSEMBLY SHALL BE CLA-VAL 8" 150G 4.0 ORIFICE PLATE WITH A 4.00" BORE OR APPROVED EQUAL

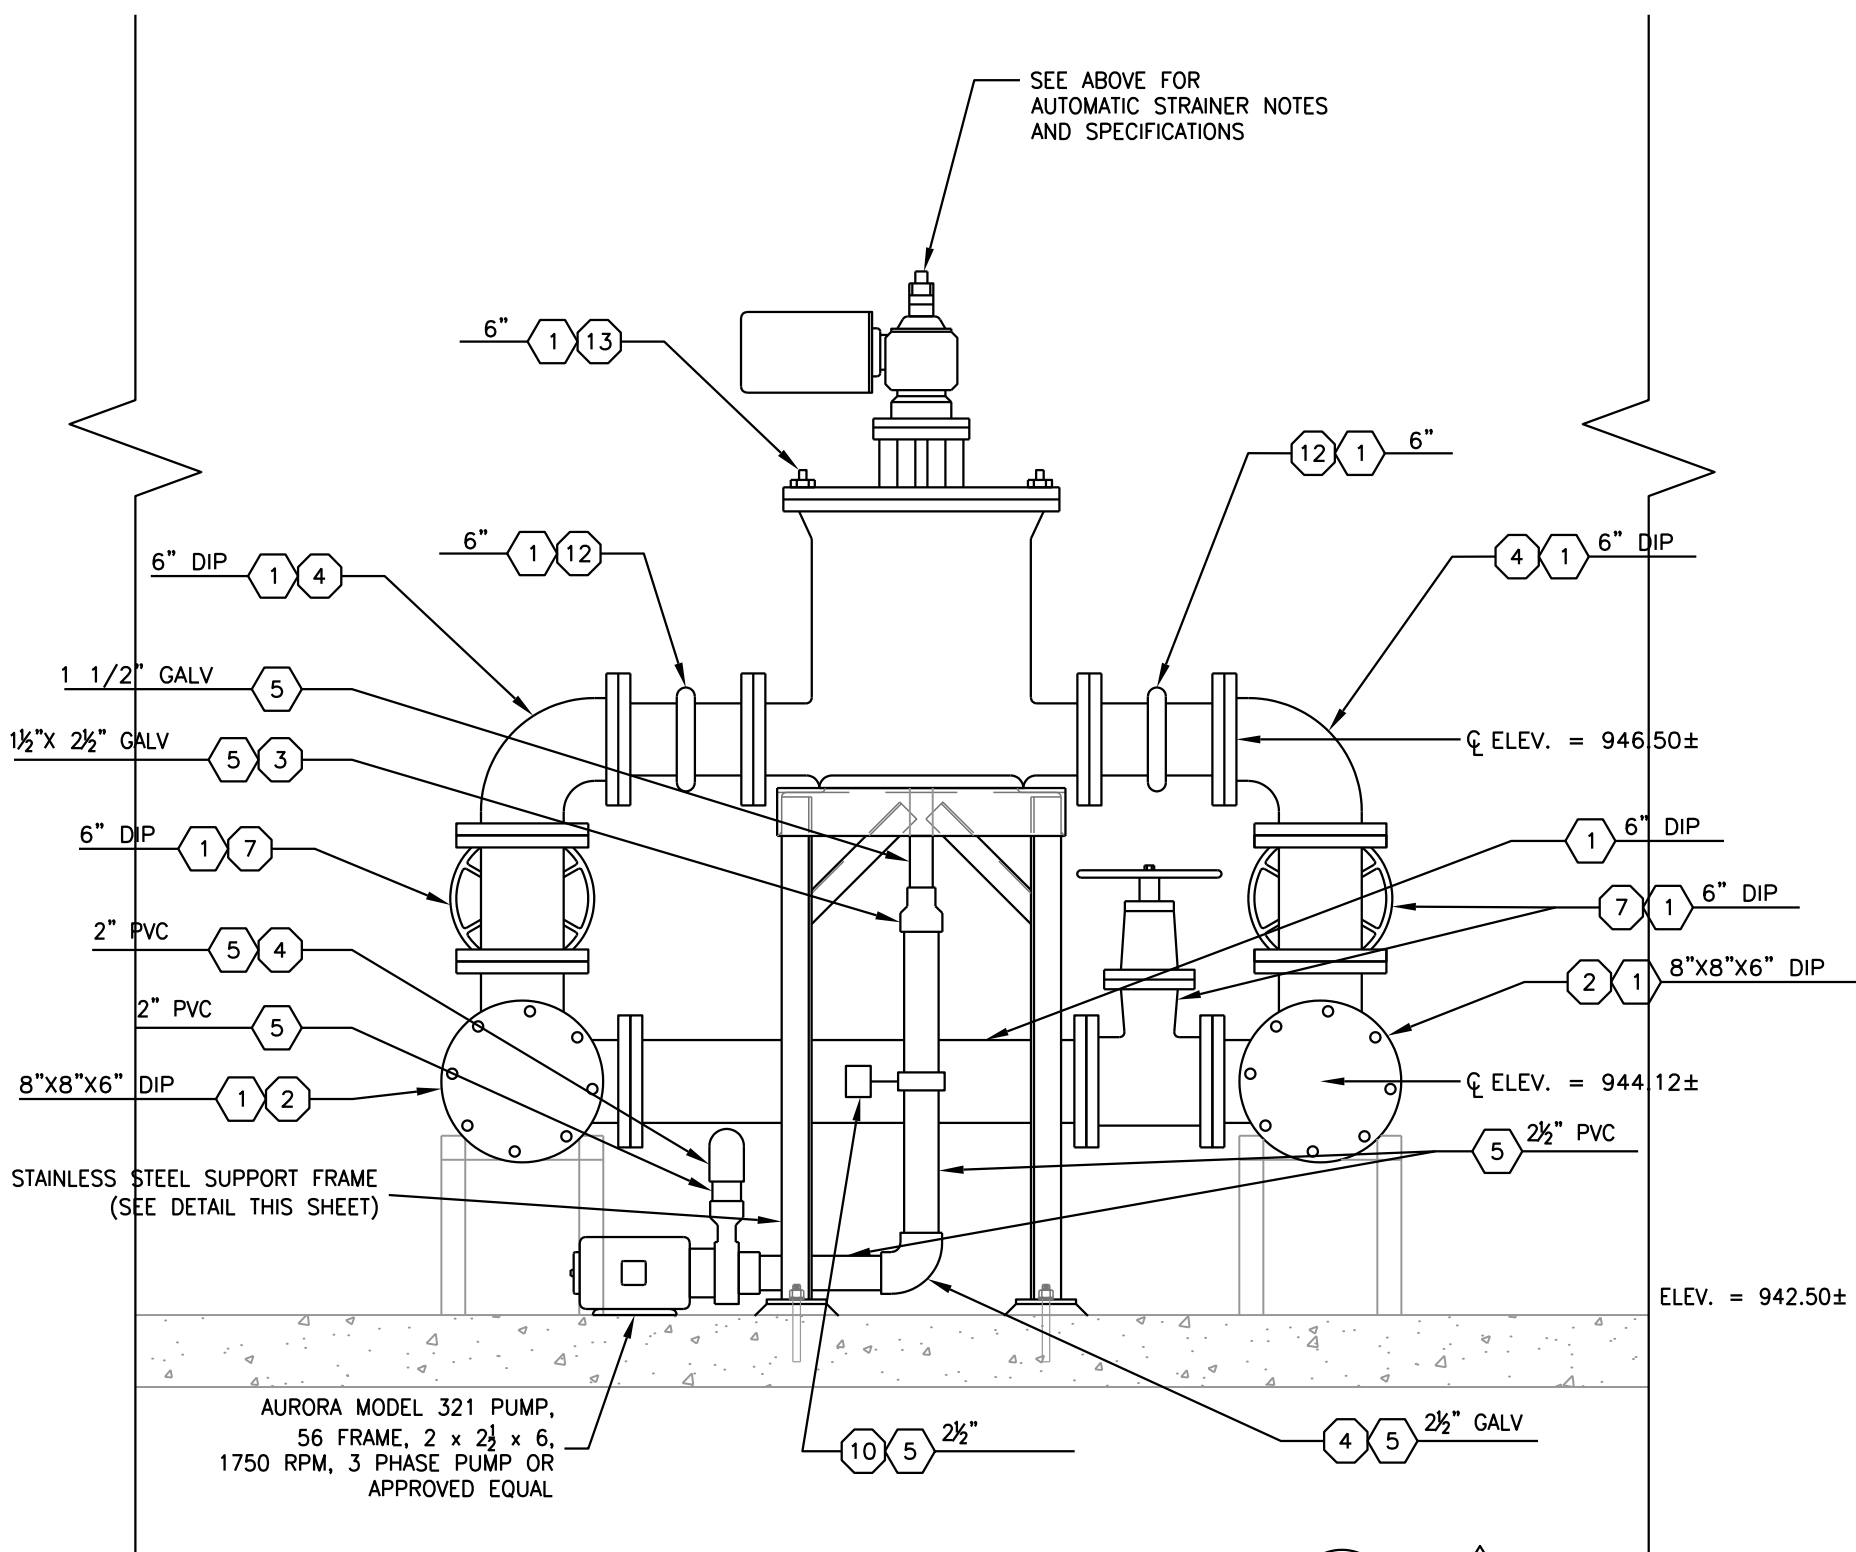

AUTOMATIC STRAINER CROSS-SECTION

3/4"=1'-0"

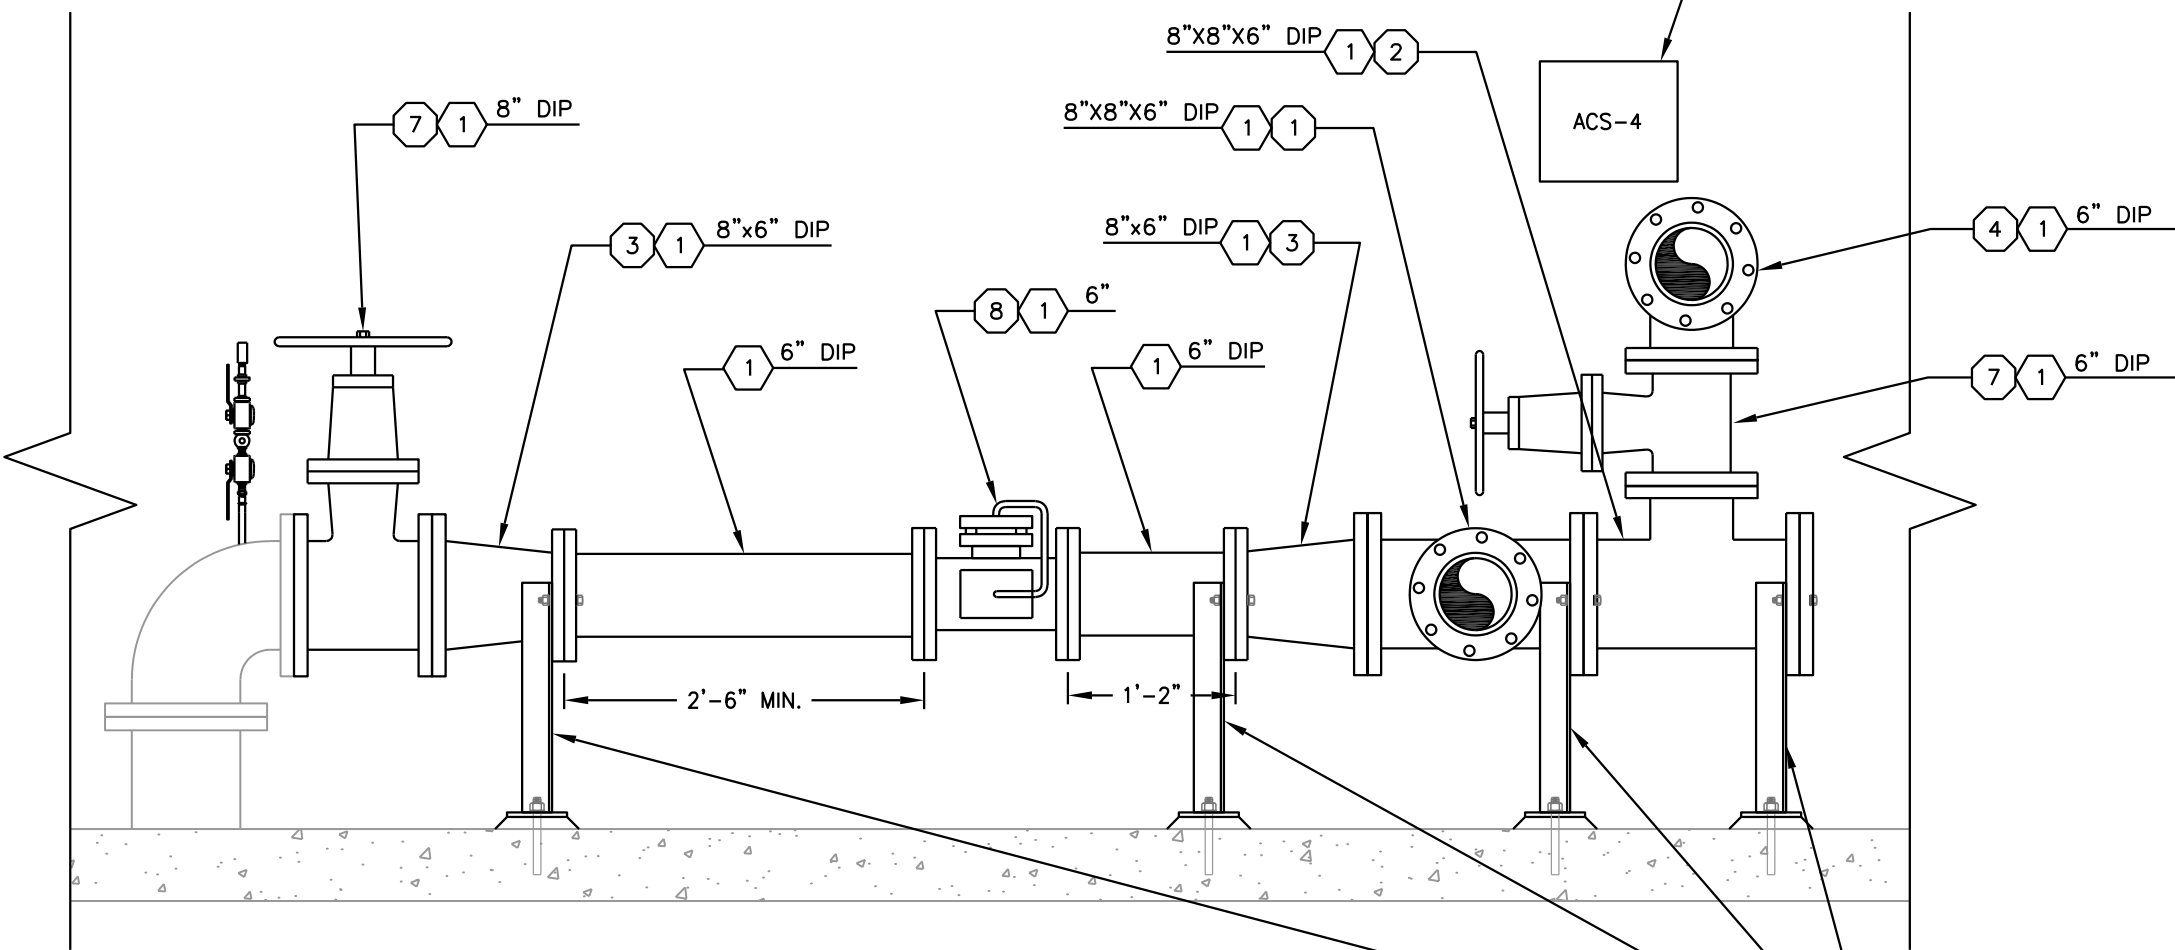

FLOWMETER CROSS-SECTION



3/4"=1'-0"

3-REF: 20280a-1, 20280-M-SC, 20280-M-TB-P1, 20280-P-TB-P1
8/03, 8/04/06, 8/07
P:20280/30 (Growing Wech)


NOTES:

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3	ISSUED FOR CONSTRUCTION														
2	REVISED PER OWNER & VDH COMMENTS					RRC	6/21/04								
	BSR	6/04		WPJ					CMT						
1	FOR APPROVAL					RRC	1/23/04								
	BSR	11/03		WPJ					CMT						
ISSUE NO.	DRAWN	DATE	CHECKED	DESIGNER	APPROVED	DATE									
PROJECT SUPERVISOR					DEPARTMENT SUPERVISOR										
							ISSUE NO.	DRAWN	DATE	CHECKED	DESIGNER	APPROVED	DATE		

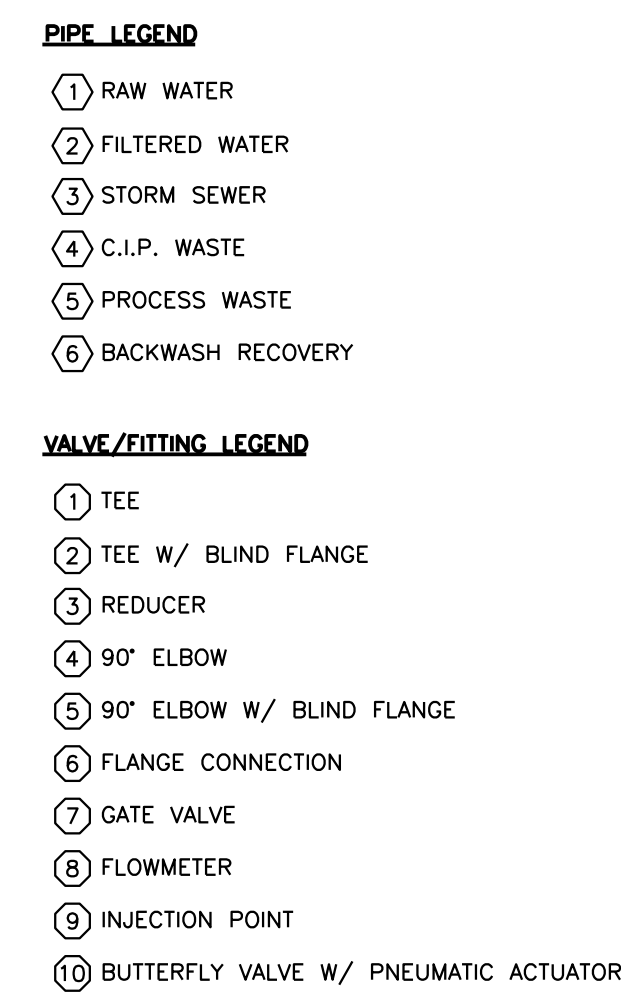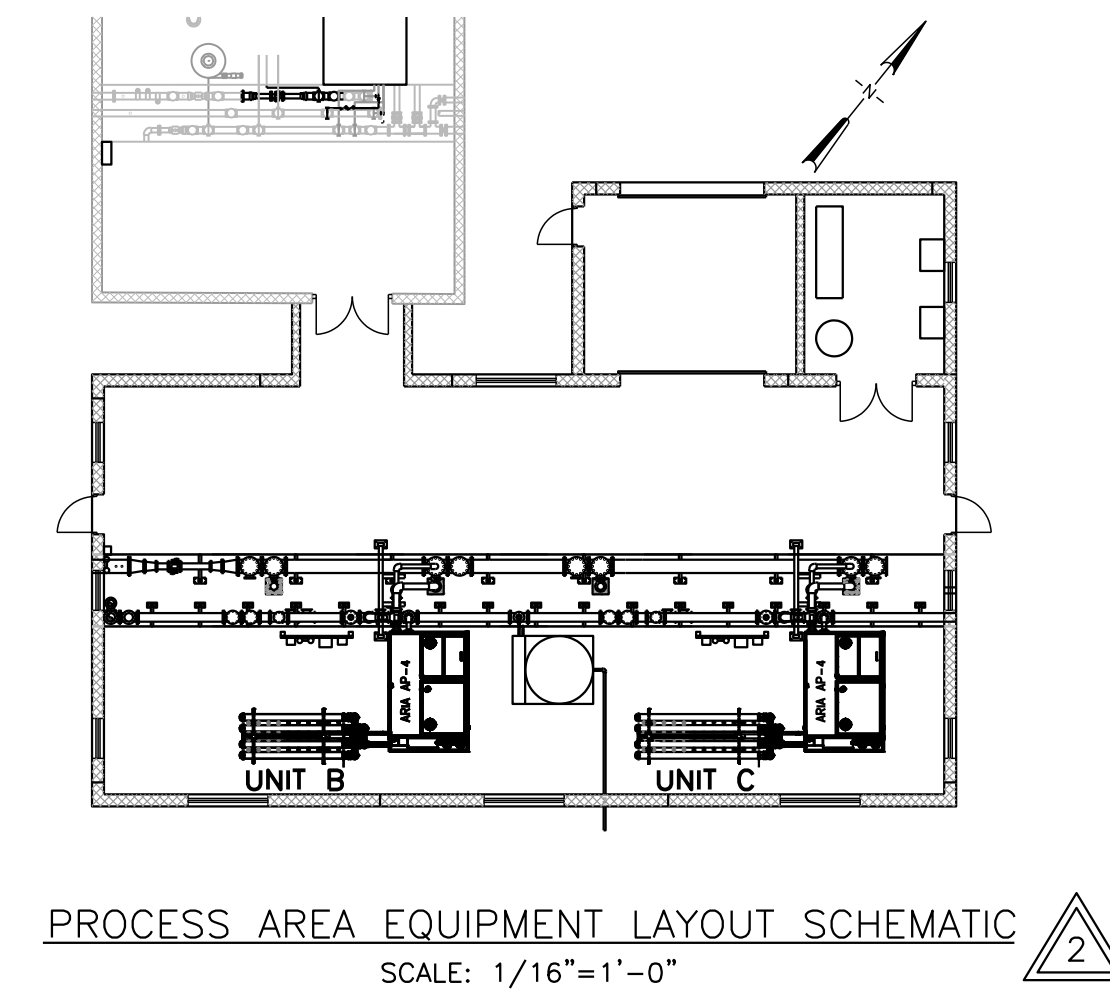

3	ISSUED FOR CONSTRUCTION												
2	REVISED PER OWNER & VDH COMMENTS				RRC	6/21/04							
	BSR	6/04	WPJ	CMT									
1	FOR APPROVAL				RRC	1/23/04							
	BSR	11/03	WPJ	CMT									
ISSUE NO.	DRAWN	DATE	CHECKED	DESIGNER	APPROVED	DATE							
PROJECT SUPERVISOR			DEPARTMENT SUPERVISOR										
						ISSUE NO.	DRAWN	DATE	CHECKED	DESIGNER	APPROVED	DATE	

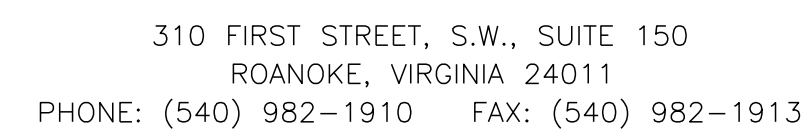

JOB NO.	20280	DRAWING	M-3	SHEET	21 OF 37
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BEDFORD COUNTY PUBLIC SERVICE AUTHORITY					
HIGH POINT WTP EXPANSION – PROJECT NO. 2003 – 028					
MECHANICAL SECTIONS & DETAILS					
JOB NO.	20280	DRAWING	M-4	SHEET	22 OF 37




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JOB NO.	20280	DRAWING	M-5	SHEET	23 OF 37
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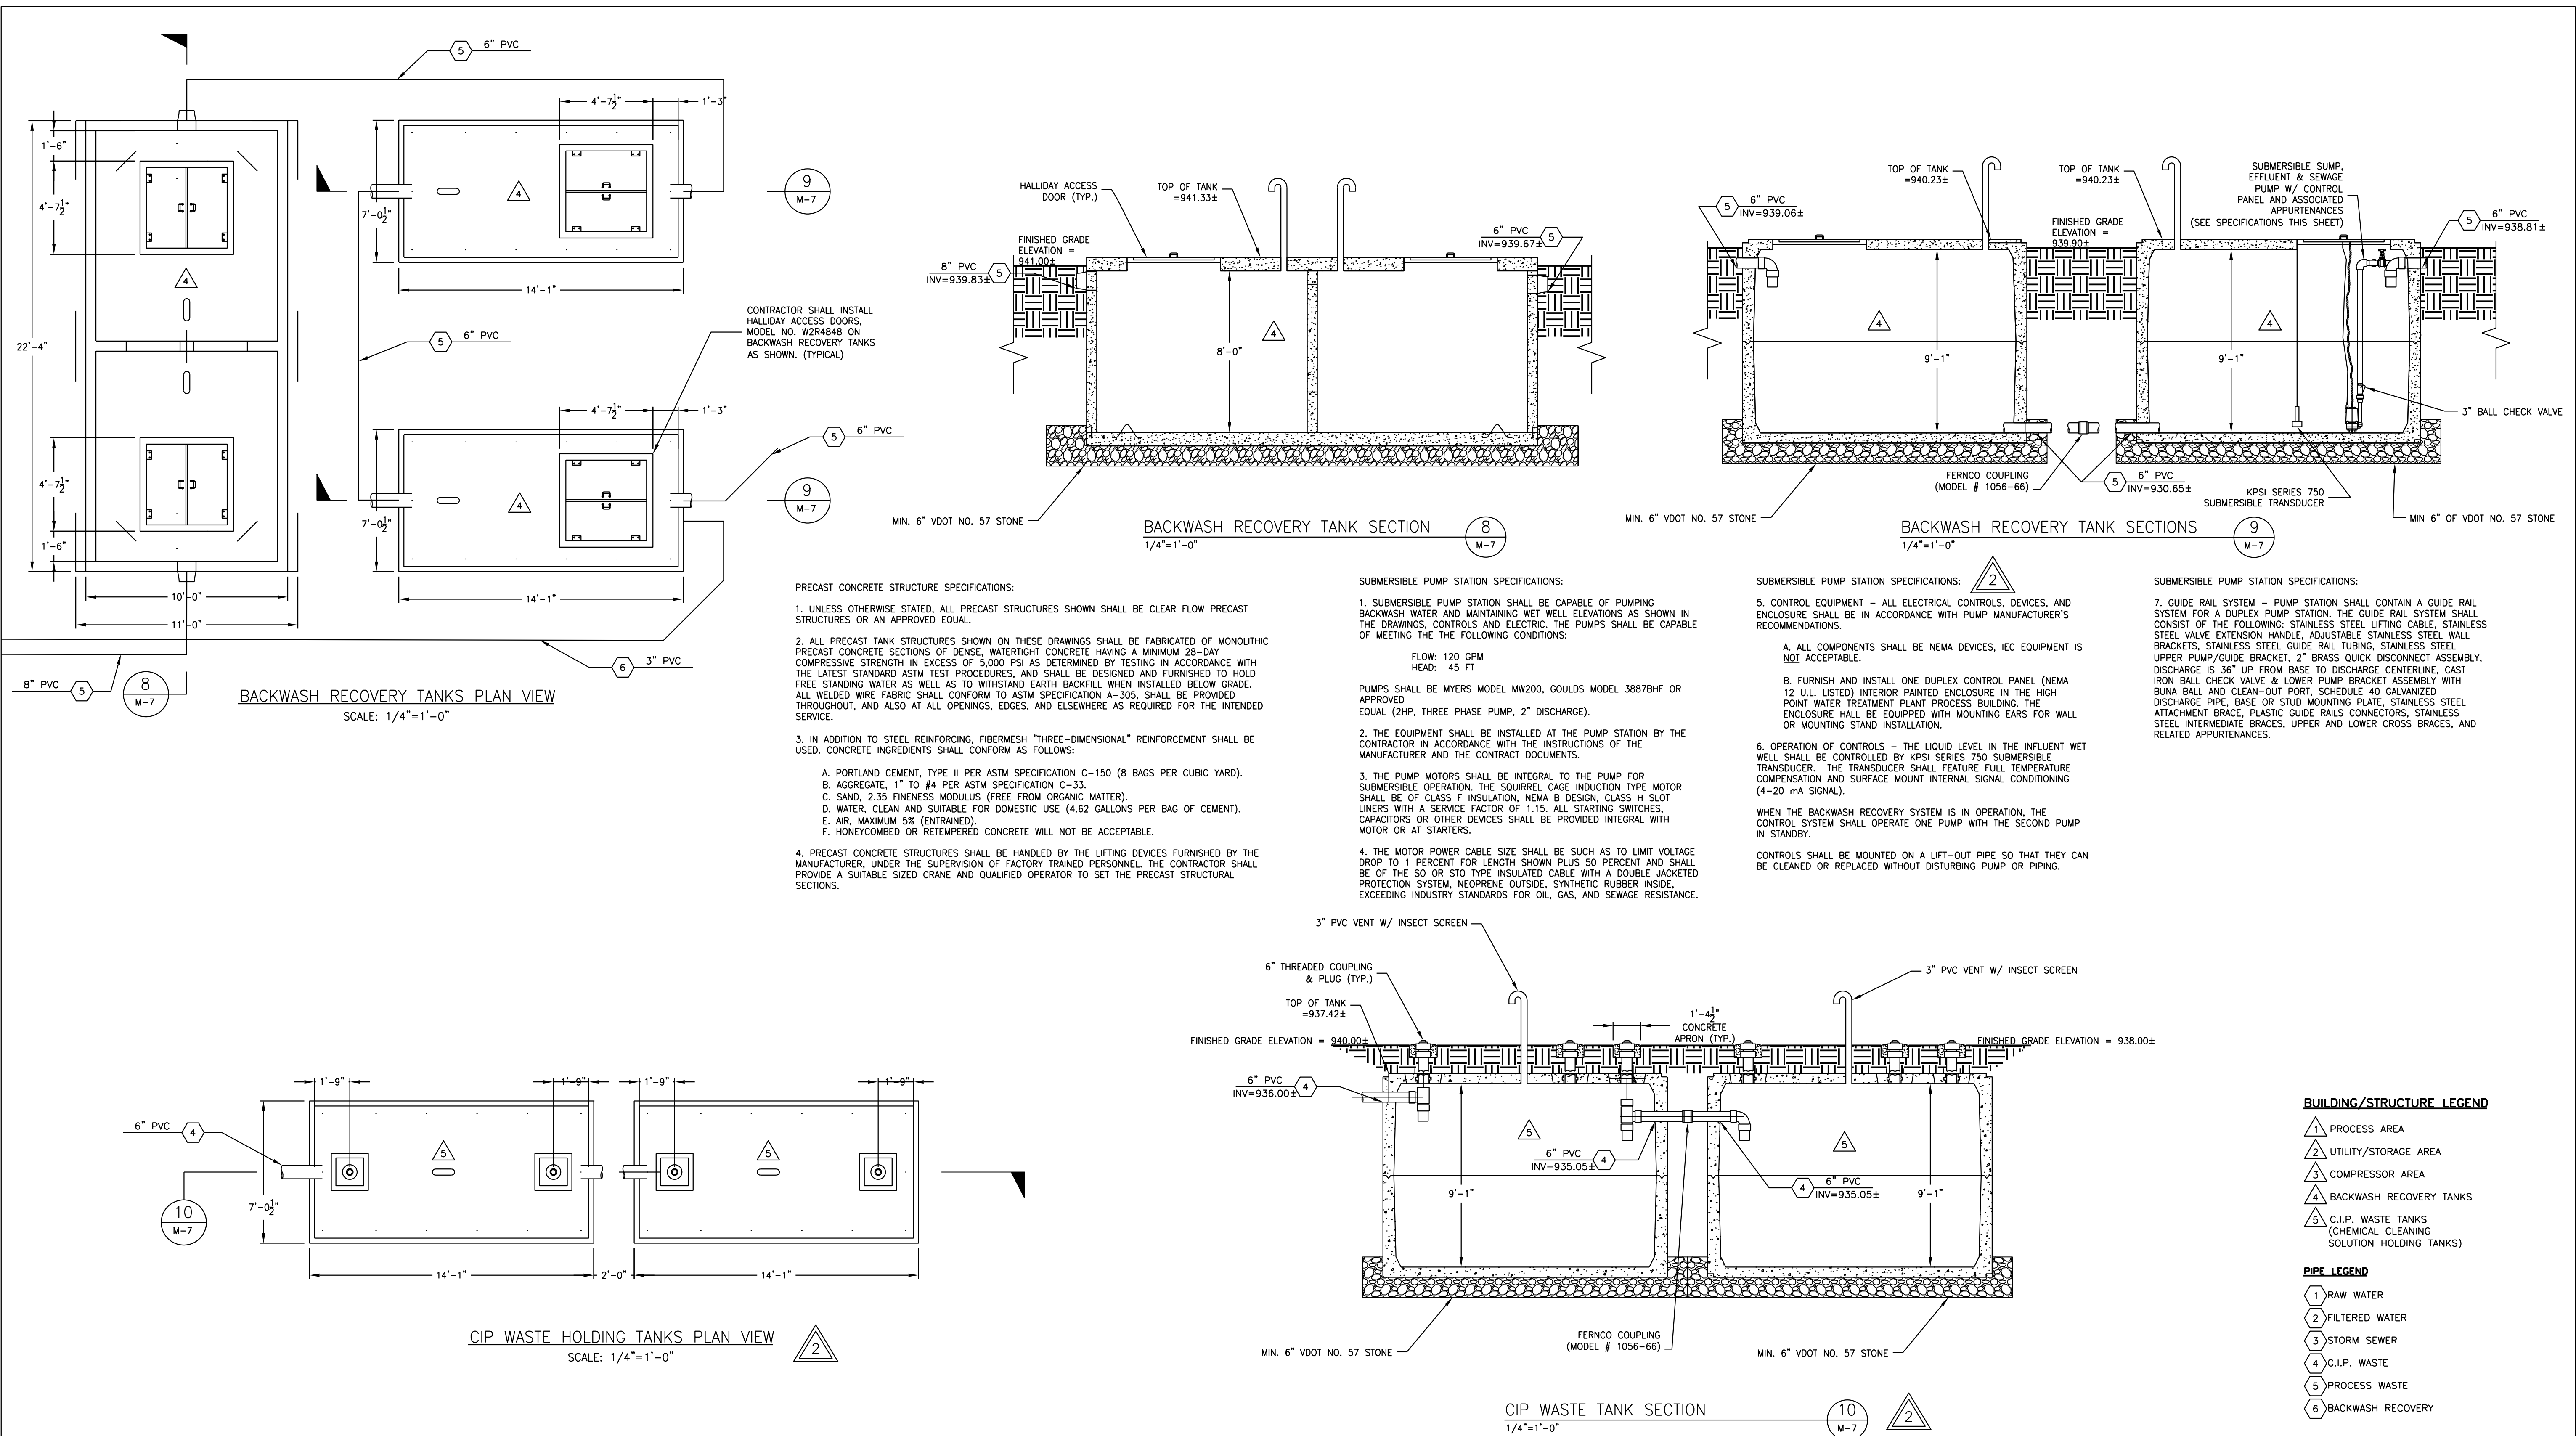
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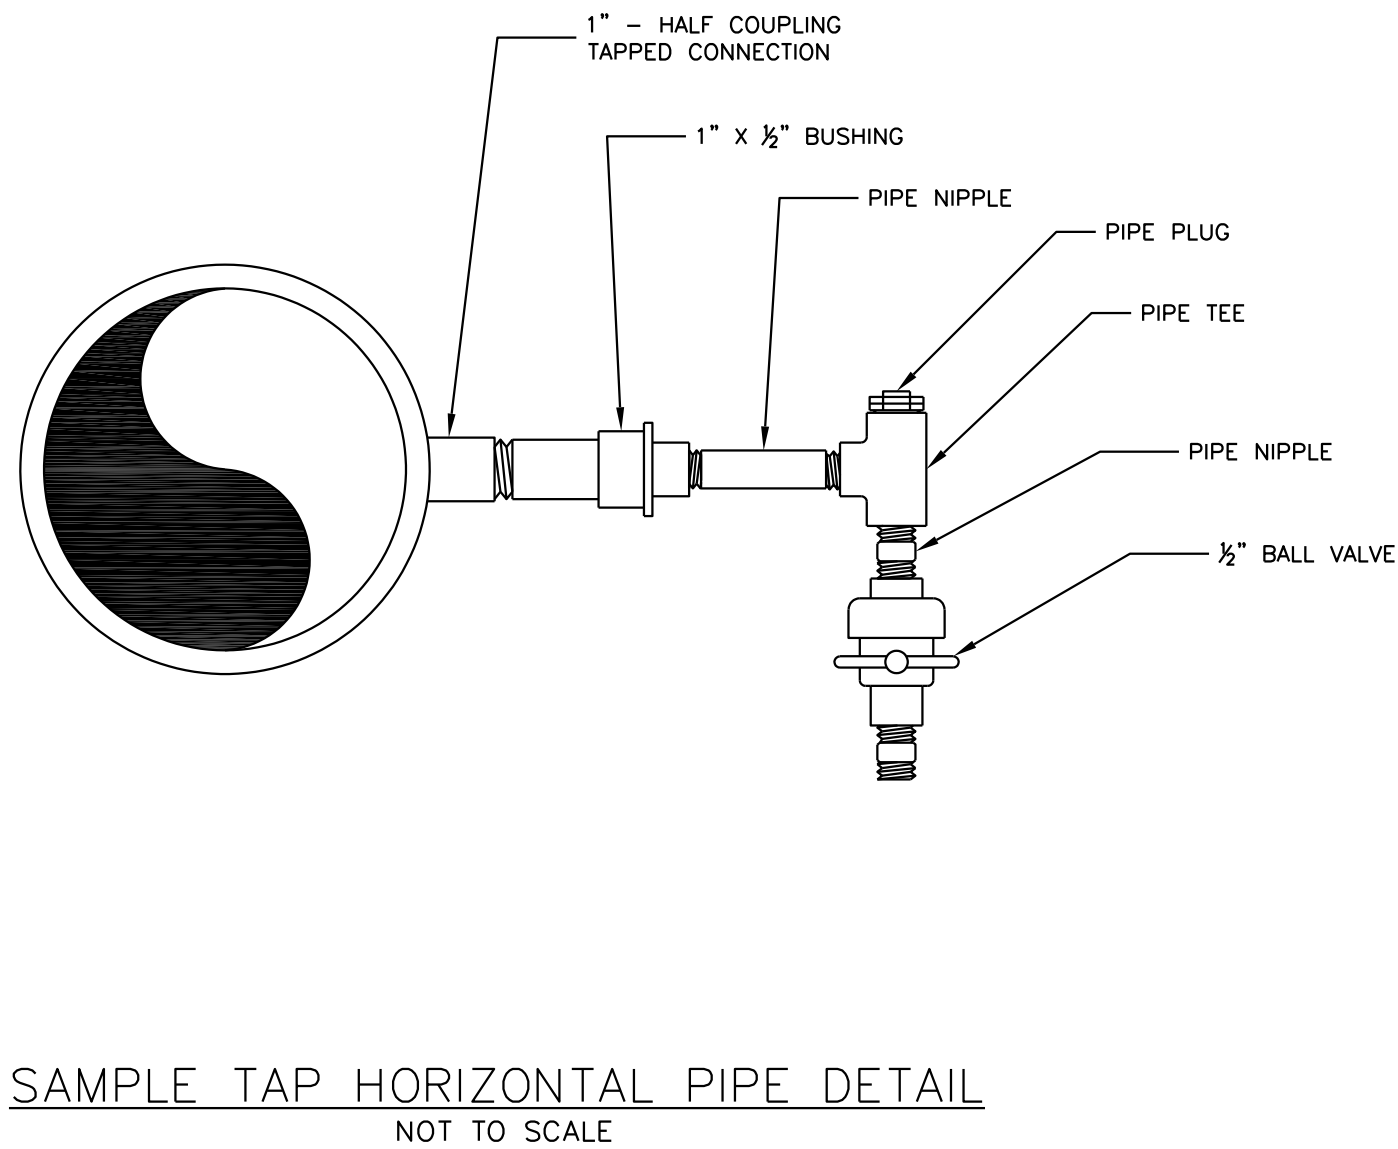
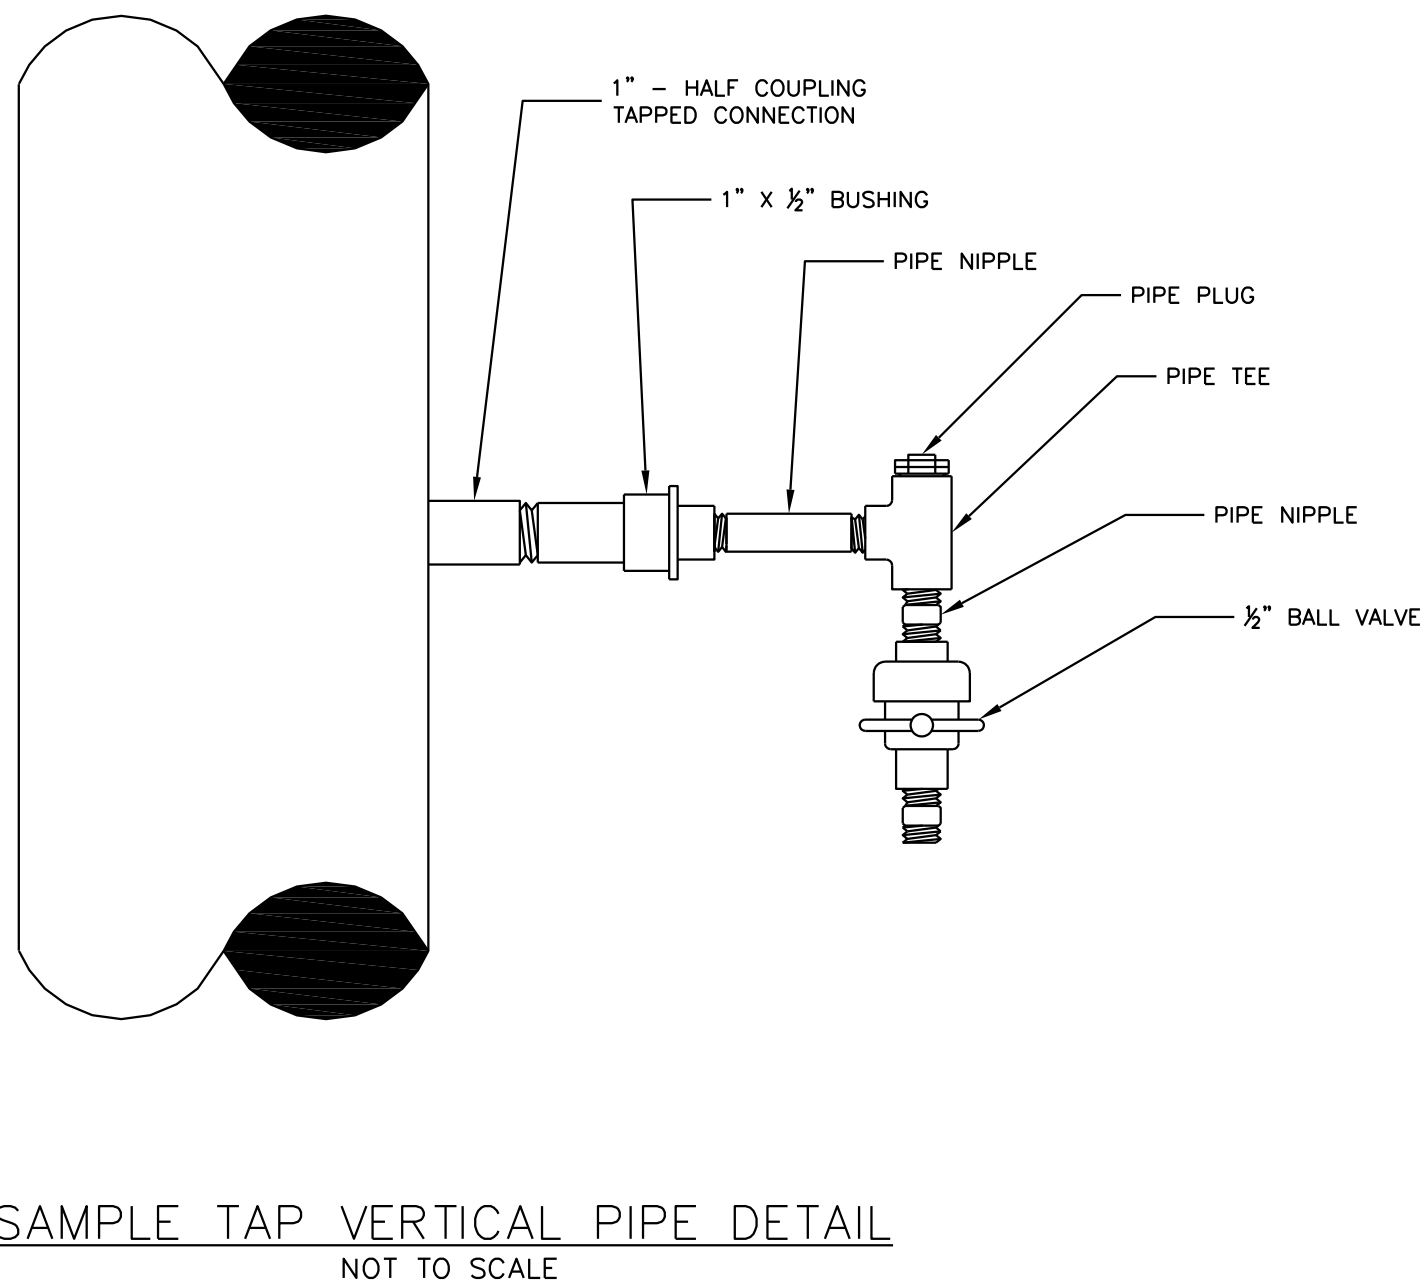
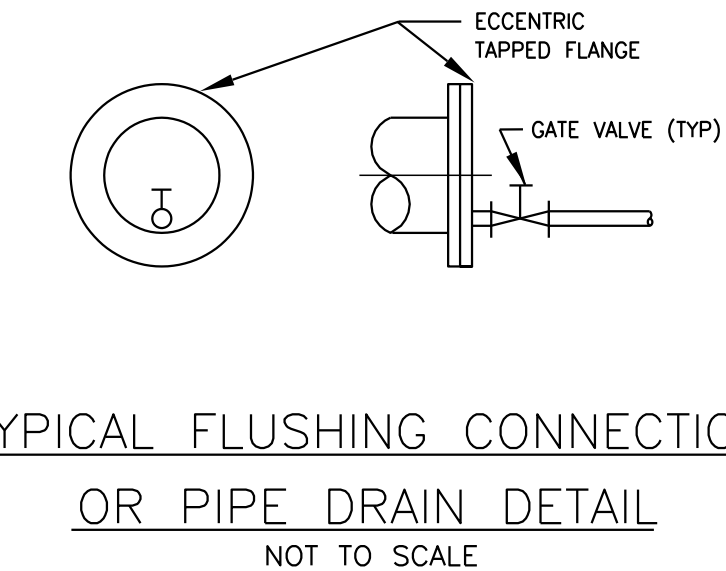
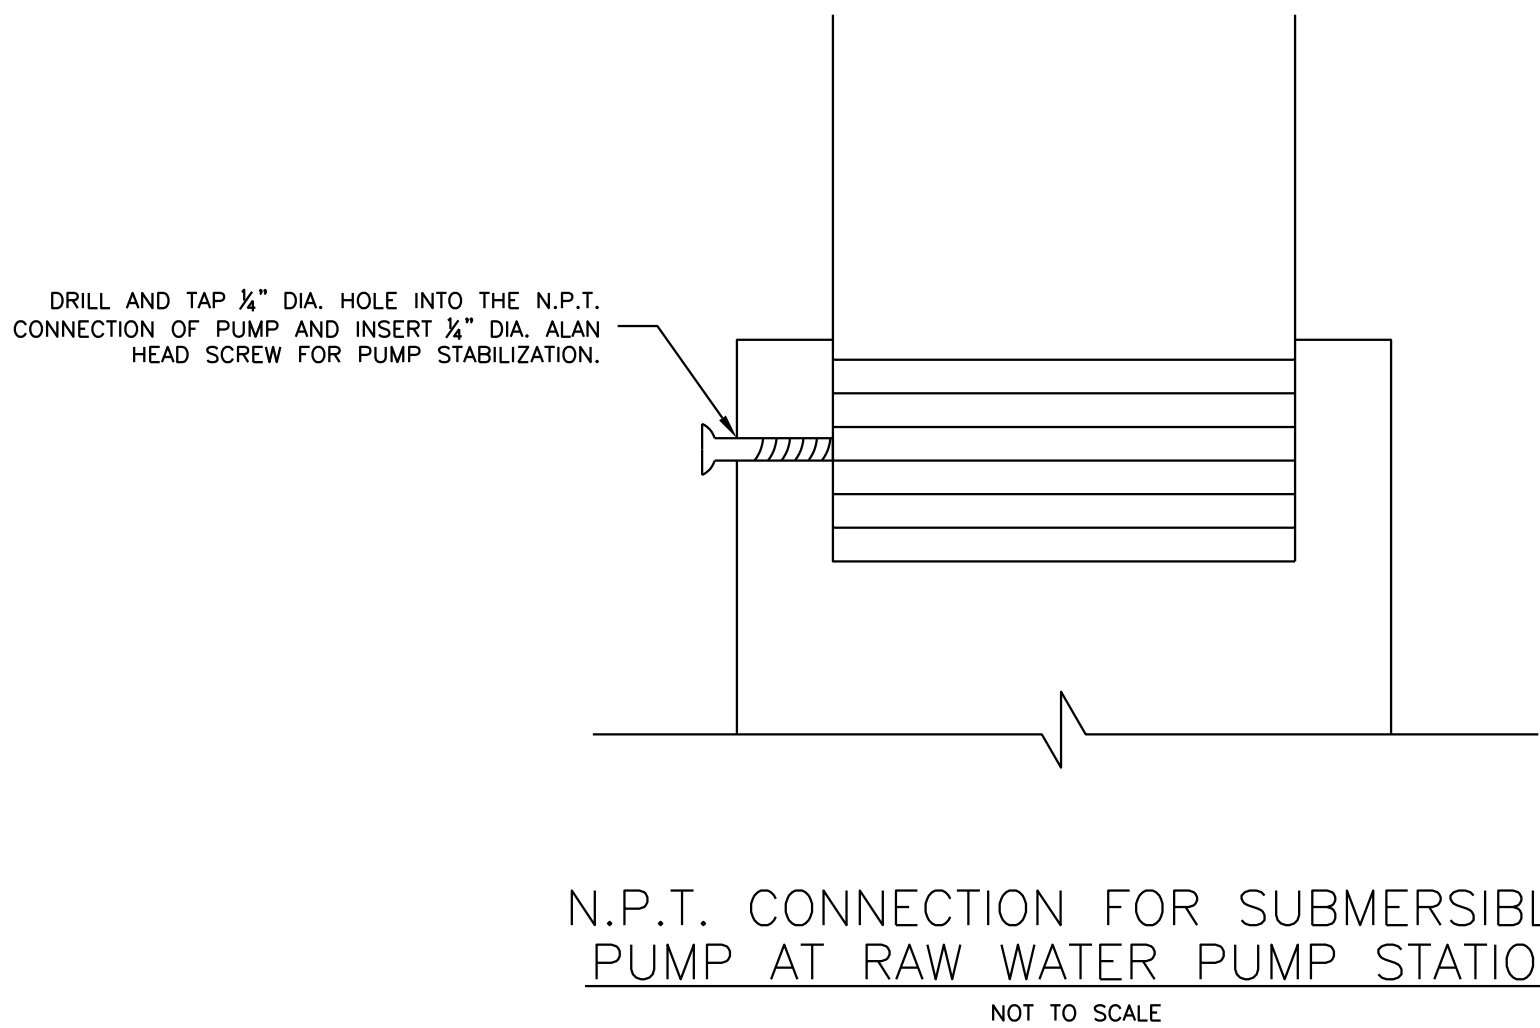
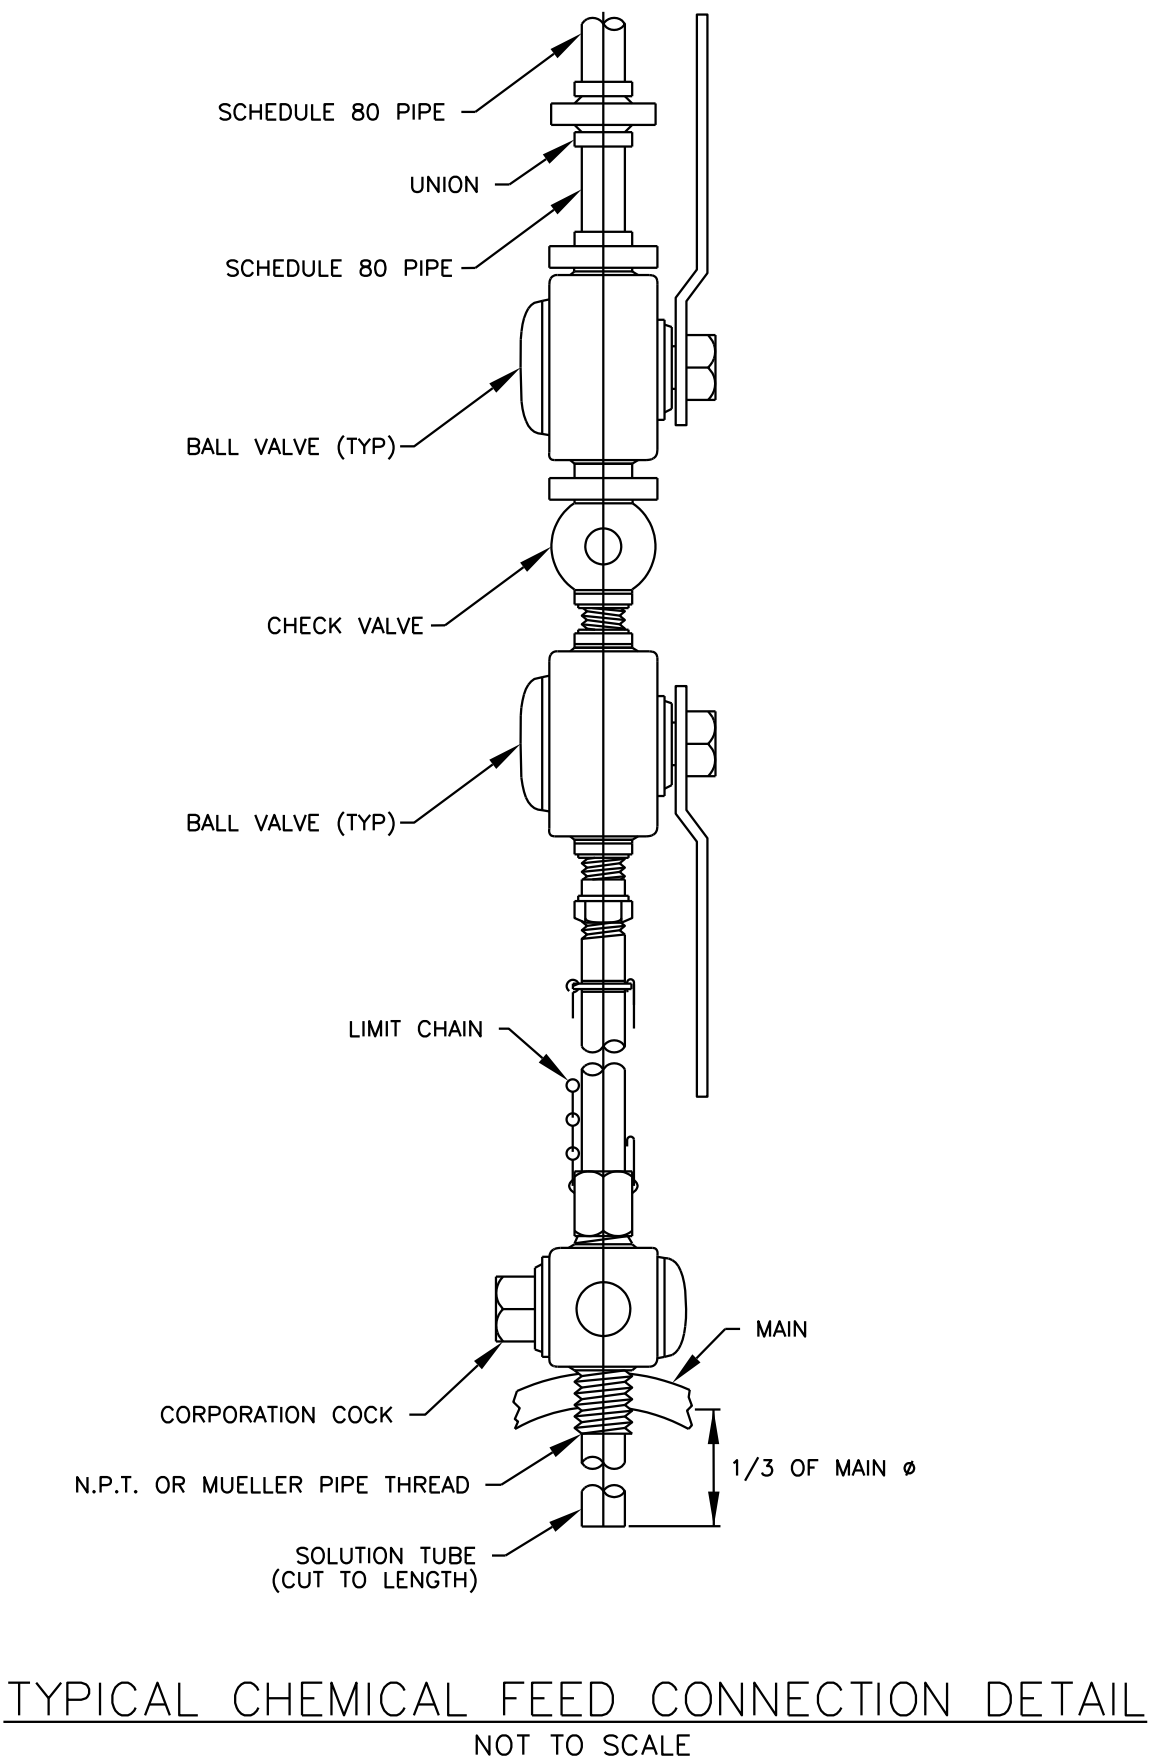
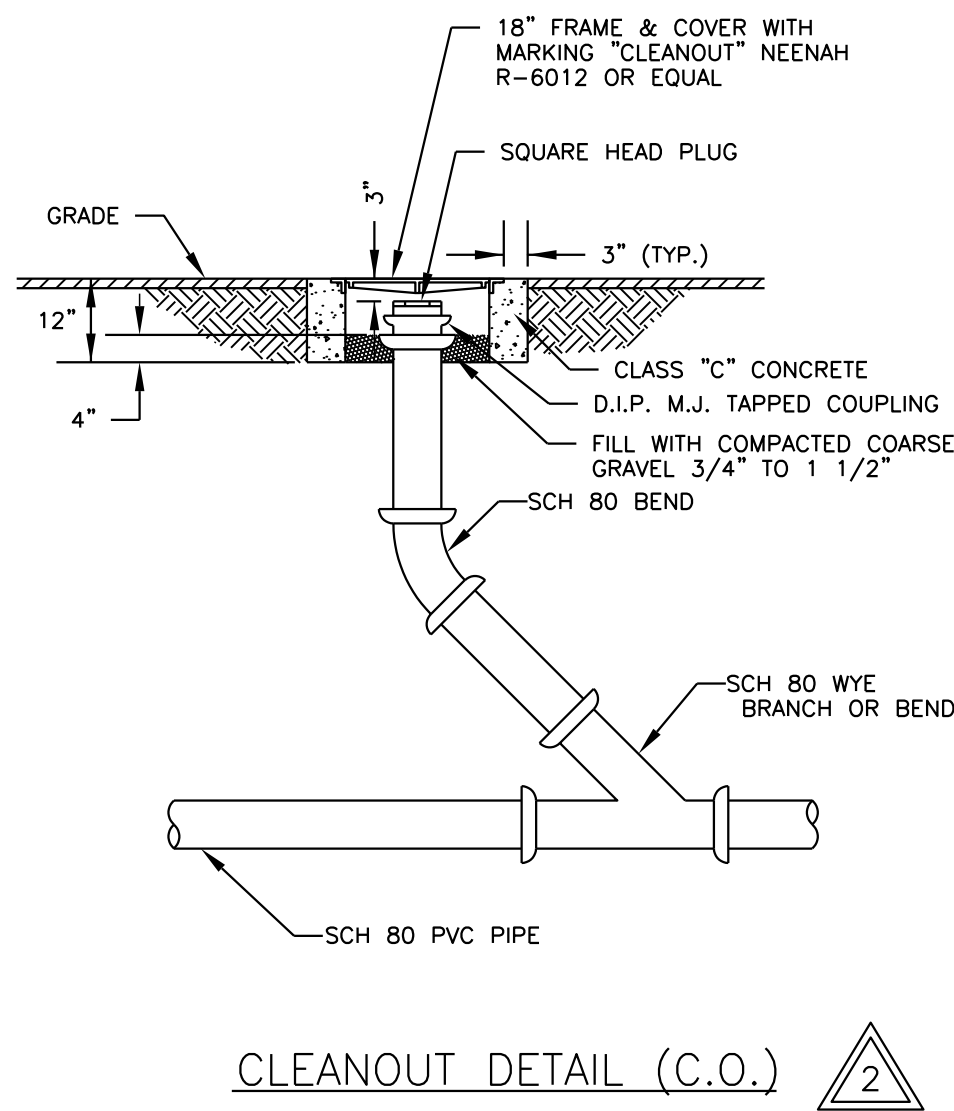
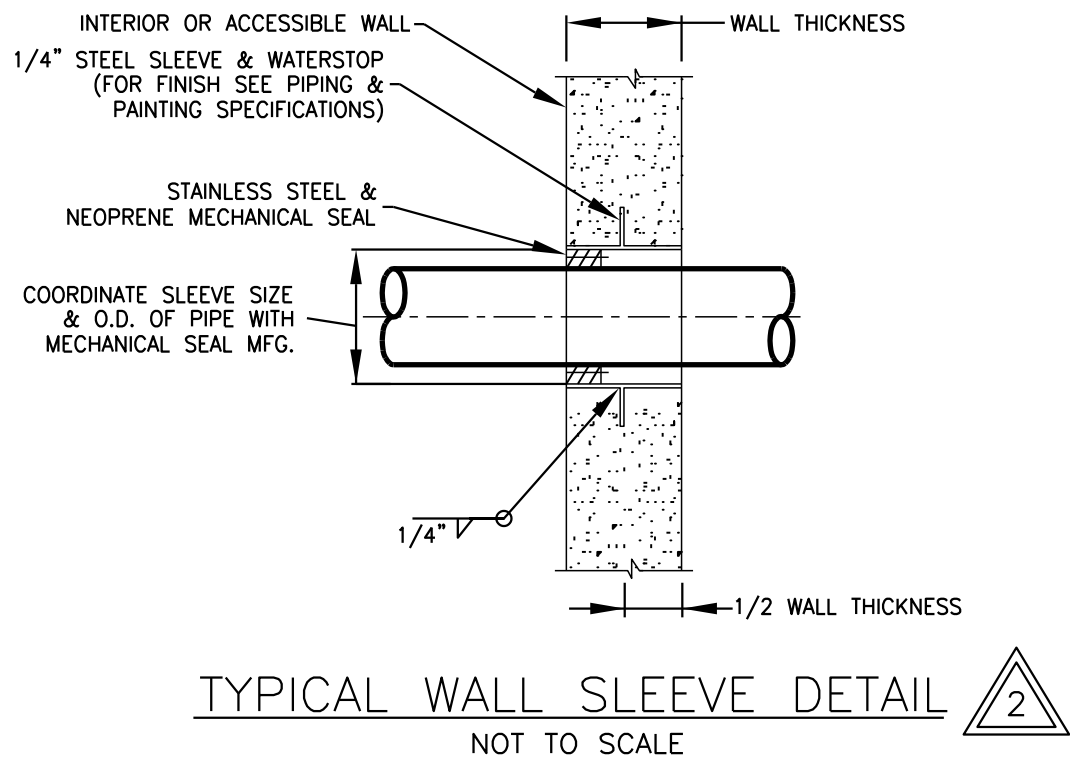
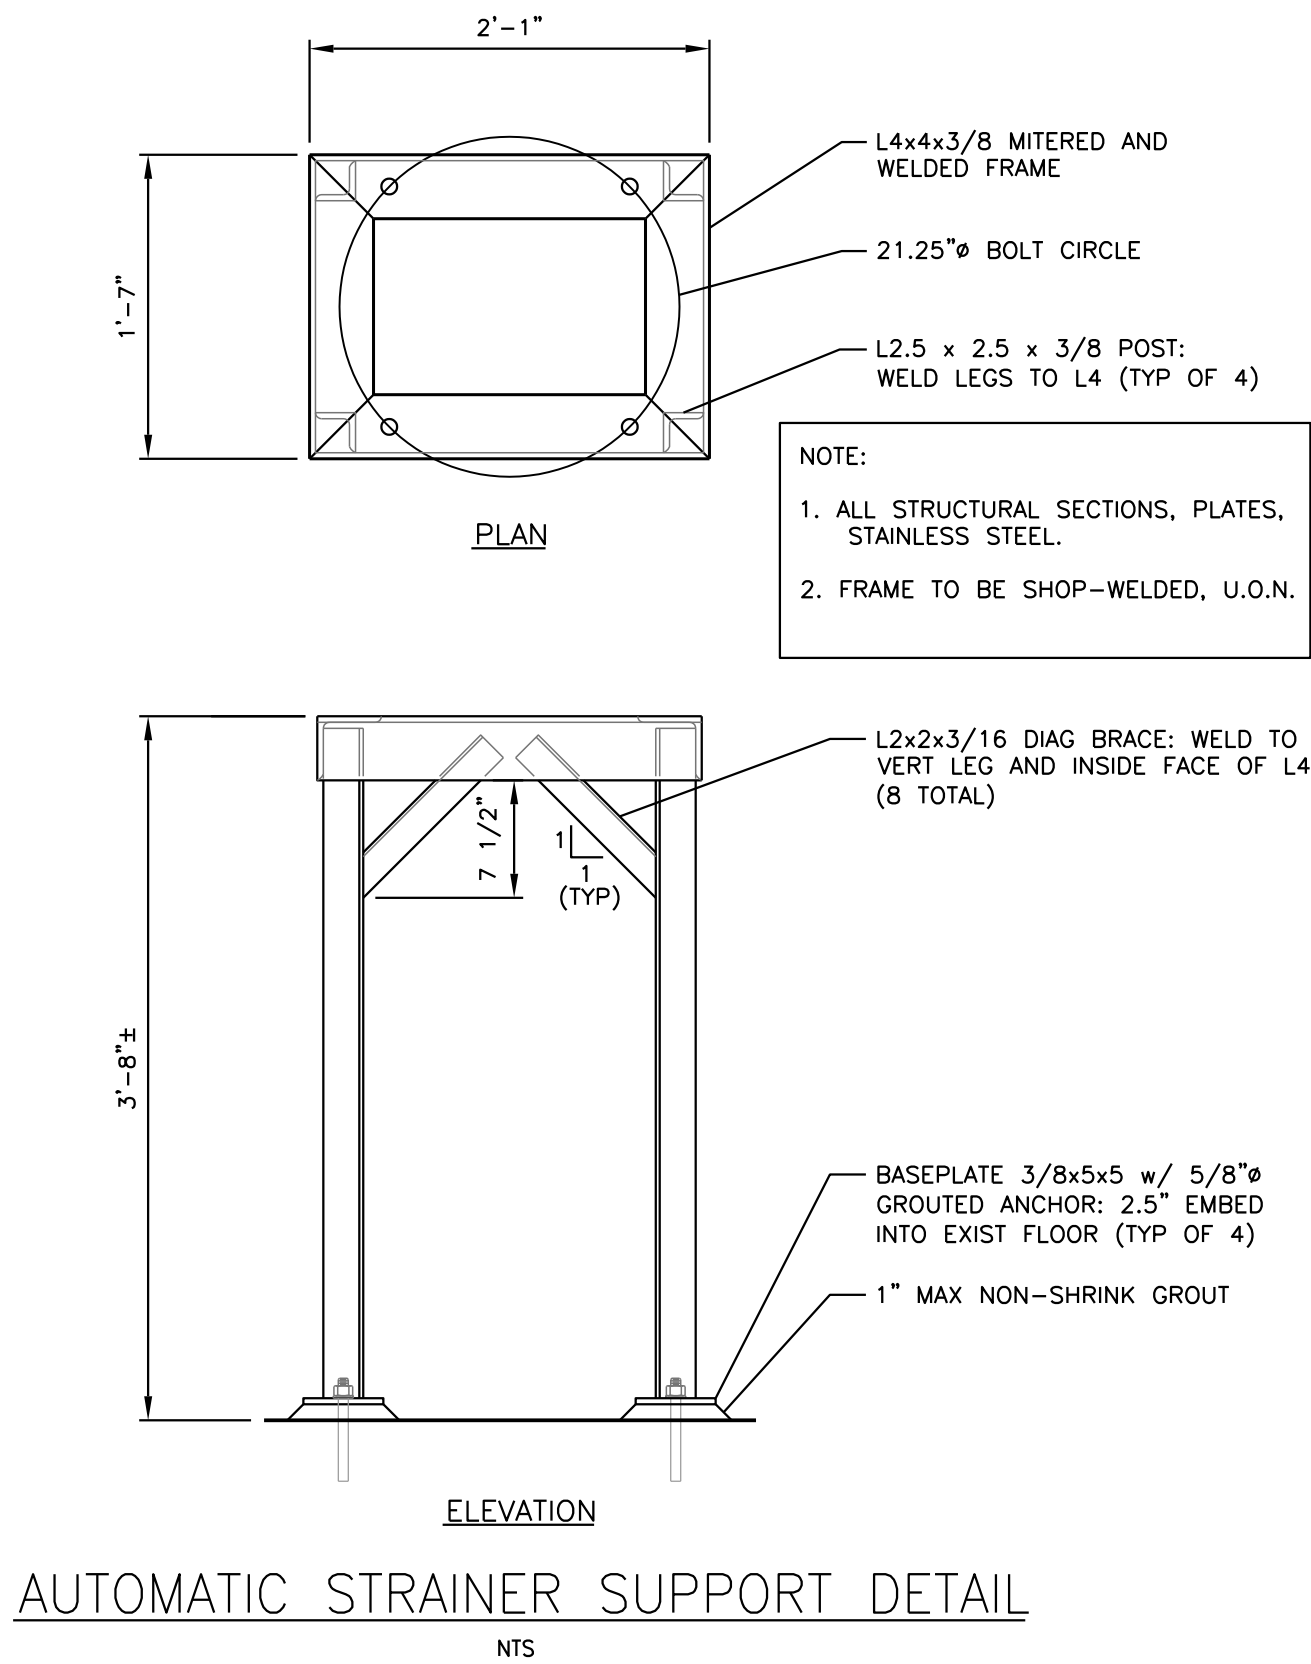
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2	REVISED PER OWNER & VDH COMMENTS				RRC	6/21/04							
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1	FOR APPROVAL				RRC	1/23/04							
	BSR	11/03	WPJ	CMT									
ISSUE NO.	DRAWN	DATE	CHECKED	DESIGNER	APPROVED	DATE							
PROJECT SUPERVISOR					DEPARTMENT SUPERVISOR								
ISSUE NO.	DRAWN	DATE	CHECKED	DESIGNER	APPROVED	DATE							





BEDFORD COUNTY PUBLIC SERVICE AUTHORITY			
HIGH POINT WTP EXPANSION - PROJECT NO. 2003 - 028			
EFM TANK SECTIONS & DETAILS			
JOB NO.	20280	DRAWING	M-6
		SHEET	24 OF 37

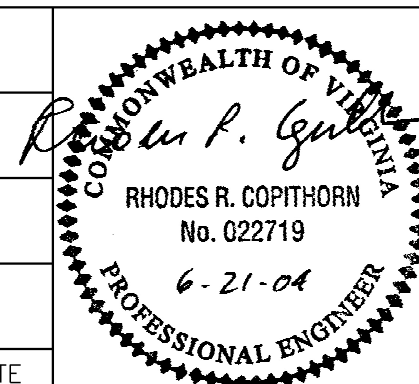




X-REF: 20280-1
8/03, BSR
P-20280-30 (Piping Mech)

NOTES:
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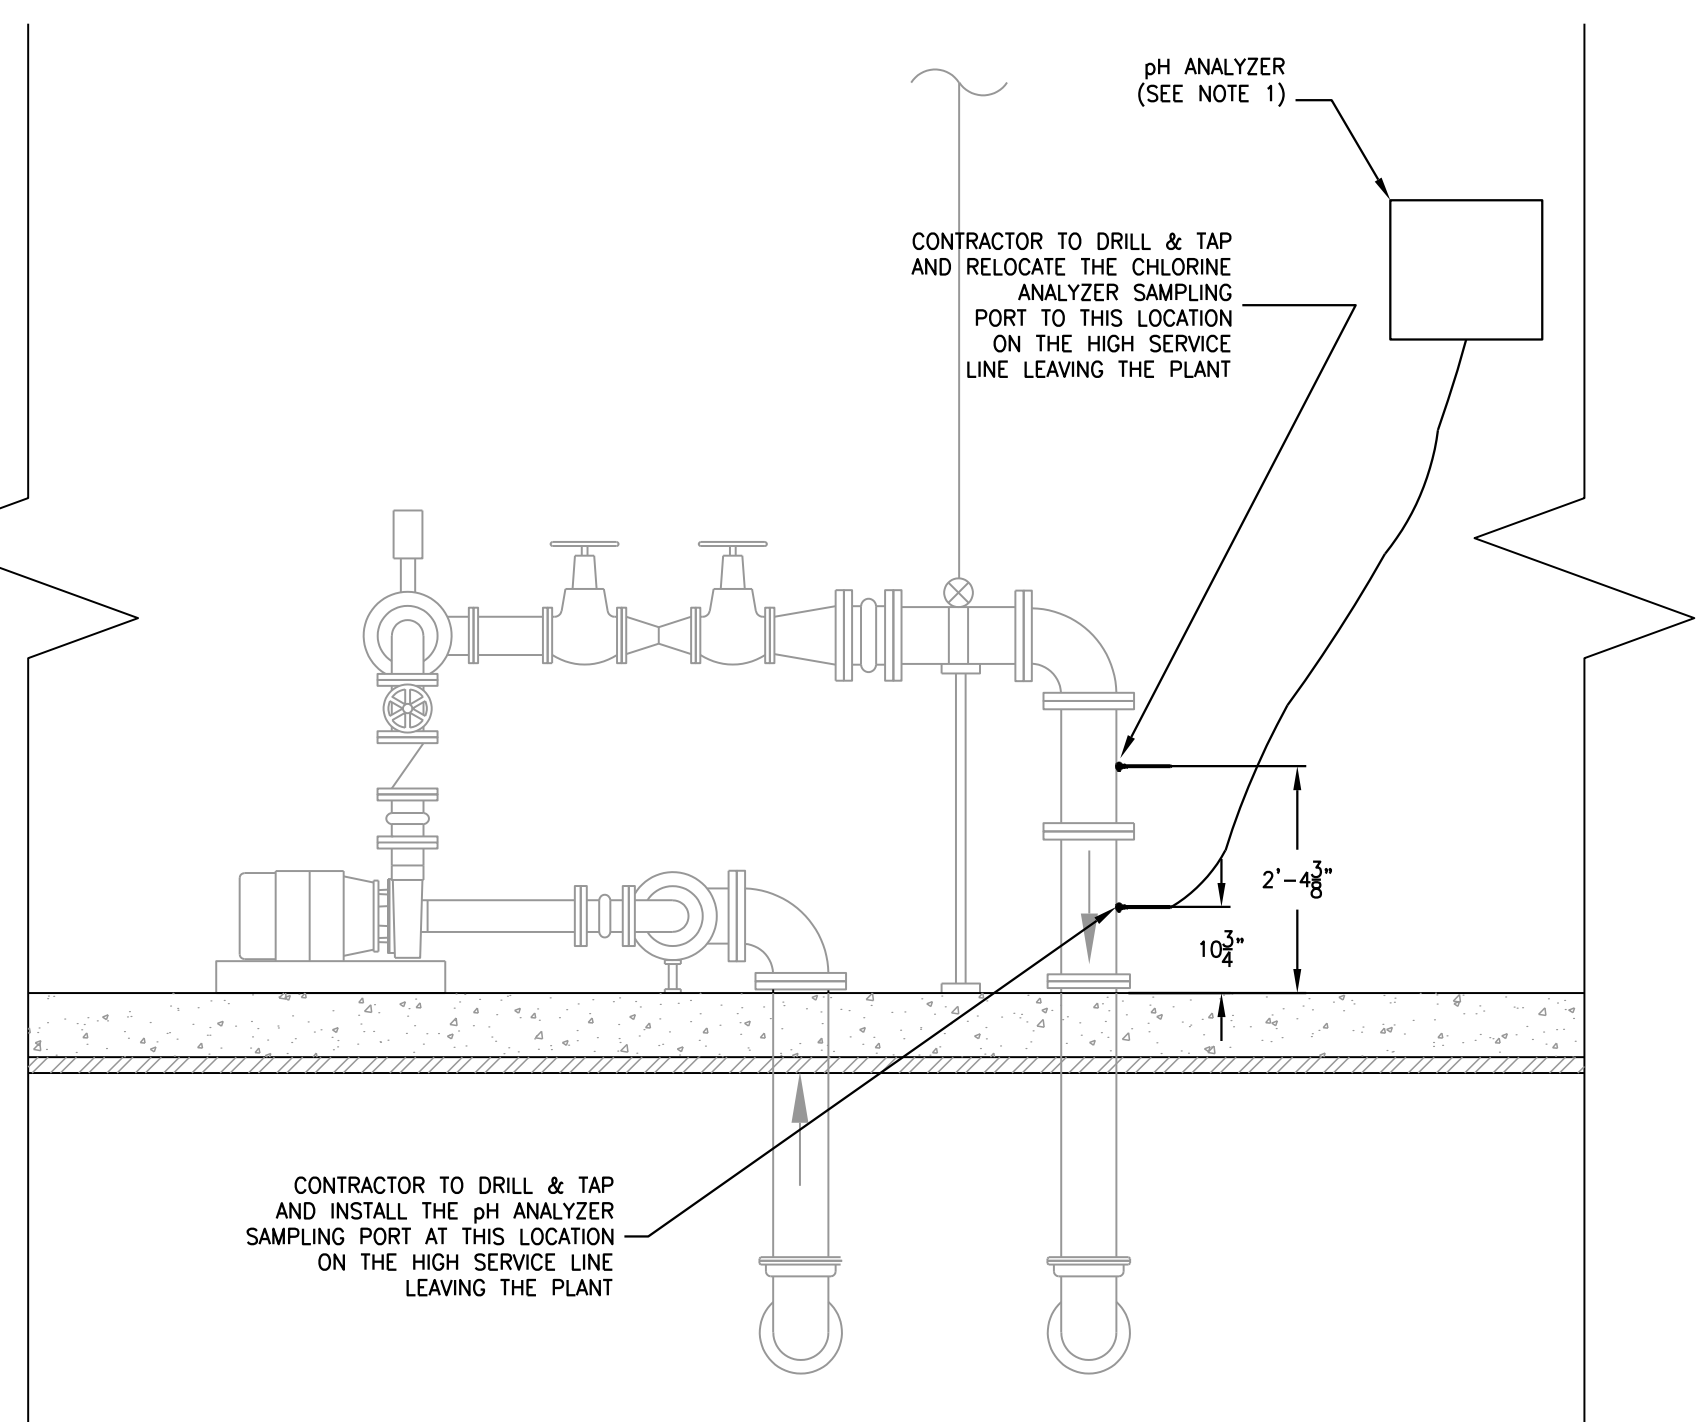
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	BSR	11/03		WPJ					BSR					
ISSUE NO.	DRAWN	DATE	CHECKED	DESIGNER	APPROVED	DATE								
PROJECT SUPERVISOR					DEPARTMENT SUPERVISOR									
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Stearns & Wheler, LLC
Environmental Engineers and Scientists

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ROANOKE, VIRGINIA 24011
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BEDFORD COUNTY PUBLIC SERVICE AUTHORITY			
HIGH POINT WTP EXPANSION – PROJECT NO. 2003 – 028			
MISCELLANEOUS MECHANICAL DETAILS			
JOB NO.	20280	DRAWING	M-8
SHEET	26	OF	37

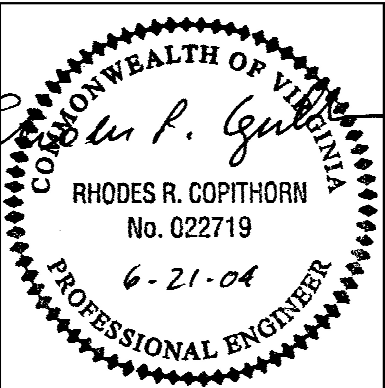


JOB NO.	20280	DRAWING	M-9	SHEET	27 OF 37
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LOUVER AND DAMPER SCHEDULE										DESIGN BASIS	
UNIT I.D.	ROOM NAME	EQUIPMENT TYPE	DIMENSIONS (W" X H" X D")	BLADE ANGLE	OPERATOR TYPE	VOLTS/ PHASE	INTERLOCK WITH	NOTES		MANUFACTURER	MODEL
LV-1	PROCESS ROOM 100	COMBINATION FIXED/OPERABLE	40" x 40" x 4"	45°	POWER OPEN/SPRING RETURN	120/1	F-1	2, 4		GREENHECK	ECD-401
LV-2	PROCESS ROOM 100	COMBINATION FIXED/OPERABLE	40" x 40" x 4"	45°	POWER OPEN/SPRING RETURN	120/1	F-2	2, 4		GREENHECK	ECD-401
LV-3	UTILITY/STORAGE ROOM 101	COMBINATION FIXED/OPERABLE	40" x 40" x 4"	45°	POWER OPEN/SPRING RETURN	120/1	F-3	2, 4		GREENHECK	ECD-401
LV-4	UTILITY/STORAGE ROOM 101	COMBINATION FIXED/OPERABLE	16" x 16" x 4"	45°	POWER OPEN/SPRING RETURN	120/1	F-4	2, 4		GREENHECK	ECD-401
LV-5	COMPRESSOR ROOM 102	COMBINATION FIXED/OPERABLE	32" x 32" x 4"	45°	POWER OPEN/SPRING RETURN	120/1	F-5	2, 4		GREENHECK	ECD-401
LV-6	ELECTRIC ROOM	COMBINATION FIXED/OPERABLE	24" x 16" x 4"	45°	POWER OPEN/SPRING RETURN	120/1	F-6	2, 4		GREENHECK	ECD-401


FAN AND EXHAUSTER SCHEDULE													DESIGN BASIS	
UNIT I.D.	ROOM NAME	TYPE OF EQUIPMENT	DRIVE	CFM	FAN EXT. S.P. IN. W.G.	RPM	SONES	HP	VOLTS/ PHASE	CONTROLS CONTROLLED BY	NOTES		MANUFACTURER	MODEL
F-1: F-3	PROCESS ROOM 100	WALL MOUNTED CENTR. EXHAUST	DIRECT	2500	.375	1140	14.3	0.5	120/1	ON/OFF SWITCH	2, 6		GREENHECK	CWB
F-4	UTILITY/STORAGE ROOM 101	WALL MOUNTED CENTR. EXHAUST	DIRECT	220	.375	1300	5.5	.04	120/1	ON/OFF SWITCH	2, 6		GREENHECK	CW-083
F-5	COMPRESSOR ROOM 102	WALL MOUNTED CENTR. EXHAUST	DIRECT	1000	.375	1140	8.2	0.17	120/1	HOA SWITCH/T-STAT	2, 6		GREENHECK	CW-121
F-6	ELECTRIC ROOM	WALL MOUNTED CENTR. EXHAUST	DIRECT	500	.375	1140	7.4	0.07	120/1	HOA SWITCH/T-STAT	2, 6		GREENHECK	CW-090

UNIT HEATER SCHEDULE												DESIGN BASIS	
UNIT I.D.	ROOM	EQUIPMENT TYPE	INPUT (MBH)	OUTPUT (MBH)	AIR FLOW AT 70°F.	MOTOR/ ELEC. DATA			NOTES	MANUFACTURER	MODEL		
GUH-1:GUH-2	PROCESS ROOM 100	PROPANE GAS, CEILING MOUNTED	75	60	1100	.083	120/1	1625	1, 3, 5, 7	MODINE	PD 75		
GUH-3 :GUH-4	PROCESS ROOM 100	PROPANE GAS, CEILING MOUNTED	50	40	740	.025	120/1	1550	1, 3, 5, 7	MODINE	PD 50		
GUH-5	COMPRESSOR ROOM 102	PROPANE GAS, CEILING MOUNTED	30	24	440	.025	120/1	1550	1, 3, 7	MODINE	PD 30		
GUH-6	UTILITY/STORAGE ROOM 101	PROPANE GAS, CEILING MOUNTED	30	24	440	.025	120/1	1550	1, 3, 7	MODINE	PD 30		
EUH-1	ELECTRIC ROOM	ELECTRIC, WALL MOUNTED	—	5KW	530	.025	120/1	1550	1, 3, 7	MODINE	HER 50		

MISCELLANEOUS HVAC EQUIPMENT LIST			
EQUIPMENT DESCRIPTION	MANUFACTURER	MODEL	
SINGLE-STAGE, PILOT DUTY THERMOSTAT	WHITE ROGERS	WR80	
CORROSION RESISTANT THERMOSTAT	CHROMALOX	WCRT	
DAMPER/LOUVER MOTOR ACTUATOR	INVENSYS	MA SERIES	
GAS UNIT HEATER VENTS	HEAT FAB	SAF-T VENT SC	

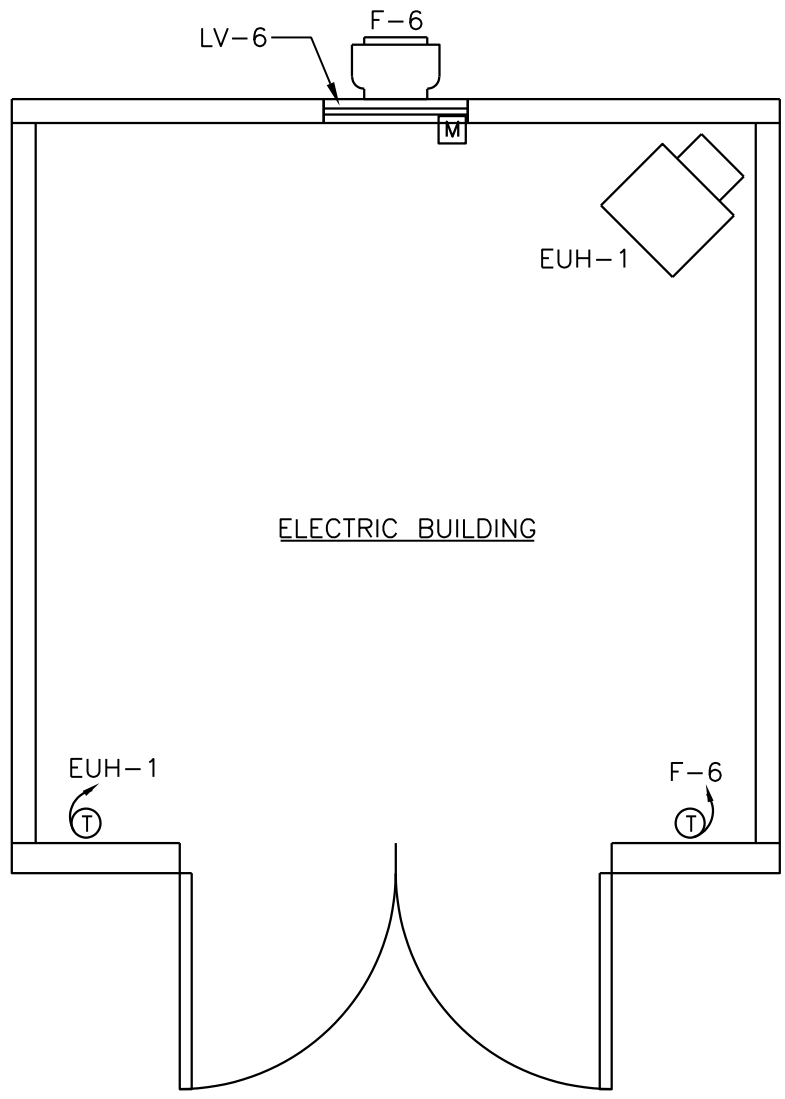

RAW WATER PUMP STATION ELECTRICAL
BUILDING HVAC FLOOR PLAN
SCALE: 3/8"=1'-0"

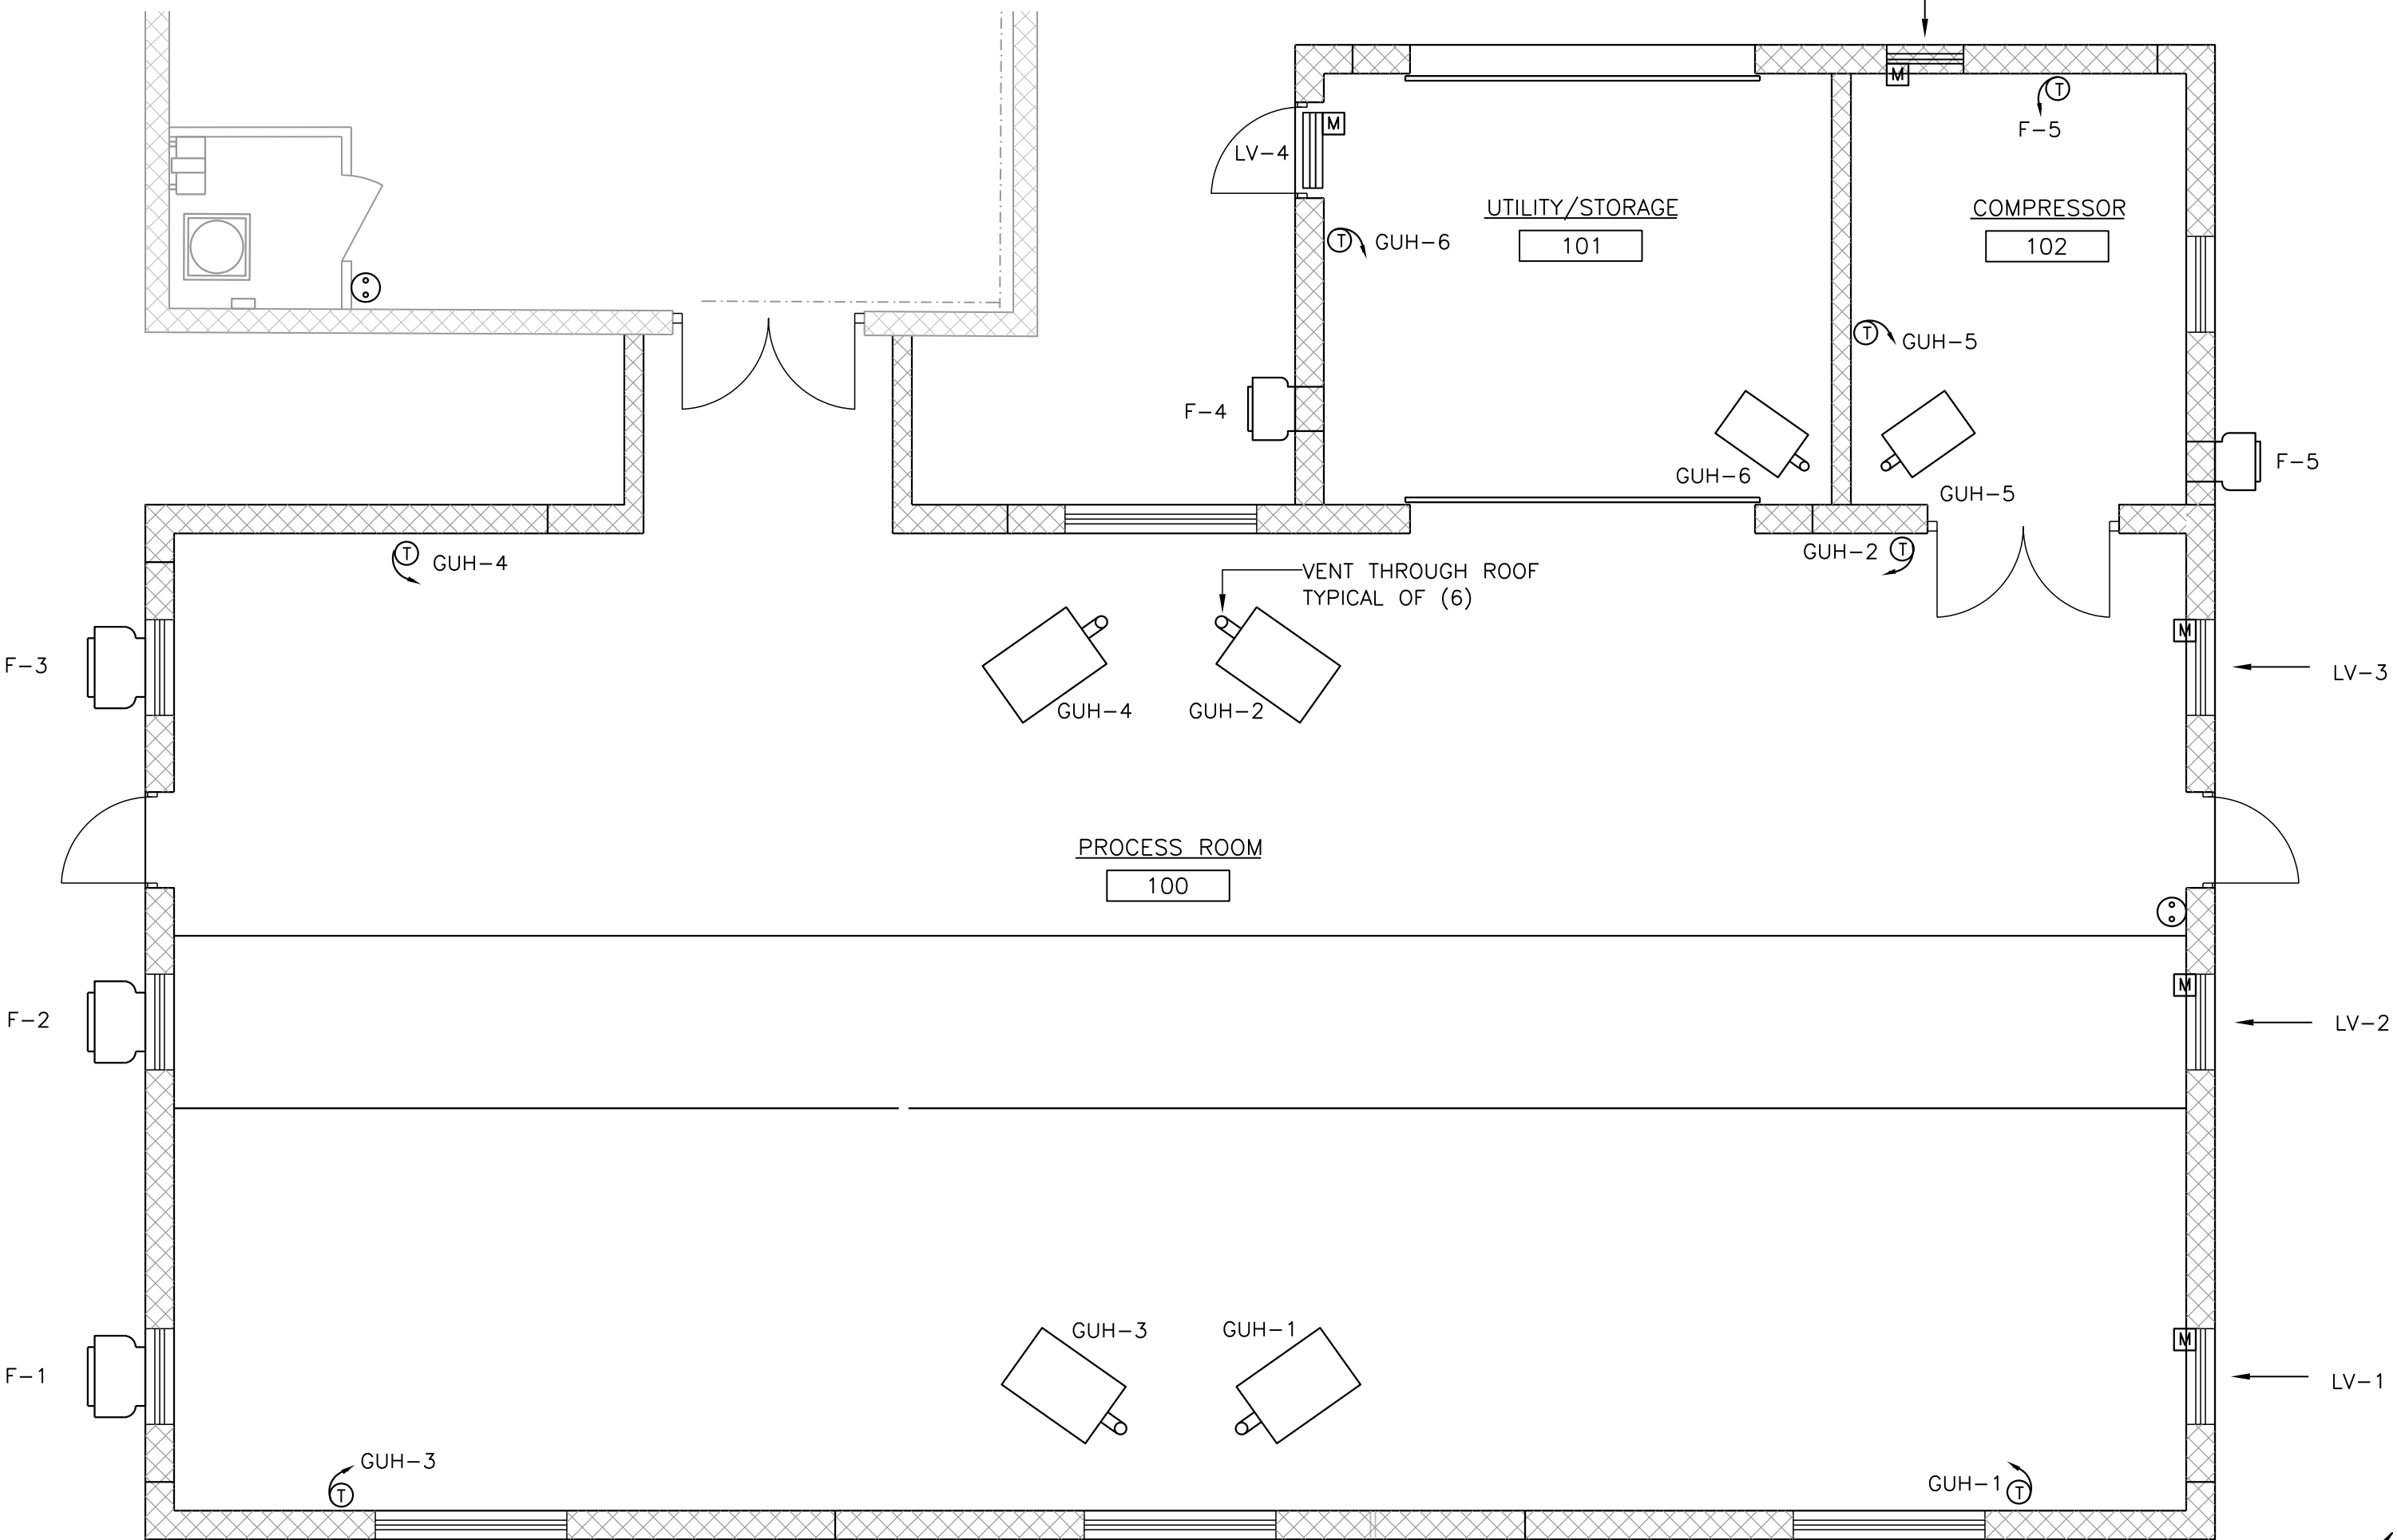

HVAC FLOOR PLAN
SCALE: 3/16"=1'-0"

SCHEDULE NOTES

- UNIT TO BE PROVIDED WITH COMPLETE CONTROLS.
- UNITS TO BE PROVIDED WITH RAW ALUMINUM FINISH.
- CONDUIT AND WIRING BETWEEN UNIT HEATERS AND CONTROLLING THERMOSTATS TO BE PROVIDED AND INSTALLED BY THE HVAC TRADE IN ACCORDANCE WITH THE DIVISION 16000 ELECTRICAL SPECIFICATIONS.
- PROVIDE EXTERNAL 1/2", 0.08 ALUMINUM WIRE MESH BIRDSCREEN WITH REMOVABLE ALUMINUM FRAME. FRAME AND SCREEN TO MATCH LOUVER FINISH.
- TO BE CONTROLLED BY CORROSION RESISTANT THERMOSTATS.
- UNIT TO BE PROVIDED WITH SELF-ACTING BACKDRAFT DAMPER.
- MOUNT UNITS AS HIGH AS POSSIBLE AND IN ACCORDANCE WITH MANUFACTURERS RECOMMENDATIONS.

GENERAL NOTES

- SCHEDULE LINE ITEMS MAY REFER TO MULTIPLE UNITS. EXAMPLE, F-1 F-3 REFERS TO FANS F-1 THROUGH F-3 (I.E. THREE UNITS).
- CONTRACTOR TO BALANCE ALL AIR HANDLING SYSTEMS AND SUBMIT AIR BALANCE REPORT IN ACCORDANCE WITH ASHRAE.
- REFER TO ARCHITECTURAL ELEVATION FOR LOUVER ELEVATIONS.
- INSTALL AND TERMINATE UNIT HEATER VENTS ABOVE ROOF IN ACCORDANCE WITH LOCAL AND STATE CODE REQUIREMENTS.

ABBREVIATIONS

BTU	BRITISH THERMAL UNIT
CFM	CUBIC FEET PER MINUTE
EXT.	EXTERNAL
EUH	ELECTRIC UNIT HEATER
F	FAN
F.F.	FINISHED FLOOR
FPM	FEET PER MINUTE
HP	HORSEPOWER
HOA	HAND-OFF-AUTO
LV	LOUVER
MBH	THOUSAND BTUS PER HOUR
MOD	MOTOR OPERATED DAMPER
MTR	MOTOR
S.P.	STATIC PRESSURE
T-STAT	THERMOSTAT
TYP.	TYPICAL
GUH	GAS UNIT HEATER (PROPANE)
W.P.D.	WATER PRESSURE DROP
W.G.	WATER GAUGE

SYMBOLS


	LV-	LOUVER WITH MOTOR OPERATER (PLAN)
	12x20	DUCT SIZE IN INCHES (FIRST NO., SIDE SHOWN; SECOND NO., SIDE NOT SHOWN)
	T	THERMOSTAT
	M	DAMPER MOTOR
	UH	UNIT HEATER
	100 CFM	SUPPLY AIR FLOW W/ RATE

X-REF: 20280-1 A-RWPS-PL, A-TB-P1, E-RWPS-P1, H-TB-P1, M-TB-P1, P-TB-P1
8/03, ROANOKE, BSR
P-120280-30 (Drawing HVAC)

NOTES:

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3	ISSUED FOR CONSTRUCTION															
2	RE-SEALED				RRC	6/21/04										
1	FOR APPROVAL				RRC	1/23/04										
	EGC	11/03	WPJ	DBP												
ISSUE NO.	DRAWN	DATE	CHECKED	DESIGNER	APPROVED	DATE										
PROJECT SUPERVISOR					DEPARTMENT SUPERVISOR					ISSUE NO.	DRAWN	DATE	CHECKED	DESIGNER	APPROVED	DATE

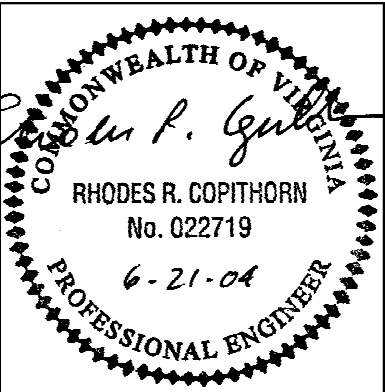

Stearns & Wheler, LLC
Environmental Engineers and Scientists


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BEDFORD COUNTY PUBLIC SERVICE AUTHORITY

HIGH POINT WTP EXPANSION – PROJECT NO. 2003 – 028

HVAC PLANS & DETAILS


JOB NO. 20280 DRAWING H-1 SHEET 28 OF 37

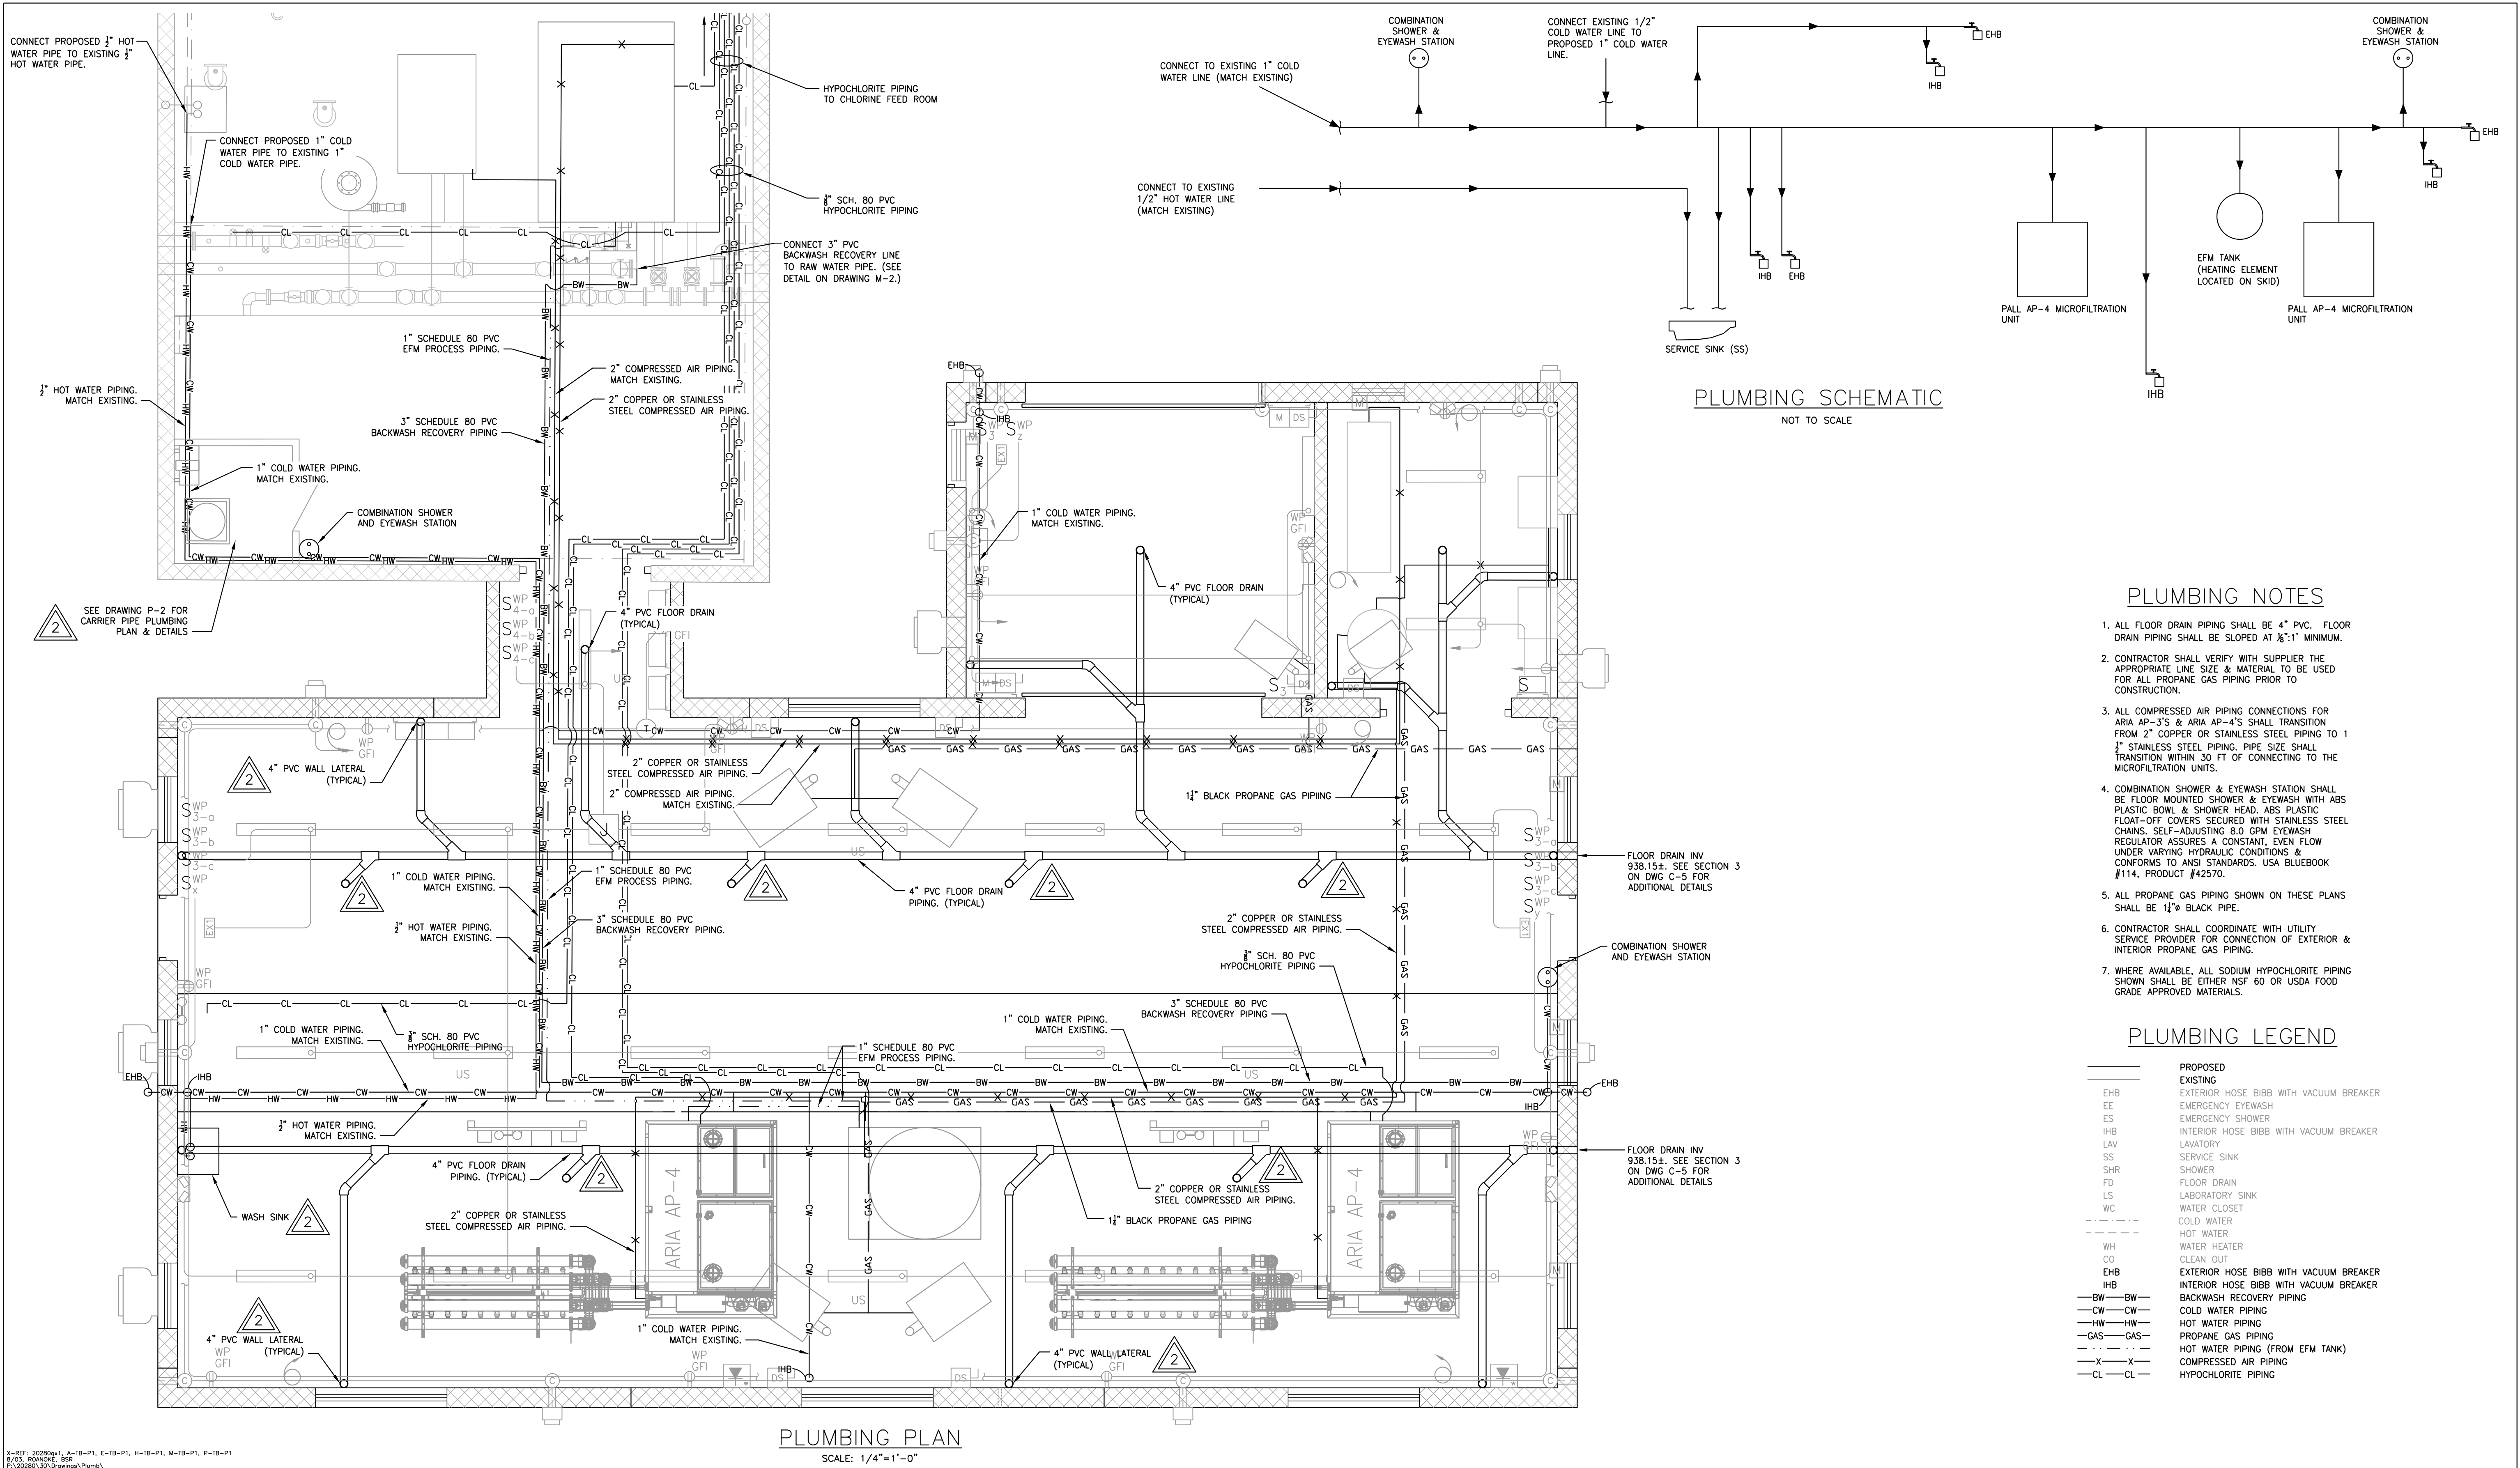

X-REF: 20280a1, A-TB-P1, E-TB-P1, H-TB-P1, M-TB-P1, P-TB-P1
6/03, ROANOKE, BSR
P-20280-30 (Drawing Plumb)

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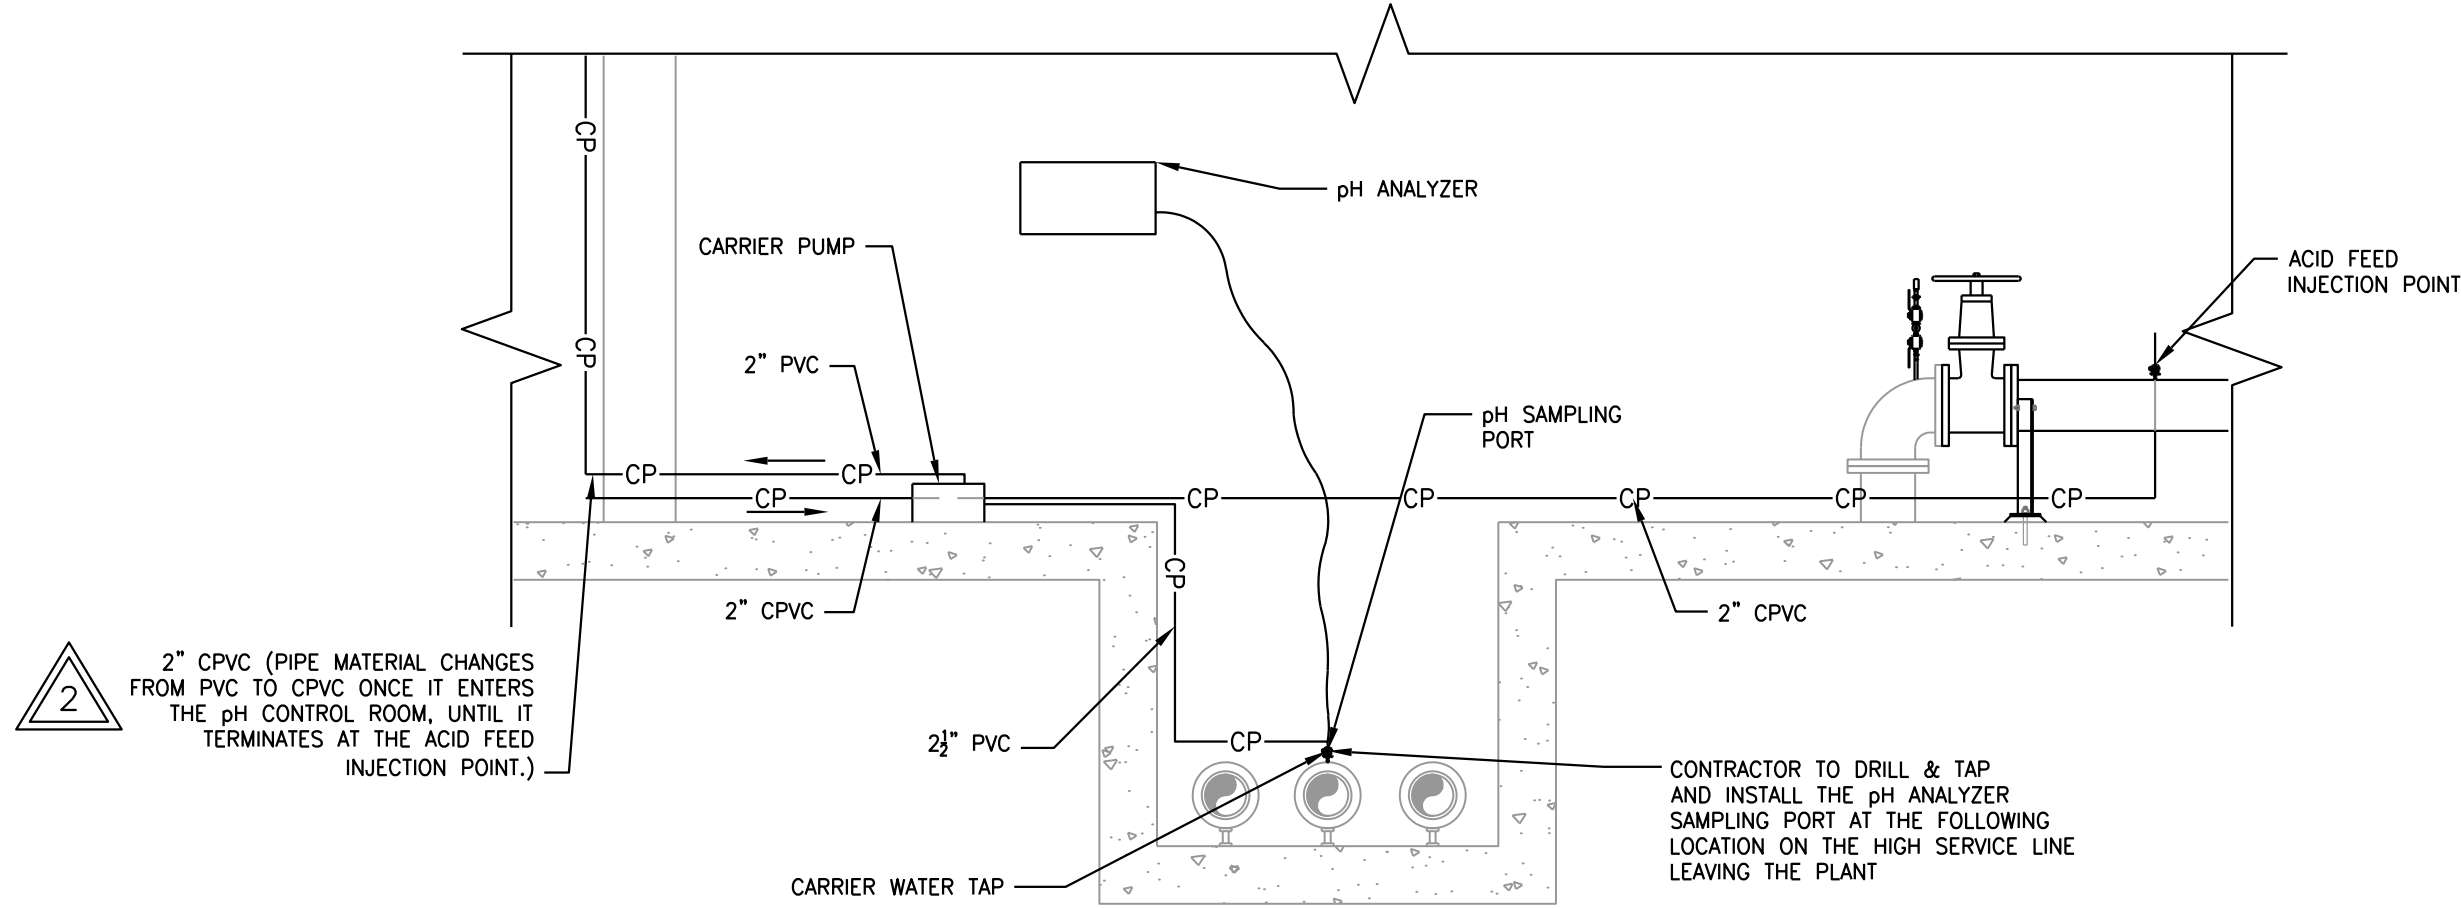
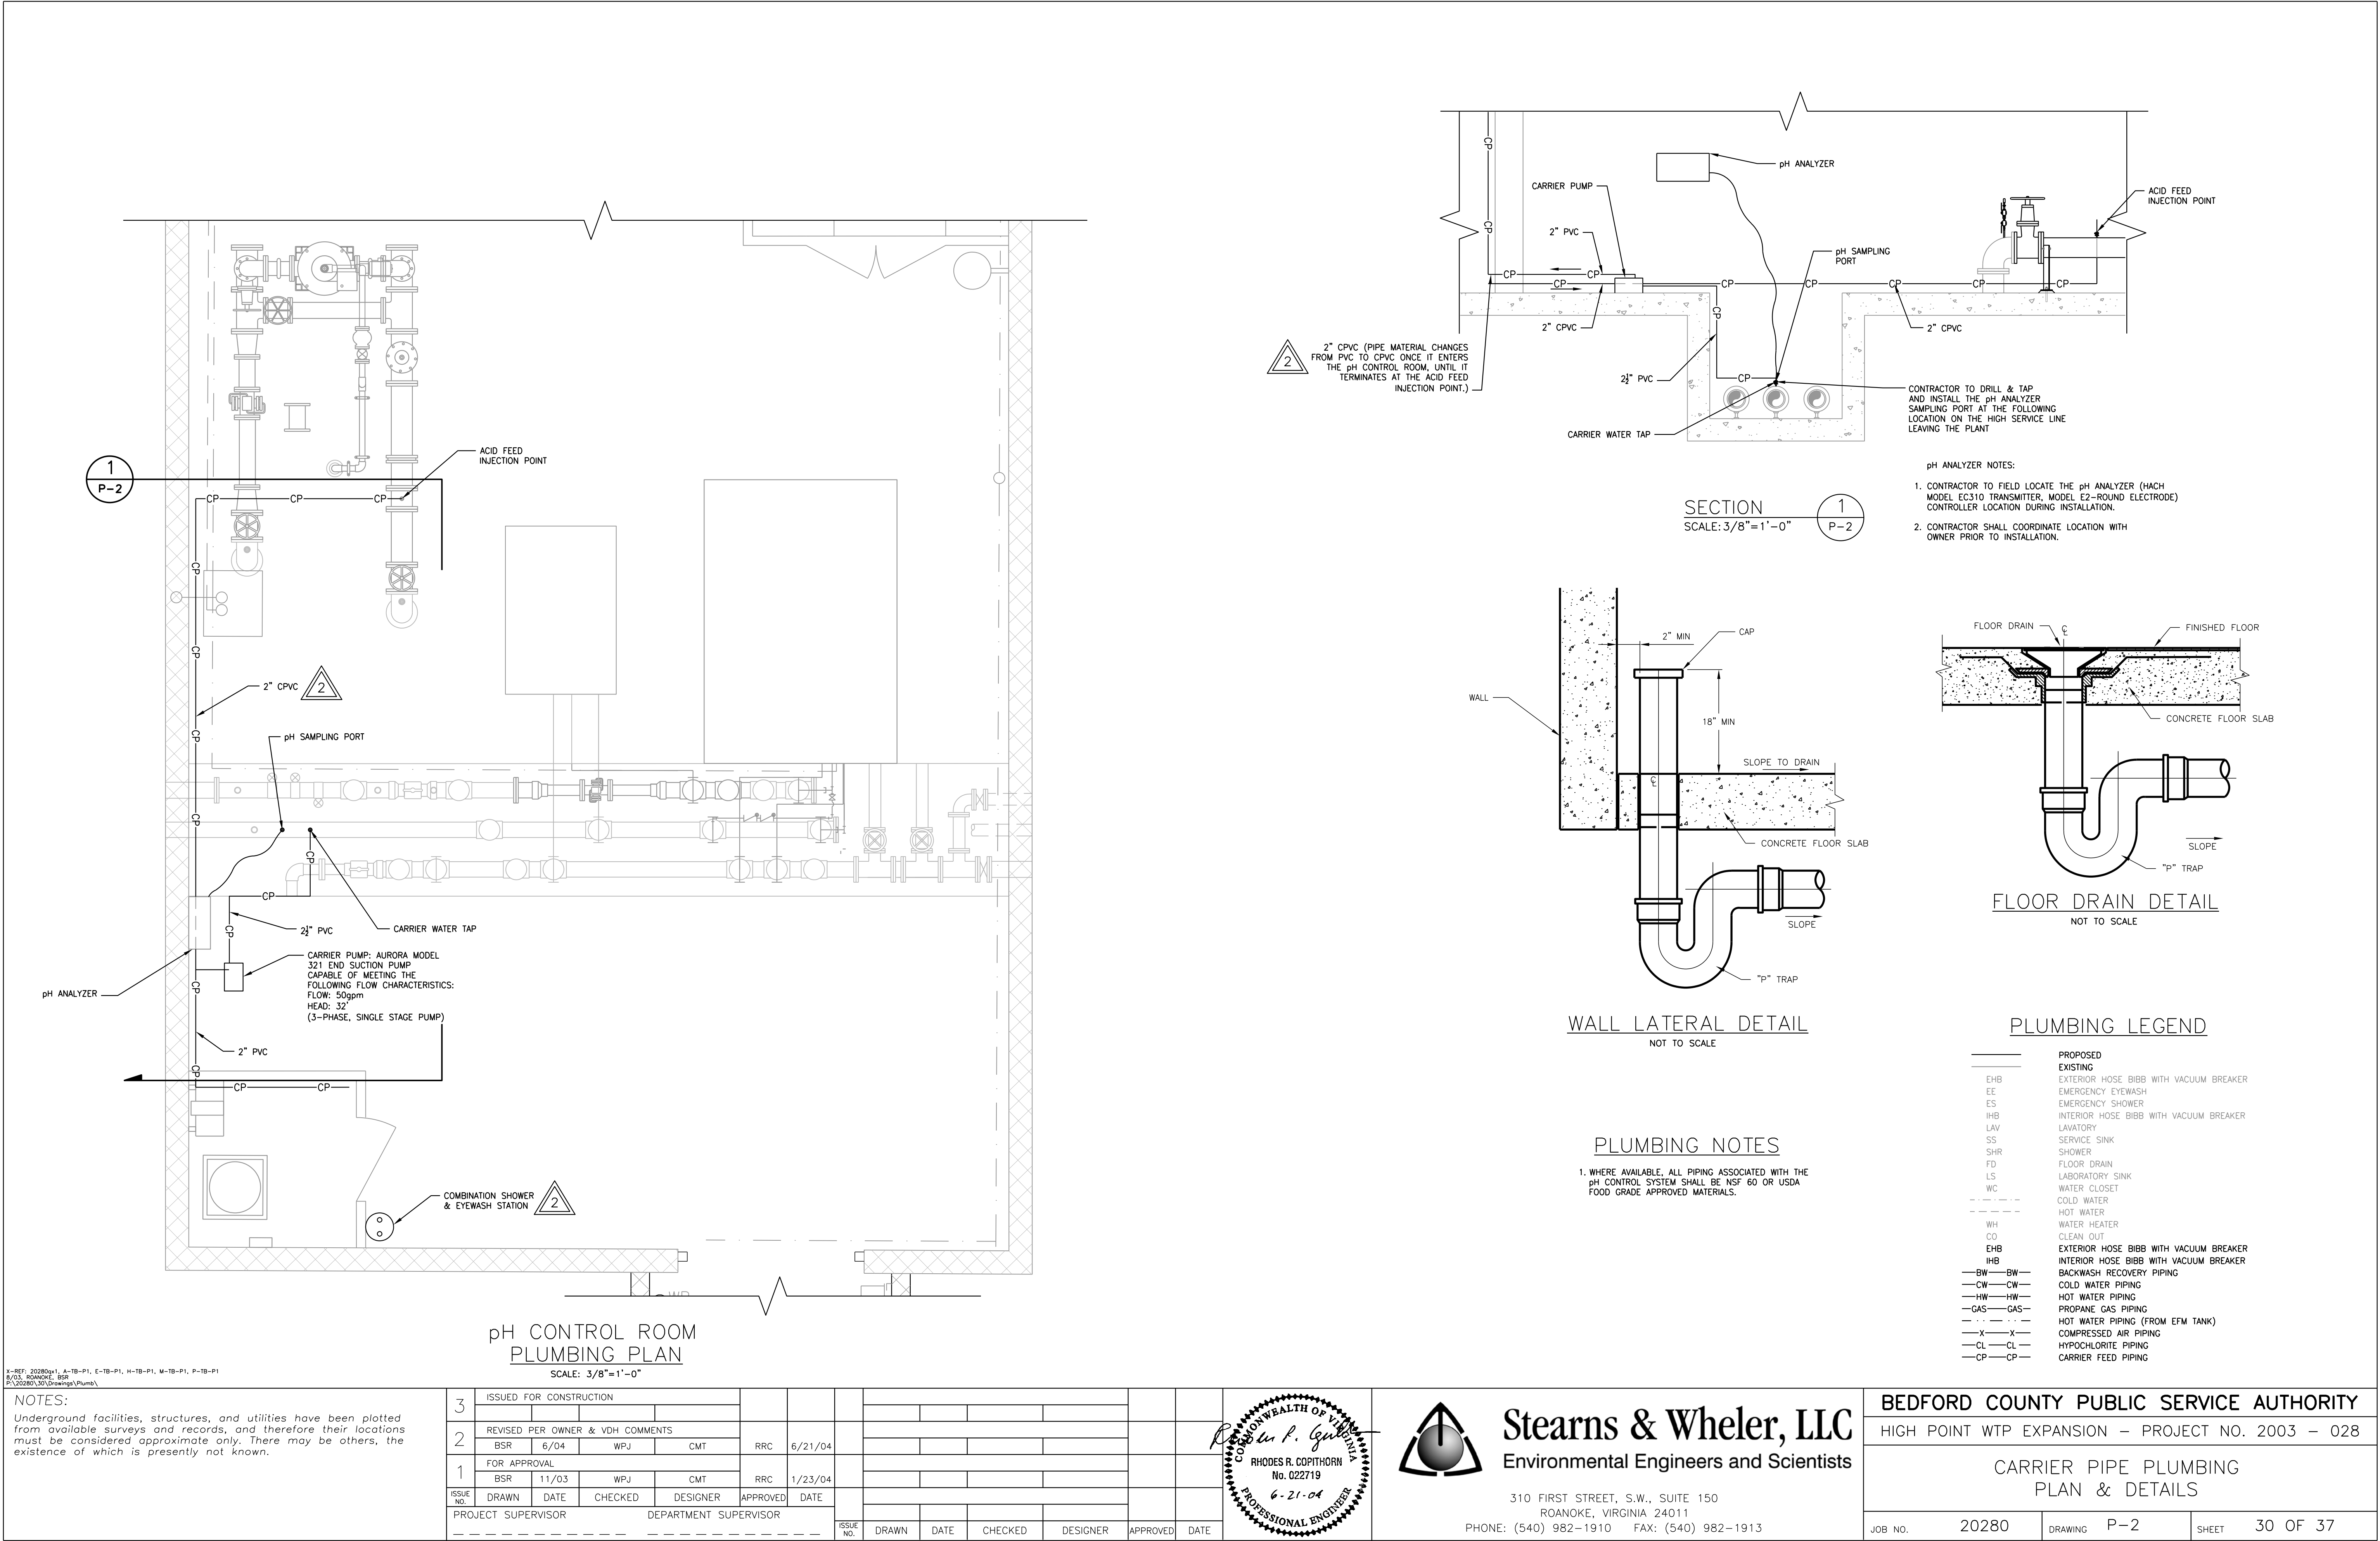
3	ISSUED FOR CONSTRUCTION														
2	REVISED PER OWNER & VDH COMMENTS					RRC	6/21/04								
	BSR	6/04		WPJ					CMT						
1	FOR APPROVAL					RRC	1/23/04								
	BSR	11/03		WPJ					CMT						
ISSUE NO.	DRAWN	DATE		CHECKED	DESIGNER	APPROVED	DATE								
PROJECT SUPERVISOR					DEPARTMENT SUPERVISOR										
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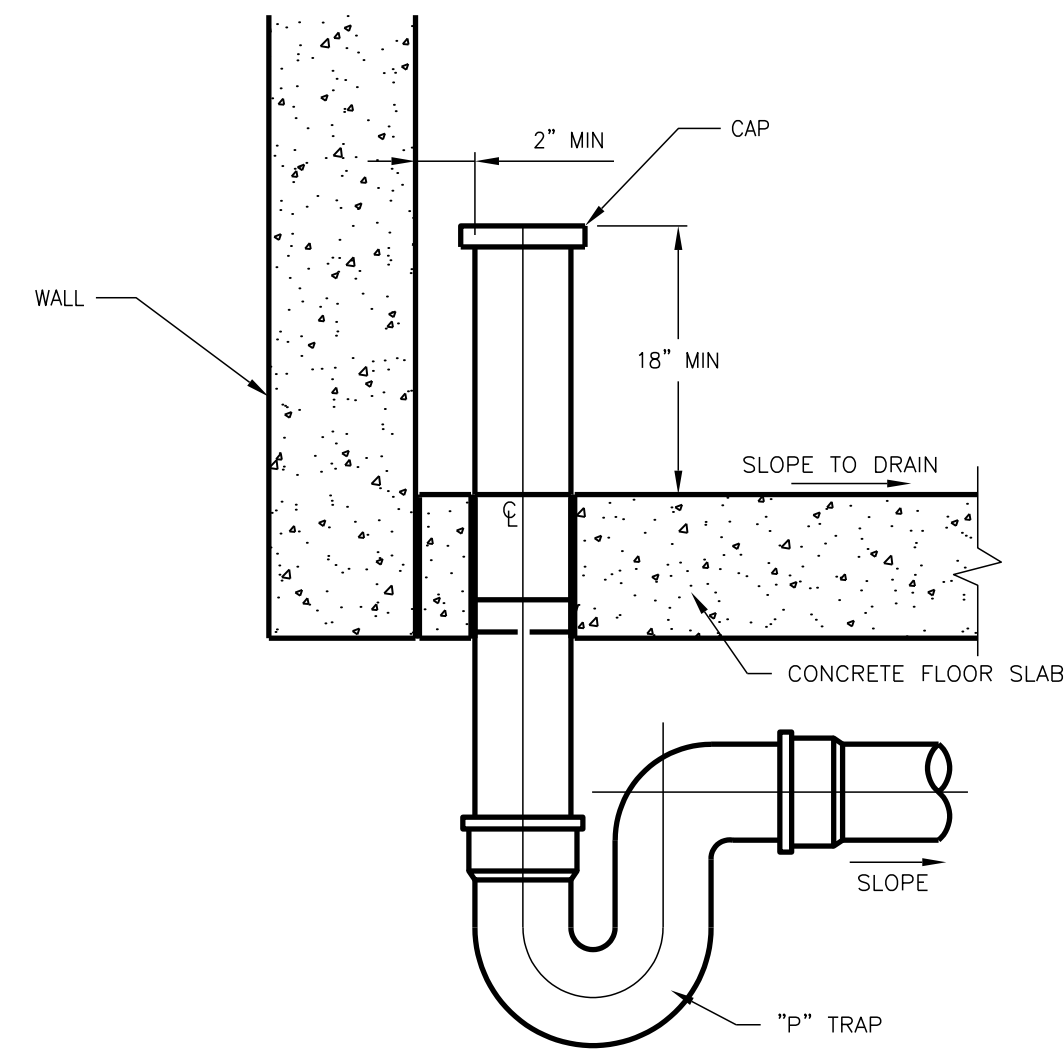
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BEDFORD COUNTY PUBLIC SERVICE AUTHORITY			
HIGH POINT WTP EXPANSION – PROJECT NO. 2003 – 028			
PLUMBING PLAN			
JOB NO.	20280	DRAWING	P-1
SHEET	29	OF	37

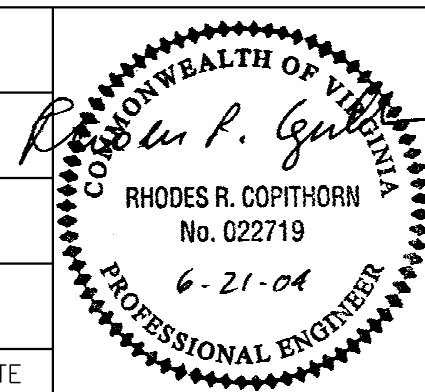


- pH ANALYZER NOTES:
1. CONTRACTOR TO FIELD LOCATE THE pH ANALYZER (HACH MODEL EC310 TRANSMITTER, MODEL E2-ROUND ELECTRODE) CONTROLLER LOCATION DURING INSTALLATION.
 2. CONTRACTOR SHALL COORDINATE LOCATION WITH OWNER PRIOR TO INSTALLATION.

SECTION 1
SCALE: 3/8"=1'-0"



WALL LATERAL DETAIL
NOT TO SCALE

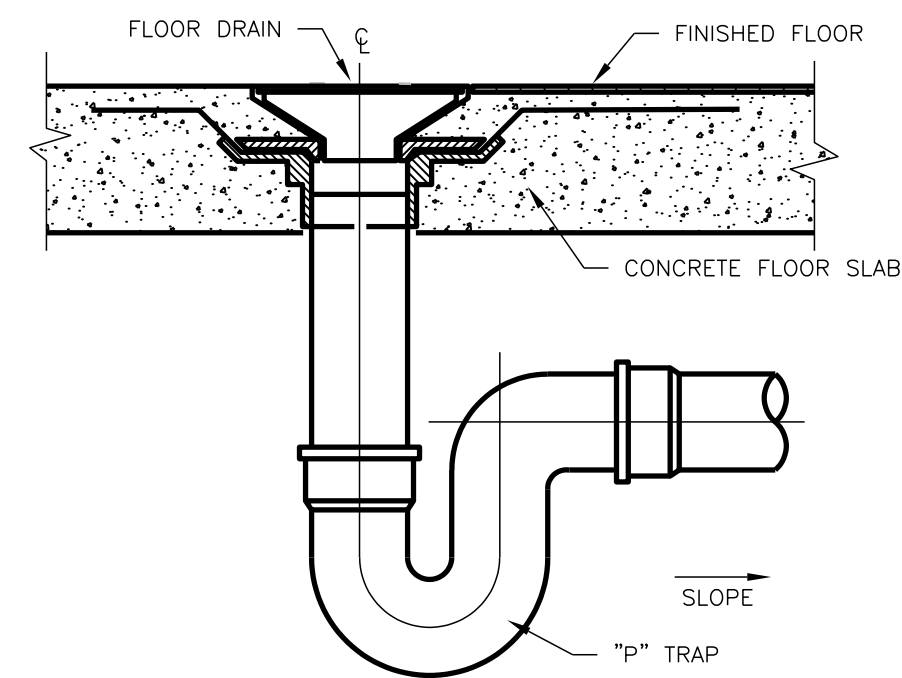

FLOOR DRAIN DETAIL
NOT TO SCALE

PLUMBING LEGEND

PROPOSED	EXISTING
EHB	EXTERIOR HOSE BIBB WITH VACUUM BREAKER
EE	EMERGENCY EYEWASH
ES	EMERGENCY SHOWER
IHB	INTERIOR HOSE BIBB WITH VACUUM BREAKER
LAV	LAVATORY
SS	SERVICE SINK
SHR	SHOWER
FD	FLOOR DRAIN
LS	LABORATORY SINK
WC	WATER CLOSET
---	COLD WATER
---	HOT WATER
WH	WATER HEATER
CO	CLEAN OUT
EHB	EXTERIOR HOSE BIBB WITH VACUUM BREAKER
IHB	INTERIOR HOSE BIBB WITH VACUUM BREAKER
BW	BACKWASH RECOVERY PIPING
CW	COLD WATER PIPING
HW	HOT WATER PIPING
GAS	PROPANE GAS PIPING
...	HOT WATER PIPING (FROM EFM TANK)
X	COMPRESSED AIR PIPING
CL	HYPOCHLORITE PIPING
CP	CARRIER FEED PIPING


PLUMBING NOTES

1. WHERE AVAILABLE, ALL PIPING ASSOCIATED WITH THE pH CONTROL SYSTEM SHALL BE NSF 60 OR USDA FOOD GRADE APPROVED MATERIALS.

X-REF: 20280a-1, A-TB-P1, E-TB-P1, H-TB-P1, M-TB-P1, P-TB-P1
6/03, ROANOKE, BSR
P:\20280\30\Drawings\Plumb\

NOTES:
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3	ISSUED FOR CONSTRUCTION																		
2	REVISED PER OWNER & VDH COMMENTS																		
	BSR	6/04	WPJ	CMT		RRC	6/21/04												
1	FOR APPROVAL																		
	BSR	11/03	WPJ	CMT		RRC	1/23/04												
ISSUE NO.	DRAWN	DATE	CHECKED	DESIGNER	APPROVED	DATE													
PROJECT SUPERVISOR					DEPARTMENT SUPERVISOR														
							ISSUE NO.	DRAWN	DATE	CHECKED	DESIGNER	APPROVED	DATE						

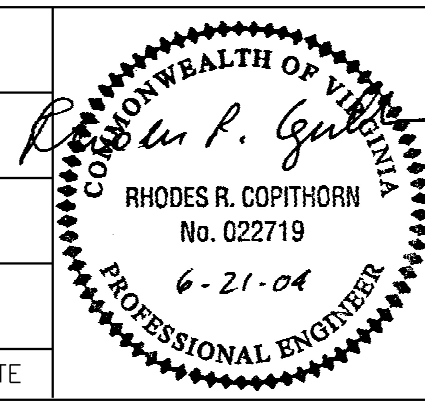

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BEDFORD COUNTY PUBLIC SERVICE AUTHORITY			
HIGH POINT WTP EXPANSION – PROJECT NO. 2003 – 028			
CARRIER PIPE PLUMBING PLAN & DETAILS			
JOB NO.	20280	DRAWING	P-2
		SHEET	30 OF 37


ELECTRICAL LEGEND

ABBREVIATIONS


A or AMP	AMPERE, AMPS	mA	WILLIAMS
AC	ALTERNATING CURRENT	MAG	MAGNETIC
AF	AMPERE FRAME SIZE	MAX	MAXIMUM
AFB	ABOVE FINISHED FLOOR	MCC-()	MOTOR CONTROL CENTER (W/# DESIGNATION)
AFG	ABOVE FINISHED GRADE	MCP	MOTOR CIRCUIT PROTECTOR
AI	ANALOG INPUT	MCS/	MOLDED CASE SWITCH
AIC	AMPS INTERRUPTING CURRENT	T -	THERMAL ONLY
AIT	ANALYSIS INDICATING TRANSMITTER	M -	MAGNETIC ONLY
ALT	ALTERNATOR	AUTO -	AUTOMATIC ONLY
AM	AMMETER	MDP	MAIN DISTRIBUTION PANEL
ANN	ANNUNCIATOR	MECH	MECHANICAL
AO	ANALOG OUTPUT	MFR	MANUFACTURER
AP	ANNUNCIATOR PANEL	MIN	MINIMUM
AS	AMMETER SWITCH	MMS	MANUAL MOTOR STARTER
ASV	AIR SOLENOID VALVE	MOSG-()	MOTOR OPERATED SLIDE GATE (W/# DESIGNATION)
AT	AMPERE TRIP RATING	MOV-()	MOTOR OPERATED VALVE (W/# DESIGNATION)
ATS	AUTOMATIC TRANSFER SWITCH	MS	MOTOR STARTER
AUX	AUXILIARY	MSS	MOTOR STARTING SWITCH
AWG	AMERICAN WIRE GAUGE	MTG	MOUNTING
		MTR	MOTOR TIMING RELAY
		MTS	MANUAL TRANSFER SWITCH
		MWTP	MOTOR WINDING THERMAL PROTECTION
		MWTS	MOTOR WINDING TEMPERATURE SENSOR
		Mx	MOTOR CONTACTOR AUXILIARY CONTACT
		N	NEUTRAL
		NC	NORMALLY CLOSED
		NCTO	NORMALLY CLOSED TIMED OPEN
		NEC	NATIONAL ELECTRICAL CODE
		NEMA	NATIONAL ELECTRICAL MANUFACTURERS ASSOC.
		NO	NORMALLY OPEN
		NP	NAMEPLATE
		QIT	OPERATOR INTERFACE TERMINAL
		OL	OVERLOAD RELAY
		Ø	PHASE
		P	POLE
		PB	PUSHBUTTON
		PBX	PULL BOX
		PCS	PROCESS CONTROL SYSTEM
		PF	PULLING FITTING or POWER FEED
		PLC	PROGRAMMABLE LOGIC CONTROLLER
		PNL	PANEL
		POT	POTENTIOMETER
		PP ()-()	POWER PANELBOARD (W/# DESIGNATION)
		PR	PAIR
		PRIM	PRIMARY
		PS	PRESSURE SWITCH or POWER SUPPLY
		PT	POTENTIAL TRANSFORMER
		PVC	POLY-VINYL CHLORIDE
		QTY	QUANTITY
		RCP-()	RADIANT CEILING PANEL (W/# DESIGNATION)
		RCT	REPEAT CYCLE TIMER
		RECP	RECEPTACLE
		RGS	RIGID GALVANIZED STEEL
		ROS	REMOTE OPERATING STATION
		RP	RELAY PANEL
		RV-AT	REDUCE VOLTAGE AUTO TRANSFORMER
		SA	SURGE ARRESTOR
		SCR	SILICON CONTROLLER RECTIFIER
		SEC	SECOND or SECONDARY
		SED	SERVICE ENTRANCE DISCONNECT
		SHLD	SHIELDED
		S/L	STOP/LOCKOUT SWITCH
		SN	SOLID NEUTRAL
		SEL or SEL SW	SELECTOR SWITCH
		SS	STAINLESS STEEL
		SSRV	SOLID STATE REDUCED VOLTAGE
		SSW	SAFETY SWITCH
		S/S	STOP/START PUSH BUTTON
		STP	SHIELDED TWISTED PAIR
		STR	STRANDED
		SV ()	SOLENOID VALVE (W/# DESIGNATION)
		SW	SWITCH
		SWD	SWITCHING DUTY
		SWSV	SEALWATER SOLENOID VALVE
		TC	TERMINAL CABINET OR TIMED CLOSED
		TDR	TIME DELAY RELAY
		TEL	TELEPHONE
		TERM	TERMINAL
		TP	TIMER
		TR	TERMINATION PANEL
		TRANS	TRANSFORMER
		TS	TORQUE SWITCH
		TSP	TWISTED SHIELED PAIR
		TST	TWISTED SHIELED TRIAD
		T-STAT	THERMOSTAT
		TTC	TELEPHONE TERMINATION CABINET
		TTT	TELEPHONE TERMINATION PANEL
		TVSS	TRANSIENT VOLTAGE SURGE SUPPRESSOR
		TYP	TYPICAL
		UH-()	UNIT HEATER (W/# DESIGNATION)
		ULS	ULTRASONIC LEVEL SENSOR
		UON	UNLESS OTHERWISE NOTED
		UPS	UNINTERRUPTIBLE POWER SUPPLY
		UTP	UNSHIELDED TWISTED PAIR
		V	VOLTS
		VA	VOLT-AMPERES
		VFD	VARIABLE FREQUENCY DRIVE
		VM	VOLTMETER
		VS	VOLTMETER SWITCH OR VACUUM SWITCH
		W/	WITH
		WP	WEATHER PROOF, WATER PROOF
		WS	WORKSTATION
		XP	EXPLOSION PROOF
		XFMR	TRANSFORMER
		2S1W	2 SPEED, 1 WINDING
		2S2W	2 SPEED, 2 WINDING

SYMBOLS

PLANS AND SCHEMATICS

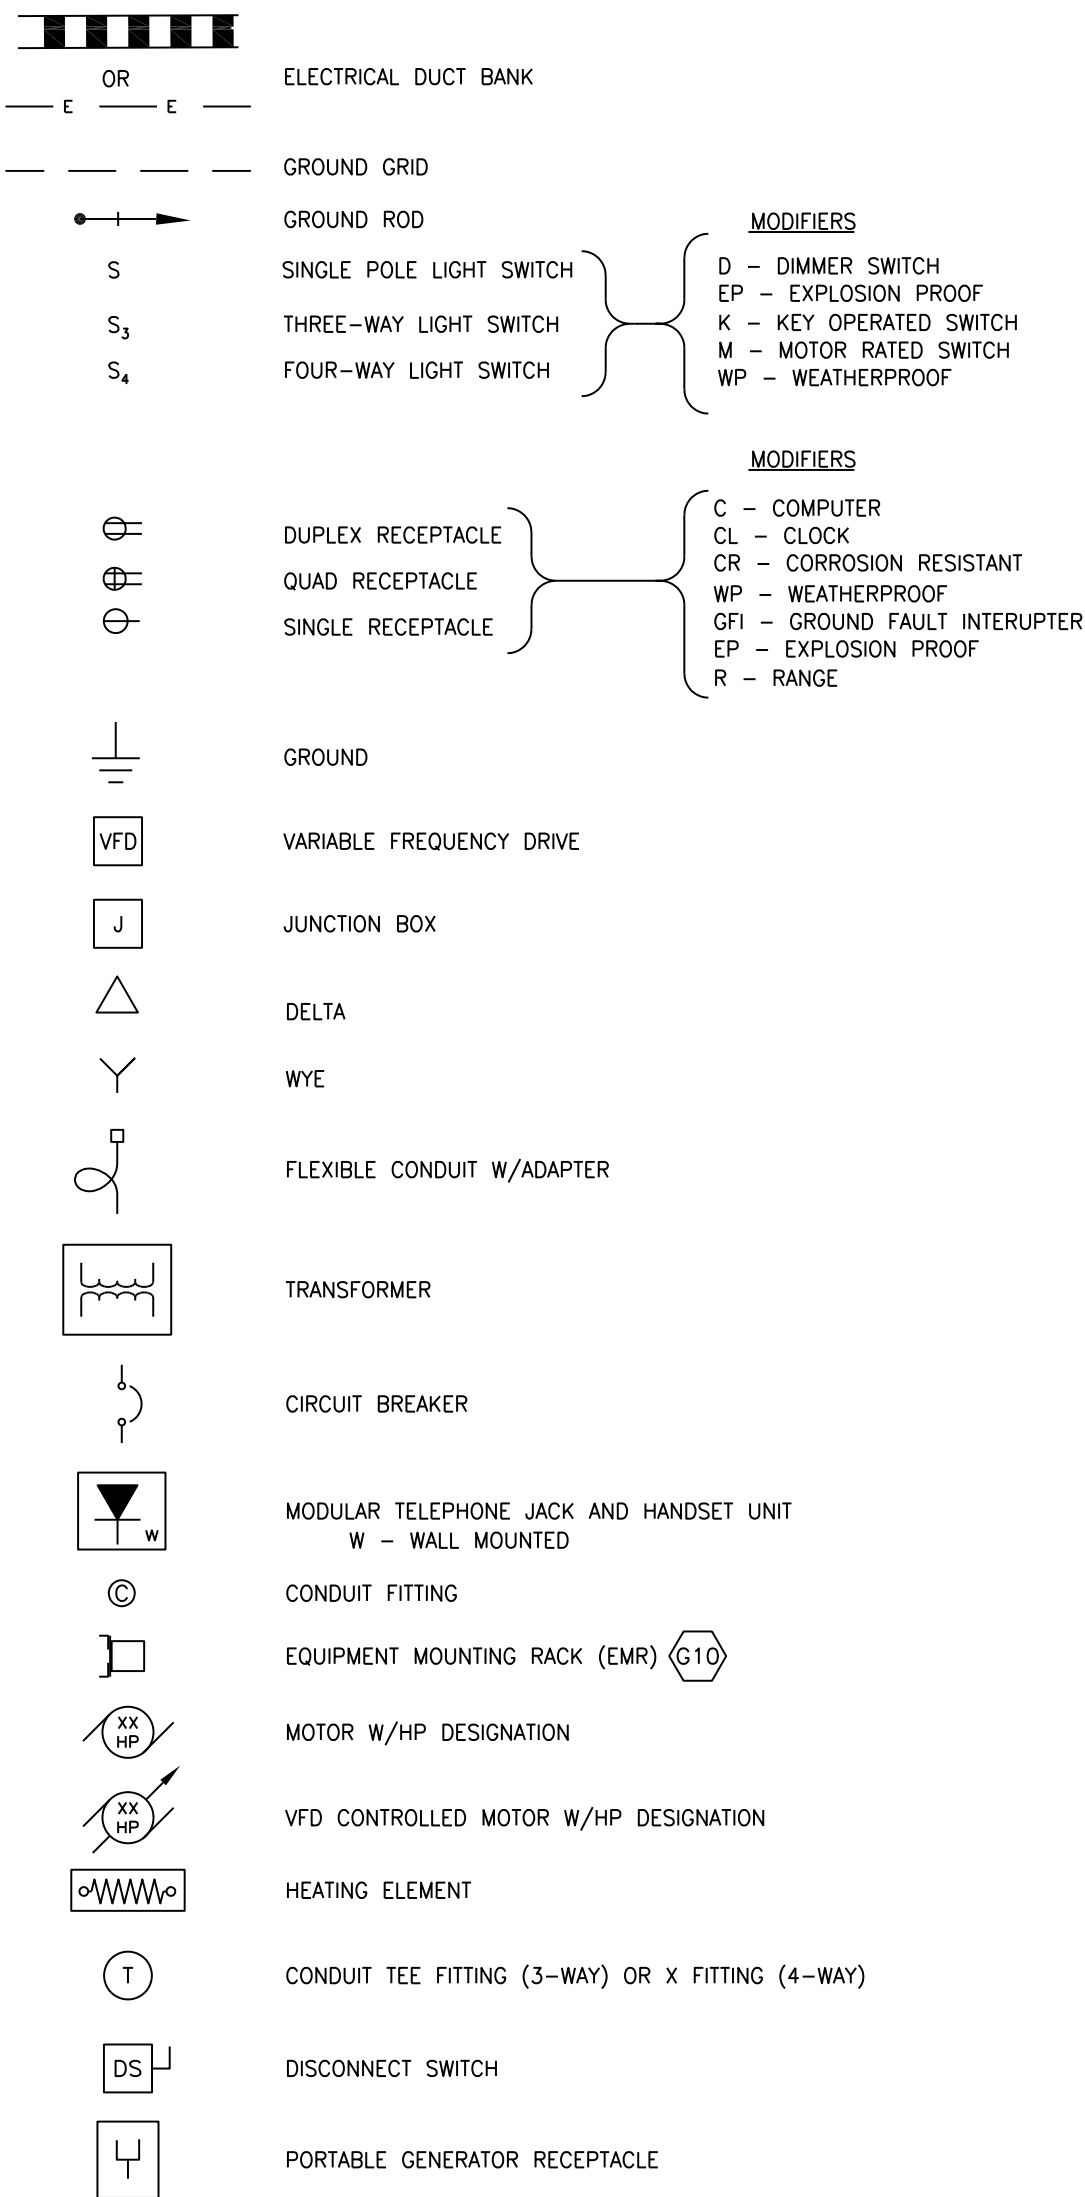

ELEMENTARY

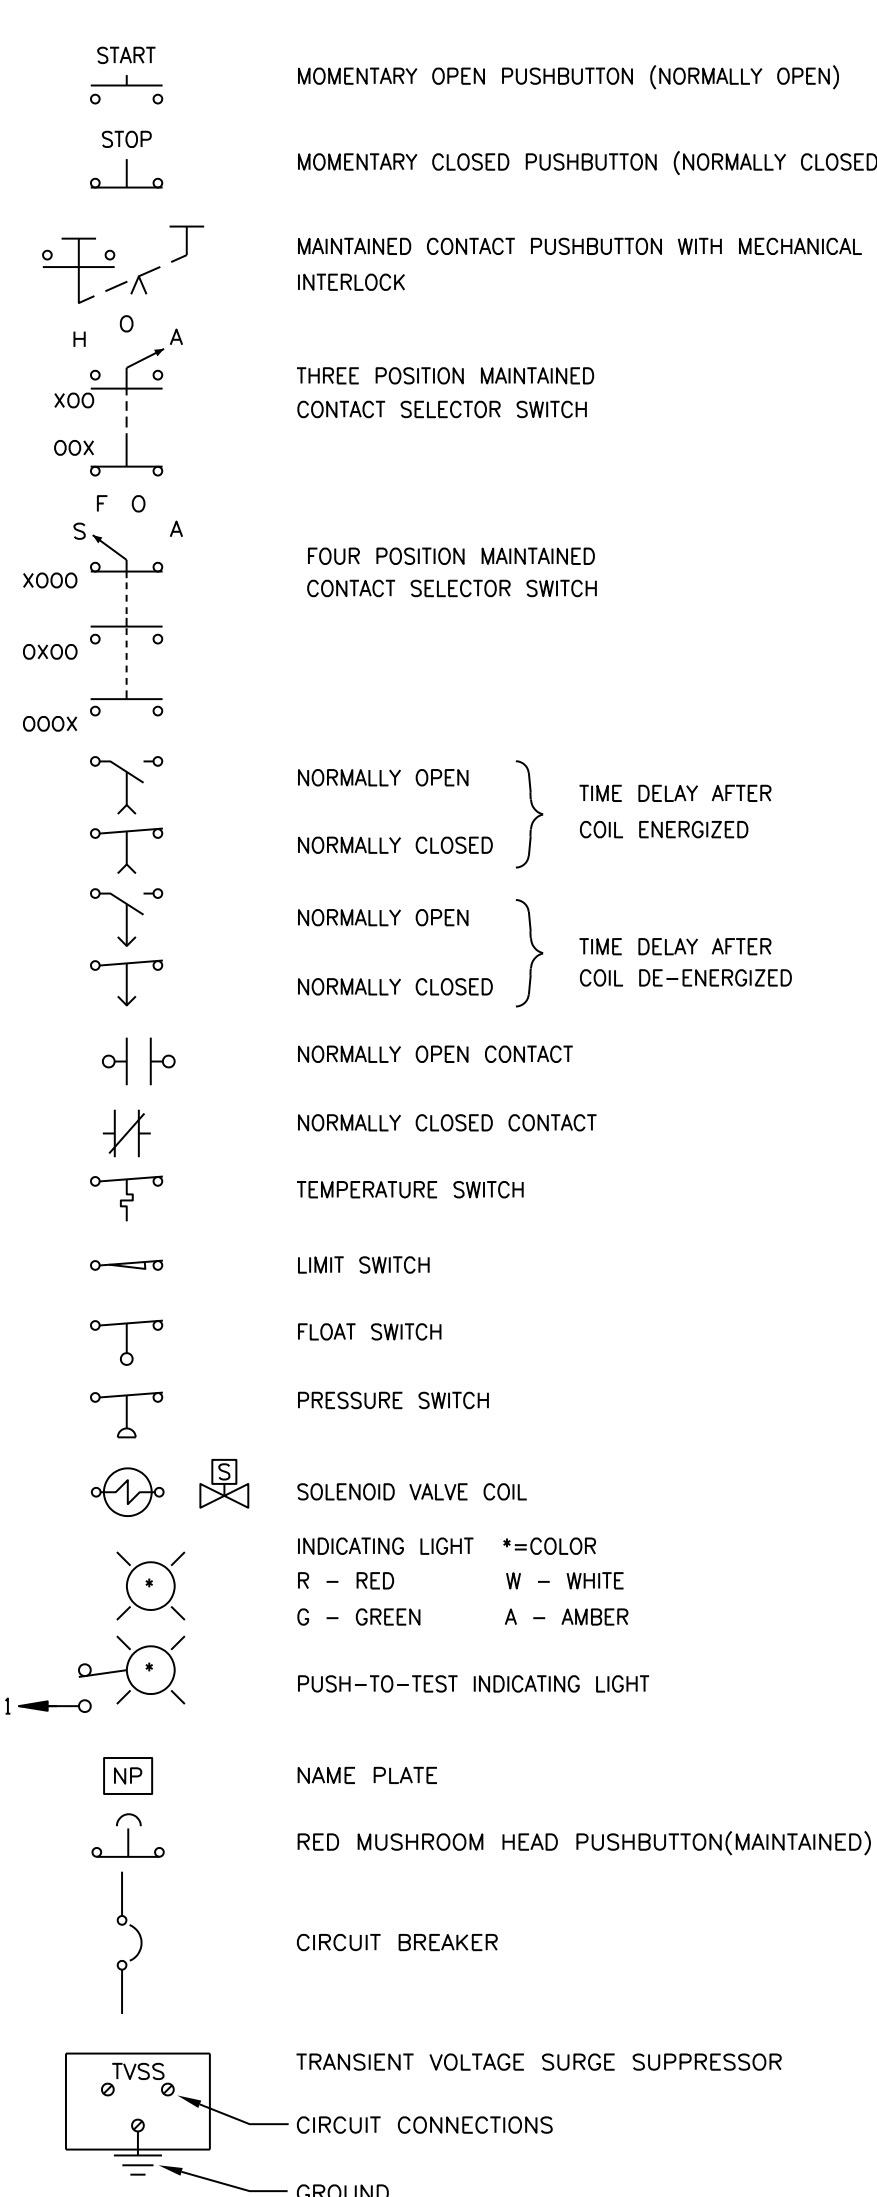


GENERAL NOTES:

- G1 CONTRACTOR SHALL COORDINATE FINAL CONCRETE EQUIPMENT PAD (CEP) DIMENSIONS WITH FINAL DIMENSIONS OF EQUIPMENT AND OTHER STRUCTURES TO BE MOUNTED ON PADS. REFER TO INTERIOR AND EXTERIOR EQUIPMENT PAD DETAILS FOR ADDITIONAL INFORMATION. CEPS SHALL BE SIZE TO ACCOMMODATE FUTURE EQUIPMENT/SECTIONS WHERE SPACE IS RESERVED AS SHOWN ON THE DRAWINGS.
- G2 ENCLOSURE DIMENSIONS SHOWN ON THE DRAWINGS ARE MINIMUM REQUIRED DIMENSIONS. ENCLOSURES SHALL BE SIZED TO ACCOMMODATE EQUIPMENT, CONTROLS AND COMPONENTS AS SHOWN, SPECIFIED AND REQUIRED FOR AN OPERABLE SYSTEM.
- G3 EQUIPMENT, FEEDERS, AND BRANCH CIRCUITS ON THE DOWNSTREAM SIDE OF THE PANELBOARDS ARE NOT SHOWN ON THE ONE-LINE AND SCHEMATIC DIAGRAMS. REFER TO THE PANELBOARD SCHEDULES AND THE PLANS FOR RELATED INFORMATION.
- G4 EVERY EFFORT HAS BEEN MADE TO IDENTIFY REMOTE ITEMS TO BE CONNECTED BY THE ELECTRICAL CONTRACTOR, EITHER IN THE ELEMENTARIES OR IN THE SCHEDULES. HOWEVER, NOT ALL OF THE REMOTE DEVICES MAY HAVE BEEN SHOWN ON THE ELECTRICAL PLAN DRAWINGS. REFER TO THE DRAWINGS OF RESPECTIVE TRADES TO LOCATE OR CONFIRM EQUIPMENT LOCATIONS.
- G5 GROUNDING: ELECTRICAL SYSTEMS SHALL BE GROUNDED AS SPECIFIED AND SHOWN ON THE CONTRACT DRAWINGS. WORK SHALL ALSO BE PERFORMED IN ACCORDANCE WITH ARTICLE 250 OF THE NATIONAL ELECTRIC CODE. GROUND GRID CONNECTIONS SHOWN ON THE INDIVIDUAL PLANS ARE MINIMUM REQUIREMENTS. ALL REQUIRED CONNECTIONS ARE NOT SHOWN ON PLANS FOR BREVITY.
- G6 CONTRACTOR SHALL PROVIDE POWER SUPPLY AND CONTROL WIRING TO HEATING AND VENTILATION COMPONENTS AS SHOWN ON THE CONTRACT DRAWINGS. HEATING/VENTILATION CONTROL EQUIPMENT SHALL BE PROVIDED BY MANUFACTURER AS INDICATED.
- G7 LIGHTING CIRCUITS ARE SHOWN DIAGRAMMATICALLY: EXACT LOCATION OF CONDUIT RUNS SHALL BE DETERMINED BY THE ELECTRICAL INSTALLER IN THE FIELD, UNLESS SPECIFICALLY DIMENSIONED ON THE PLANS. CONDUIT AND WIRE INFORMATION CAN BE FOUND ON THE PLANS, EQUIPMENT SCHEDULES AND SCHEMATICS.
- G8 EXACT EQUIPMENT CONDUIT CONNECTIONS ARE TO BE DETERMINED BY THE ELECTRICAL INSTALLER BASED UPON THE ACTUAL FIELD LOCATION OF EQUIPMENT. INSTALL CONDUIT IN ACCORDANCE WITH SPECIFICATIONS.
- G9 ALL PENETRATIONS THROUGH EXISTING SOLID CONCRETE STRUCTURES WHERE SLEEVES HAVE NOT BEEN PROVIDED SHALL BE CORE DRILLED AND SIZED TO ACCEPT MECHANICAL LINK SEALS. THROUGH NON-FIRE RATED WALLS, CORE HOLE AND SEAL AROUND CONDUIT WITH NON-SHRINK GROUT. THROUGH EXTERIOR WALL SEAL WATER TIGHT WITH SILICONE MASONRY SEALANT.
- G10 EQUIPMENT MOUNTING RACK (EMR): THE FINAL LOCATION OF THE EMR'S SHALL BE COORDINATED IN THE FIELD TO AVOID INTERFERENCE WITH ACCESS TO THE PROCESS EQUIPMENT. SEE DETAIL E-7.
- G11 EQUIPMENT REMOVALS: DISCONNECT AND REMOVE POWER/CONTROL CIRCUITS AND CONDUITS FROM THE RESPECTIVE EQUIPMENT.
- G12 EQUIPMENT RELOCATIONS: DISCONNECT AND REMOVE POWER/CONTROL CIRCUITS AND CONDUCTORS FROM THE EQUIPMENT. EQUIPMENT SHALL BE REMOVED AND RELOCATED TO THE NEW LOCATION SHOWN ON THE CONTRACT DRAWINGS.
- G13 CONDUIT REMOVALS: DISCONNECT AND REMOVE EXPOSED PORTIONS OF CONDUIT FOR EQUIPMENT TO BE REMOVED AND/OR RELOCATED. CUT, THREAD, COUPLE AND CAP EXISTING CONDUITS ADJACENT TO THE PENETRATION POINT WHERE THE CONDUITS ARE CONCEALED (IN WALLS, CONCRETE SLABS, BELOW GRADE). REPAIR WALL PENETRATIONS TO A WEATHER-TIGHT CONDITION MATCHING EXISTING WALL MATERIALS.
- G14 EQUIPMENT TO REMAIN: PROVIDE NEW FEEDER OR BRANCH CIRCUIT CONDUIT AND WIRING TO EXISTING/RELOCATED EQUIPMENT REQUIRED TO REMAIN IN SERVICE. CUT AND REUSE EXISTING CONDUIT RUNS WHERE PRACTICAL. CIRCUIT CONDUCTORS SHALL BE REPLACED THE ENTIRE LENGTH OF THE CIRCUIT RUN.

GROUNDING NOTES:

1. THE GROUNDING SYSTEM IS SHOWN DIAGRAMMATICALLY. EXACT LOCATION OF CABLE, GROUND RODS AND CONNECTIONS SHALL BE DETERMINED IN THE FIELD.
2. ALL BURIED GROUNDING CABLE CONNECTIONS SHALL BE CADWELDED OR THERMOWELDED. THE WELDED CONNECTIONS SHALL BE LEFT EXPOSED FOR INSPECTION BY ENGINEER PRIOR TO BACKFILLING.
3. WHERE EXPOSED TO MECHANICAL INJURY, THE GROUNDING CONDUCTOR SHALL BE SUITABLY PROTECTED BY PIPE OR OTHER MECHANICAL PROTECTION. EACH END OF PROTECTING CONDUIT (IF METALLIC) SHOULD BE GROUNDED TO THE BARE CABLE.
4. ALL EXPOSED CABLE LUGS AND CONNECTORS SHALL BE OF THE COMPRESSION TYPE UNLESS OTHERWISE NOTED.
5. STEEL MUST BE CLEANED THOROUGHLY AND CABLE MUST BE COMPLETELY DRY BEFORE MAKING WELD CONNECTIONS.
6. THE GROUNDING SYSTEM SHALL BE CONNECTED TO THE GROUNDING ELECTRODES.

INSTRUMENT & FUNCTION TAGGING

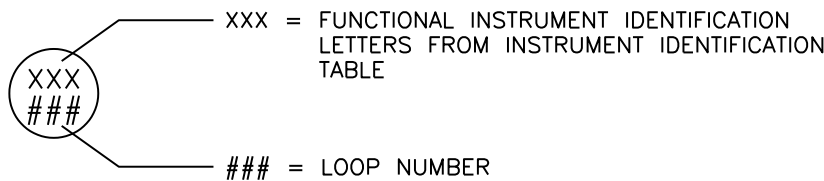


GENERAL CIRCUIT/CONDUIT TAG IDENTIFICATION		
TAG	CONDUIT SIZE	CONDUCTORS
⊙ P2	3/4"	2-#12, 1-#12G
⊙ P3	3/4"	3-#12, 1-#12G
⊙ P6	3/4"	6-#12, 1-#12G
⊙ Cx	3/4" (x=2 THRU 18) 1" (x=19 THRU 30) 2" (x=31 THRU 100)	x-#14, 1-#12G
⊙ TSP-x	3/4" (x=1,2) 1" (x=3,4) 2" (x=5 THRU 16)	x-#20 TWISTED SHIELDED PAIR
⊙ TST-x	3/4"	x-#20 TWISTED SHIELDED TRIAD
⊙ CAT5-x	3/4" (x=1 THRU 4) 1" (x=5 THRU 8)	x-CATEGORY 5 NETWORK CABLE (BELDEN 1583A OR EQUAL)

X-REF: 20200001.DWG
03/11 BOWEN
P:202080/30 (DRAWINGS/VELOC)

NOTES:

Underground facilities, structures, and utilities have been plotted from available surveys and records, and therefore their locations must be considered approximate only. There may be others, the existence of which is presently not known.

3	ISSUED FOR CONSTRUCTION																		
2	RE-SEALED					RRC	6/21/04												
1	FOR APPROVAL																		
	JHC	11/03	WPJ	TJR		RRC	1/23/04												
ISSUE NO.	DRAWN	DATE	CHECKED	DESIGNER	APPROVED	DATE													
PROJECT SUPERVISOR					DEPARTMENT SUPERVISOR														

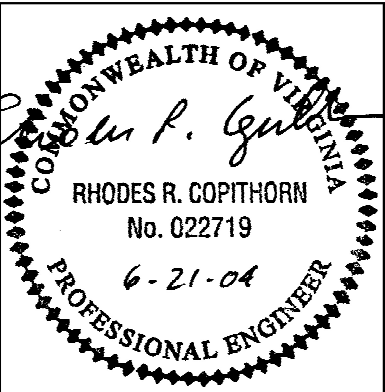

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Environmental Engineers and Scientists


310 FIRST STREET, S.W., SUITE 150
ROANOKE, VIRGINIA 24011
PHONE: (540) 982-1910 FAX: (540) 982-1913

BEDFORD COUNTY PUBLIC SERVICE AUTHORITY


HIGH POINT WTP EXPANSION – PROJECT NO. 2003 – 028

ELECTRICAL LEGEND
ABBREVIATIONS & SYMBOLS


JOB NO. 20280 DRAWING E-1 SHEET 31 OF 37

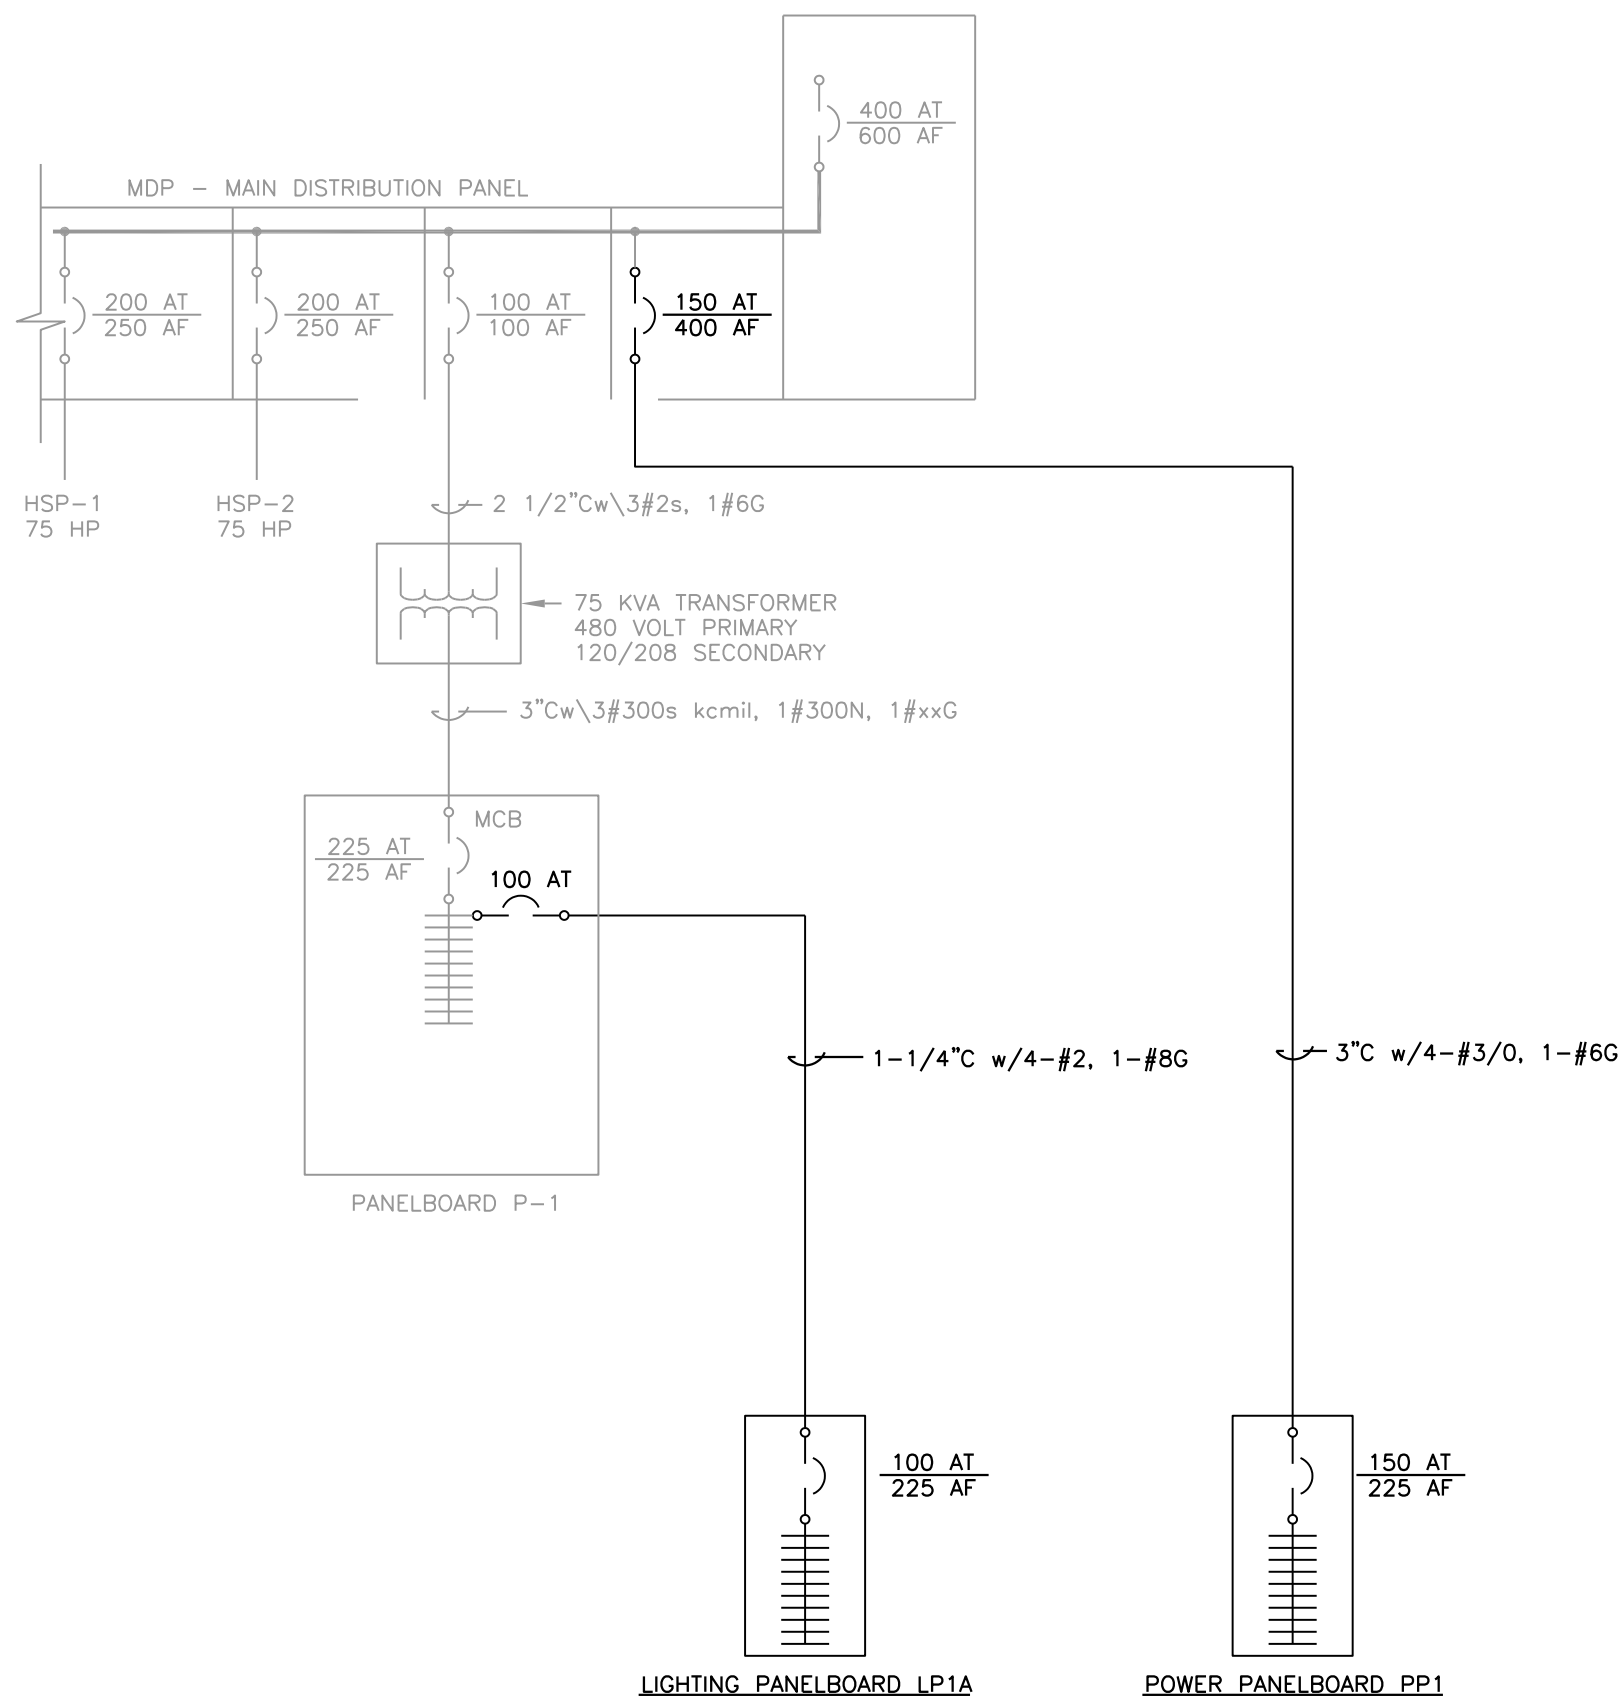


BEDFORD PLANT 1-LINE DIAGRAM
NOT TO SCALE

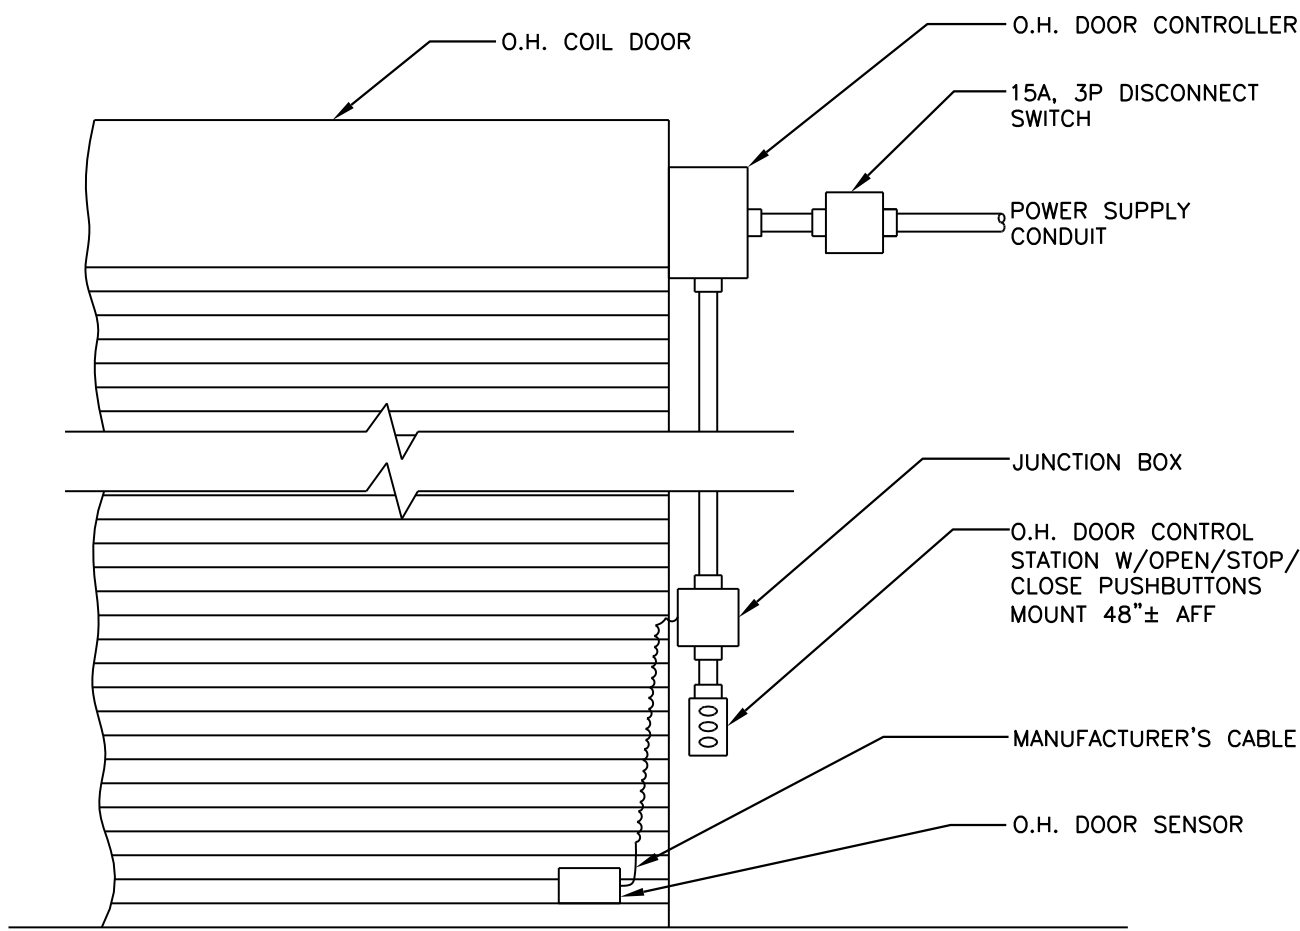

TYPICAL OVERHEAD DOOR ELEVATION
NOT TO SCALE

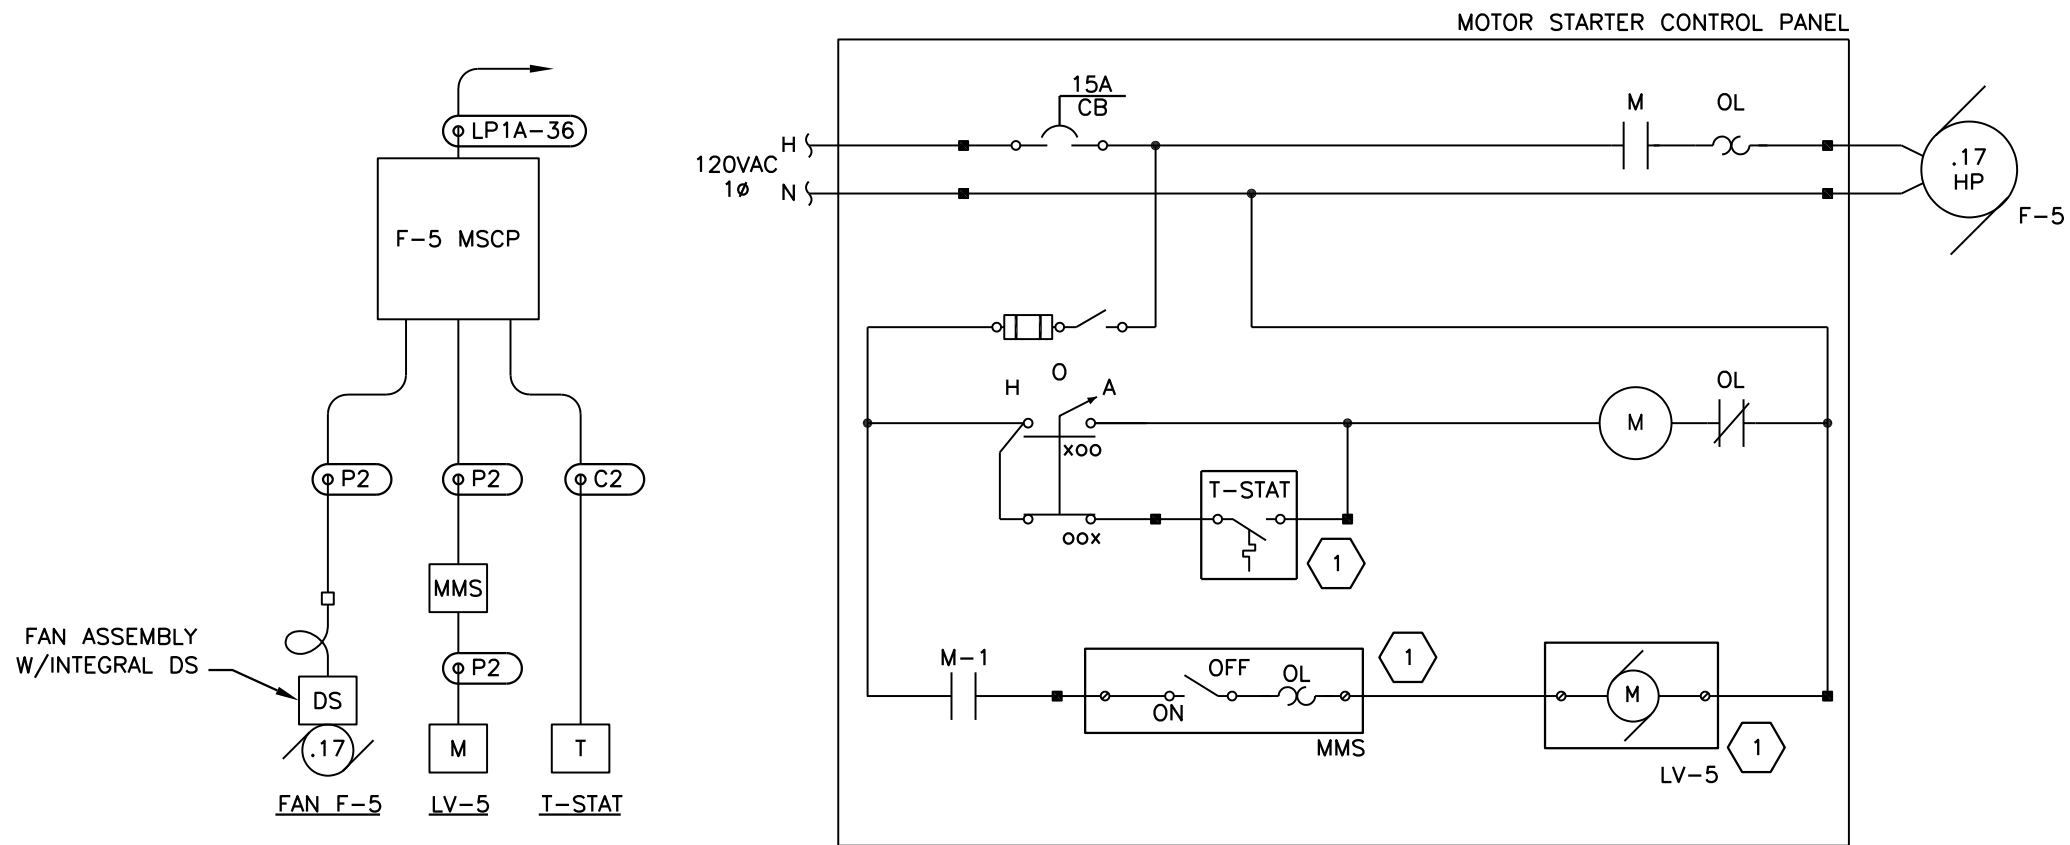


**FAN F-5 MOTOR STARTER CONTROL PANEL
ELEMENTARY AND CONDUIT RISER DIAGRAM**
NOT TO SCALE

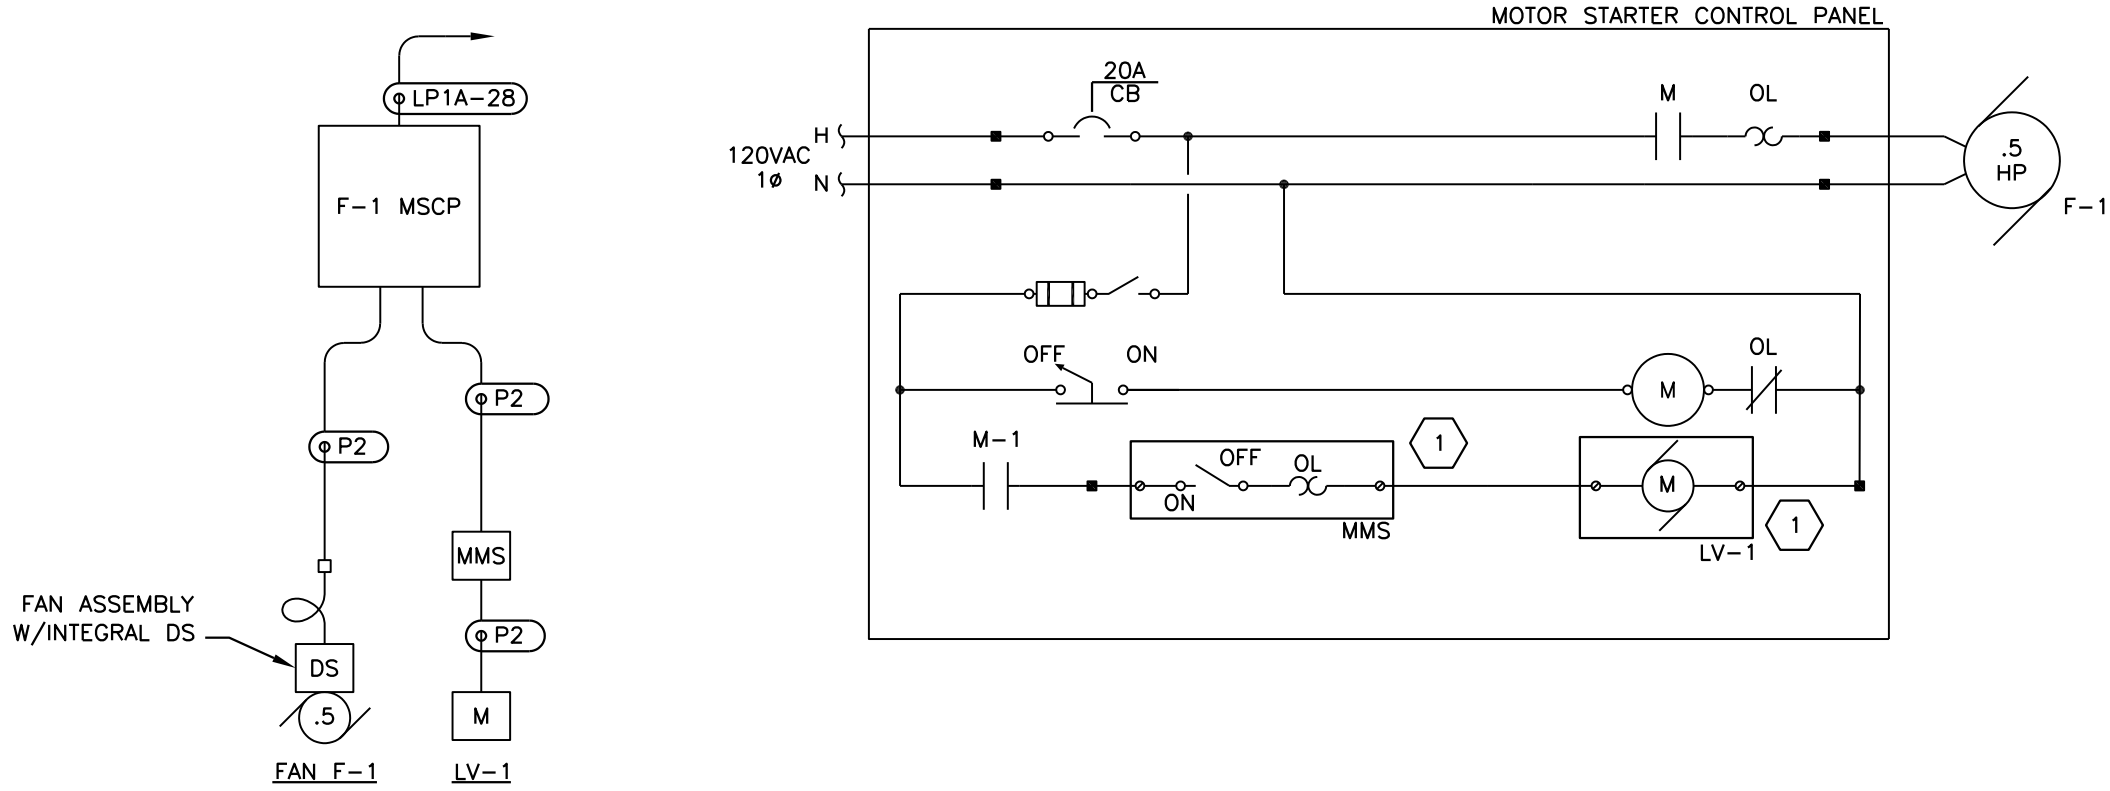


**FAN F-1 MOTOR STARTER CONTROL PANEL
ELEMENTARY & CONDUIT RISER DIAGRAM**
NOT TO SCALE

TYP. FOR: FAN F-2 W/LOUVER LV-2
FAN F-3 W/LOUVER LV-3
FAN F-4 W/LOUVER LV-4

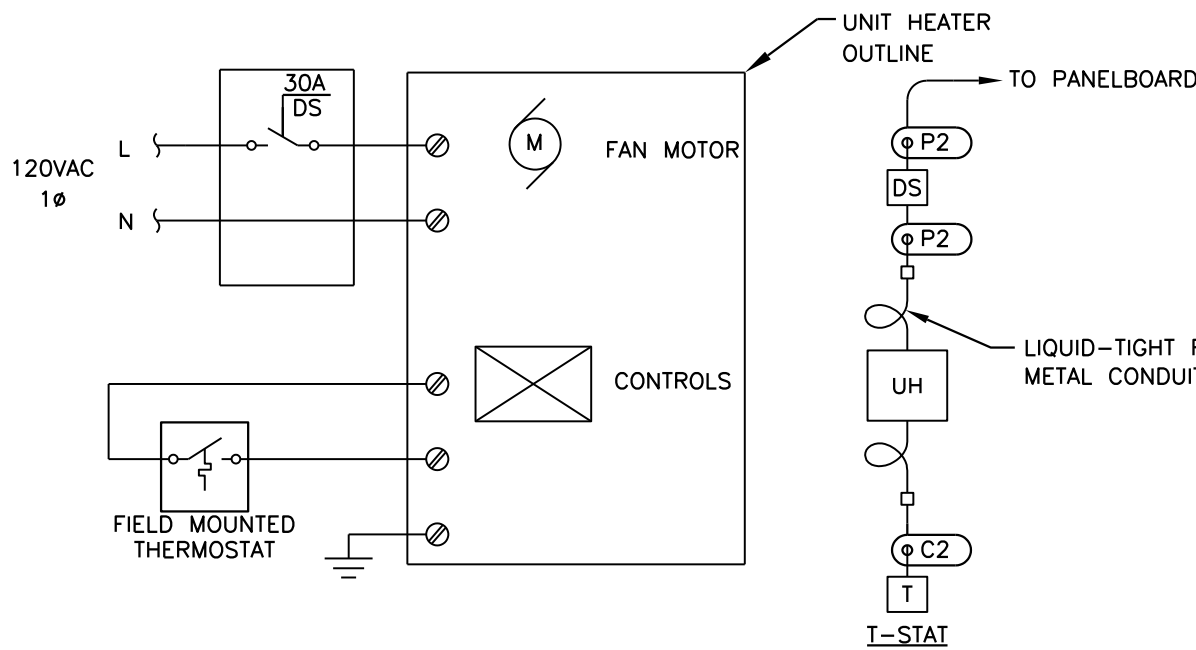


**UNIT HEATER (GUH) SCHEMATIC & CONDUIT
RISER DIAGRAM (EXTERNAL THERMOSTAT)**
NOT TO SCALE

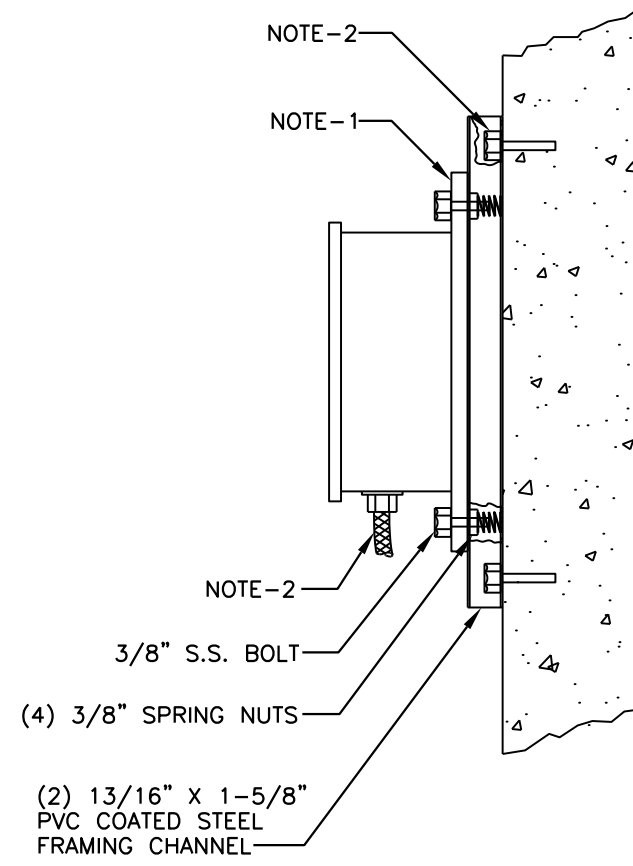

EQUIPMENT MOUNTING RACK (EMR) DETAIL
NOT TO SCALE

DETAIL NOTES:


- USE 1/4" ALUMINUM PLATE. DIMENSION TO SUIT EQUIPMENT BEING USED AND QUANTITY OF EQUIPMENT ON PLATE. USE (4) 3/8" S.S. ANCHOR BOLTS TO MOUNT FRAMING CHANNEL TO WALL.
- ALL CONDUIT FROM EQUIPMENT TO BE LIQUID TIGHT 3/4" FLEXIBLE TO J-BOX.

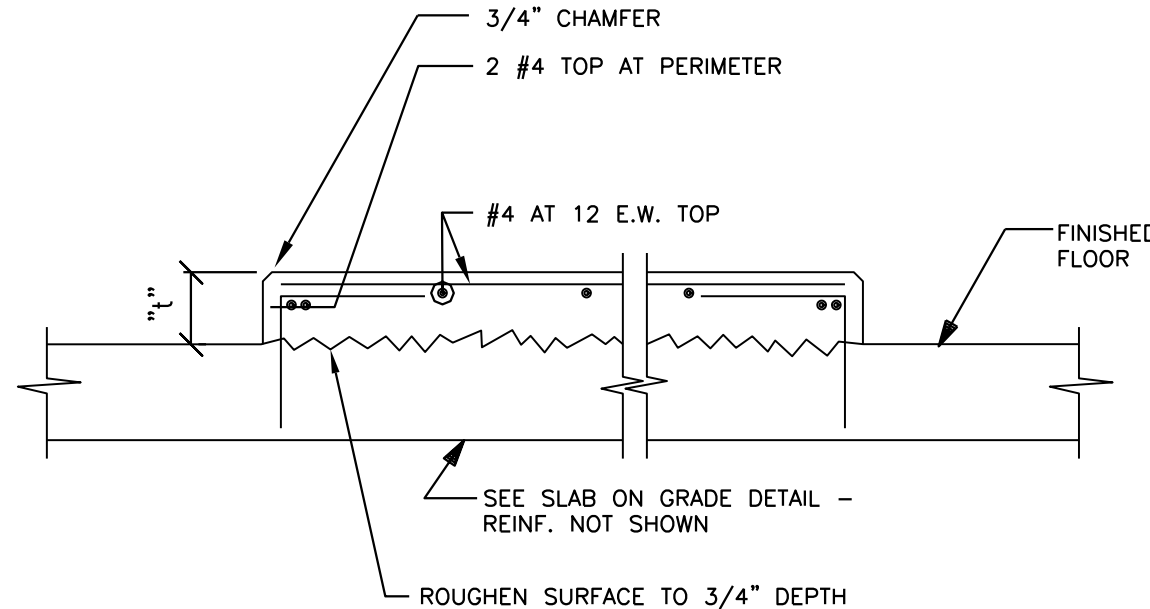

NOTES:

- COORD. EQUIP. PAD SIZE, THICKNESS (t) & ANCHOR BOLT LOCATIONS W/ ELEC. DWGS. AND EQUIPMENT

TYPICAL INDOOR EQUIPMENT PAD DETAIL
NOT TO SCALE

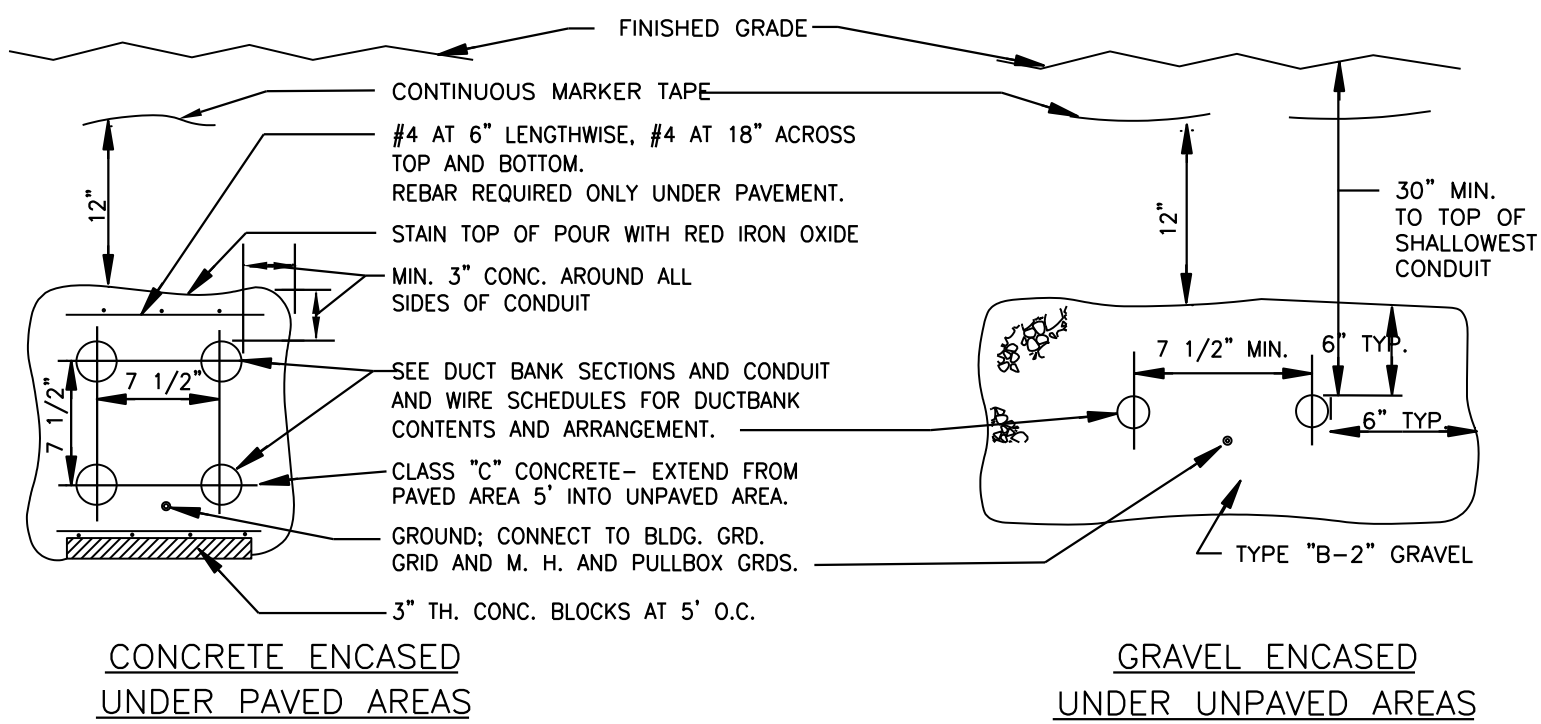

DUCT BANK DETAILS
NO TO SCALE

DRAWING NOTES:


- EQUIPMENT AND CONTROLS LOCATED IN THE FIELD.

X-REF: 20200201.DWG
8/03, ROANOKE, BSR
P:\2020\20\DRAWINGS\VELEC\

NOTES:

Underground facilities, structures, and utilities have been plotted from available surveys and records, and therefore their locations must be considered approximate only. There may be others, the existence of which is presently not known.

3	ISSUED FOR CONSTRUCTION												
2	RE-SEALED				RRC	6/21/04							
1	FOR APPROVAL				RRC	1/23/04							
	BSR	11/03	WPJ	CMT									
ISSUE NO.	DRAWN	DATE	CHECKED	DESIGNER	APPROVED	DATE							
PROJECT SUPERVISOR			DEPARTMENT SUPERVISOR										
-----							ISSUE NO.	DRAWN	DATE	CHECKED	DESIGNER	APPROVED	DATE

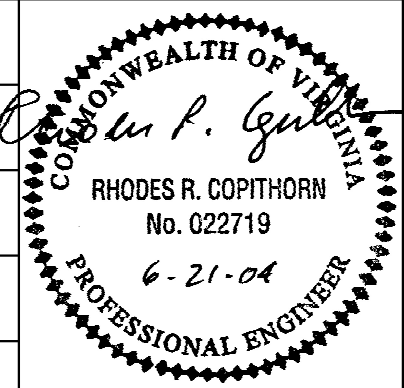

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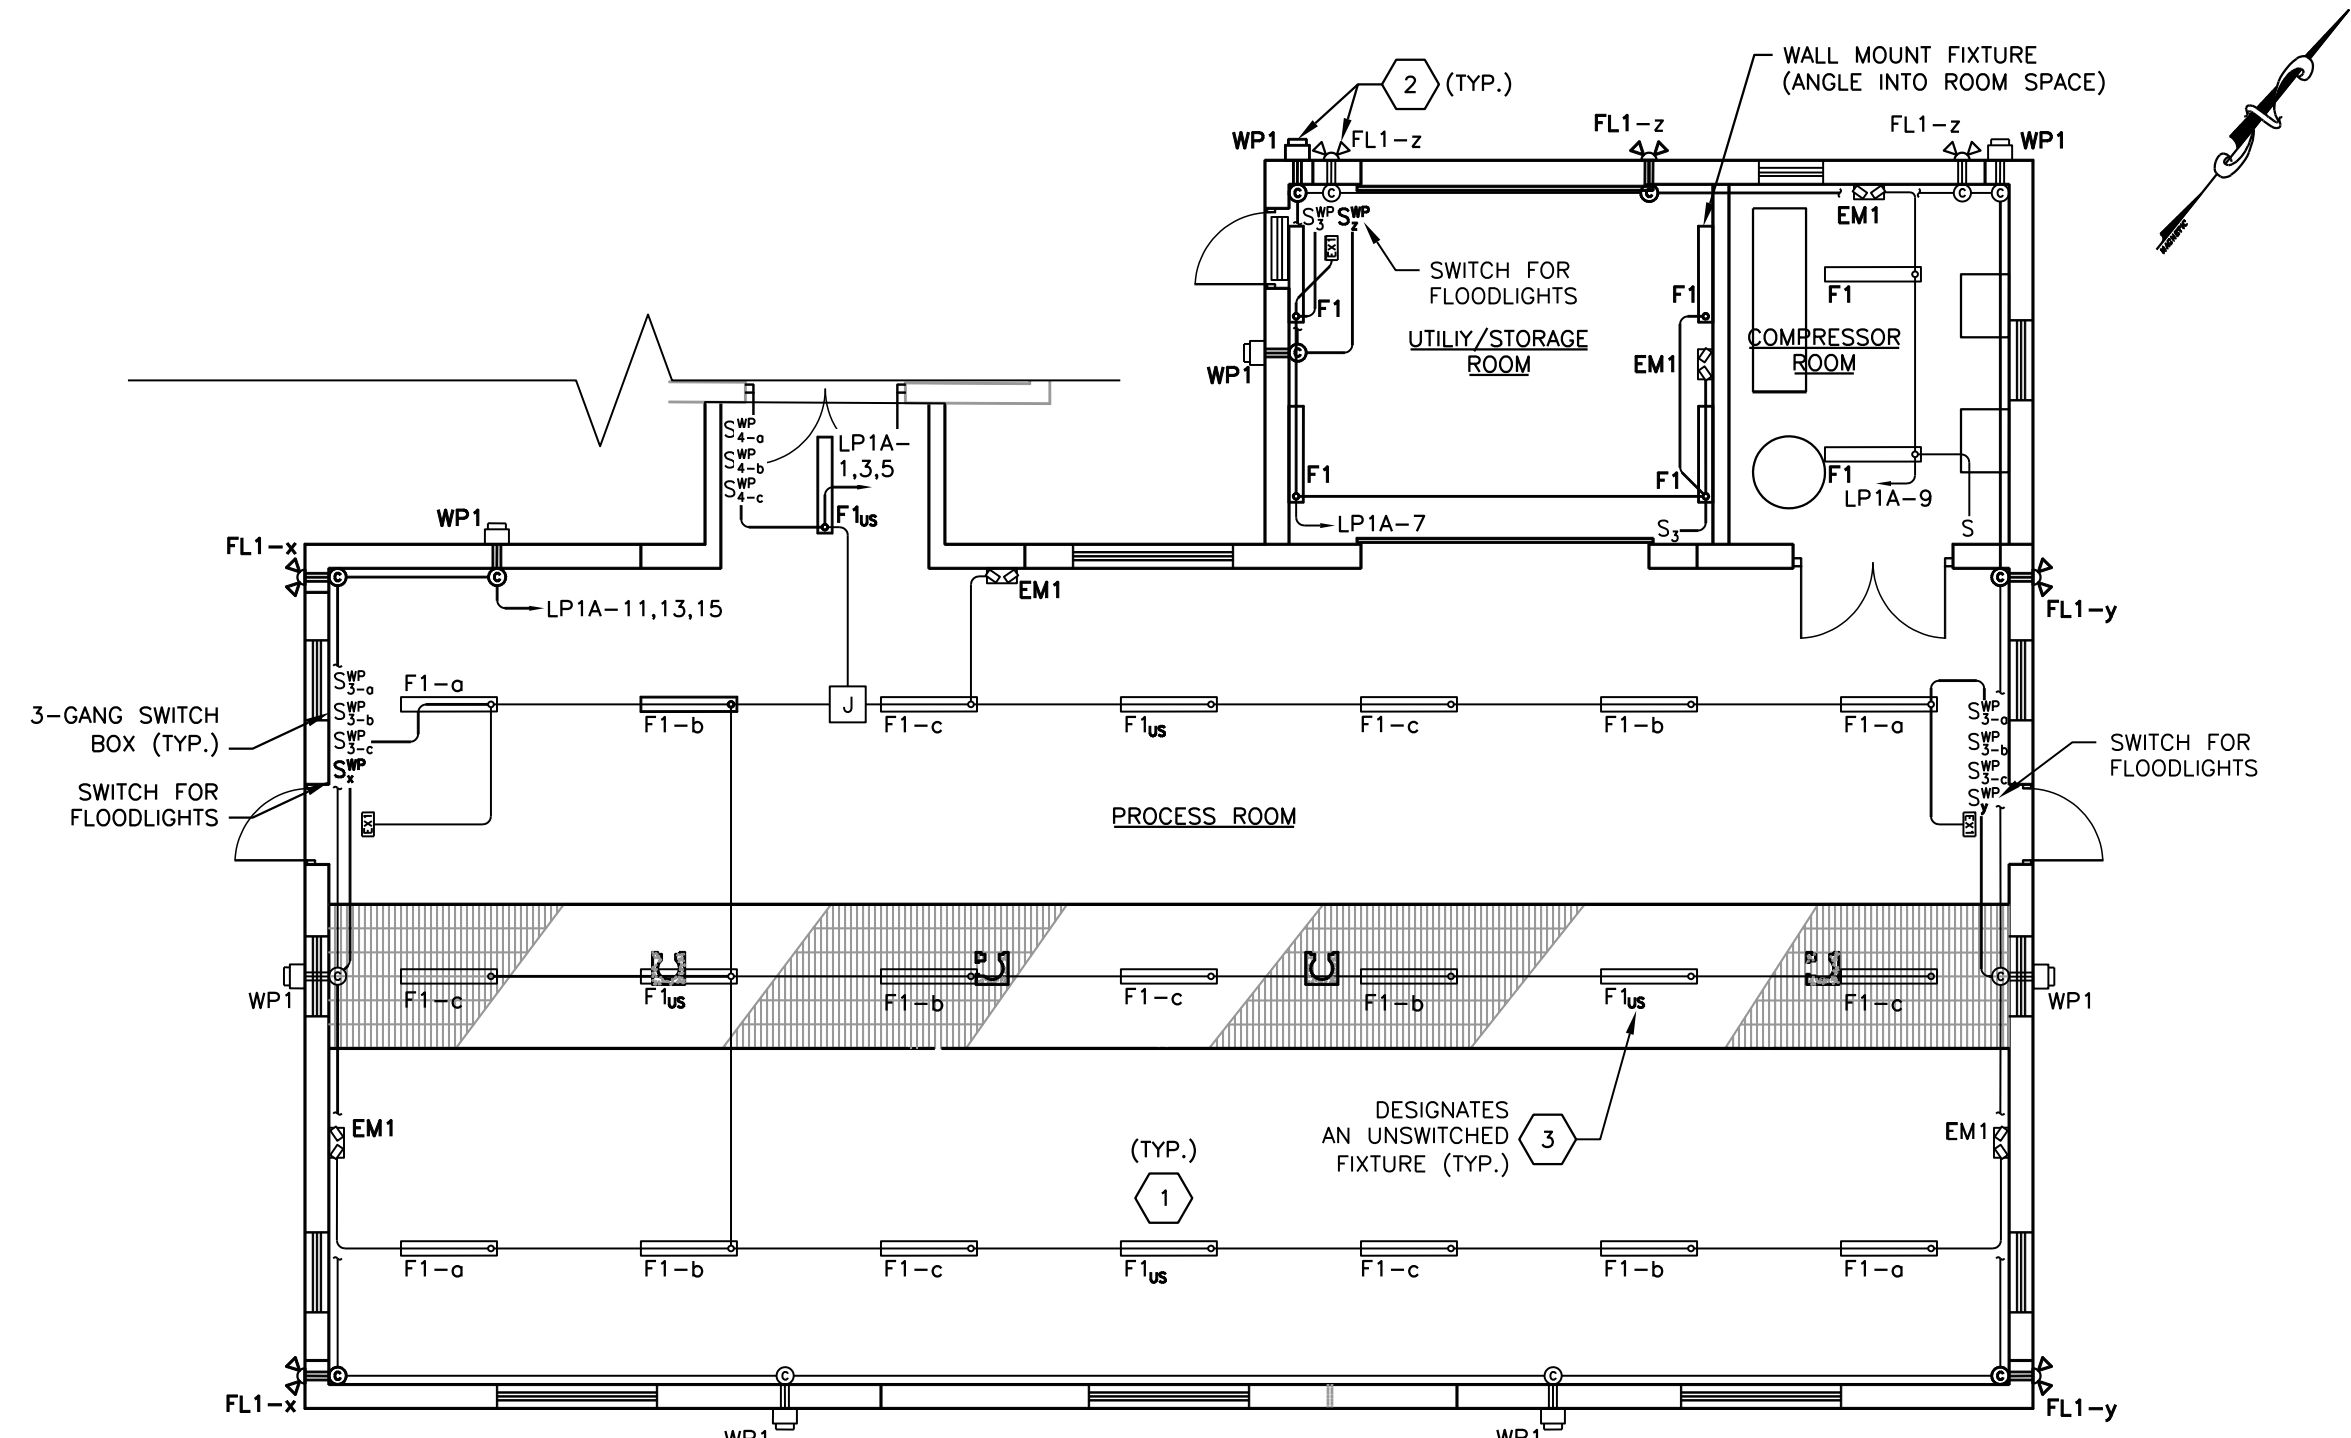
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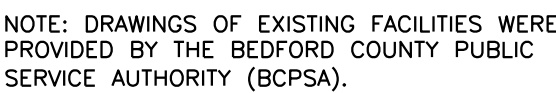
ONE-LINE DIAGRAMS &
ELECTRICAL DETAILS

JOB NO. 20280 DRAWING E-3 SHEET 33 OF 37




SCALE: 1/8"=1'-0"

- 1 INTERIOR LIGHTING FIXTURES: COORDINATE FINAL LOCATIONS OF LIGHTING FIXTURES WITH HVAC EQUIPMENT SUCH THAT THE FIXTURES DO NOT INTERFERE WITH THE EQUIPMENT.
- 2 EXTERIOR LIGHTING FIXTURES: LOCATIONS SHOWN HERE ARE FOR WIRING PURPOSES ONLY. COORDINATE FINAL LOCATIONS OF LIGHTING FIXTURES WITH ARCHITECTURAL ELEVATIONS. LOCATIONS ON THIS ELECTRICAL PLAN SHALL TAKE PRECEDENCE OVER LOCATIONS SHOWN THE ELECTRICAL PLANS.
- 3 UNSWITCHED FIXTURES: WIRE UNSWITCHED SWITCHED TO SAME POWER CIRCUIT AS THE F1-a FIXTURES. THESE FIXTURES SHALL REMAIN ON CONTINUOUSLY.



NOTES:

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[illegible]
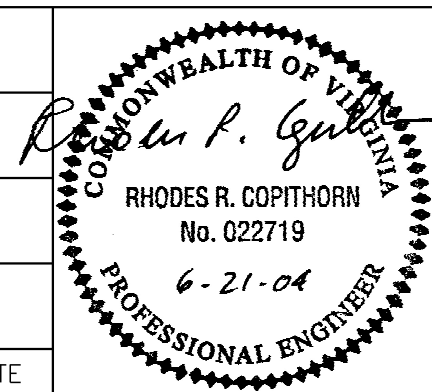
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Environmental Engineers and Scientists


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HIGH POINT WTP EXPANSION – PROJECT NO. 2003 – 028

POWER, CONTROL & LIGHTING PLANS

JOB NO.	20280	DRAWING	E-4	SHEET	34 OF 37
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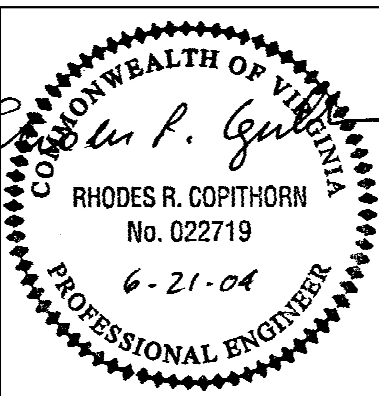


X-REF: 2028001.DWG
03/12, BOWEN, JHC
P: (20280) 30 (DRAWINGS/VELEC)

NOTES:

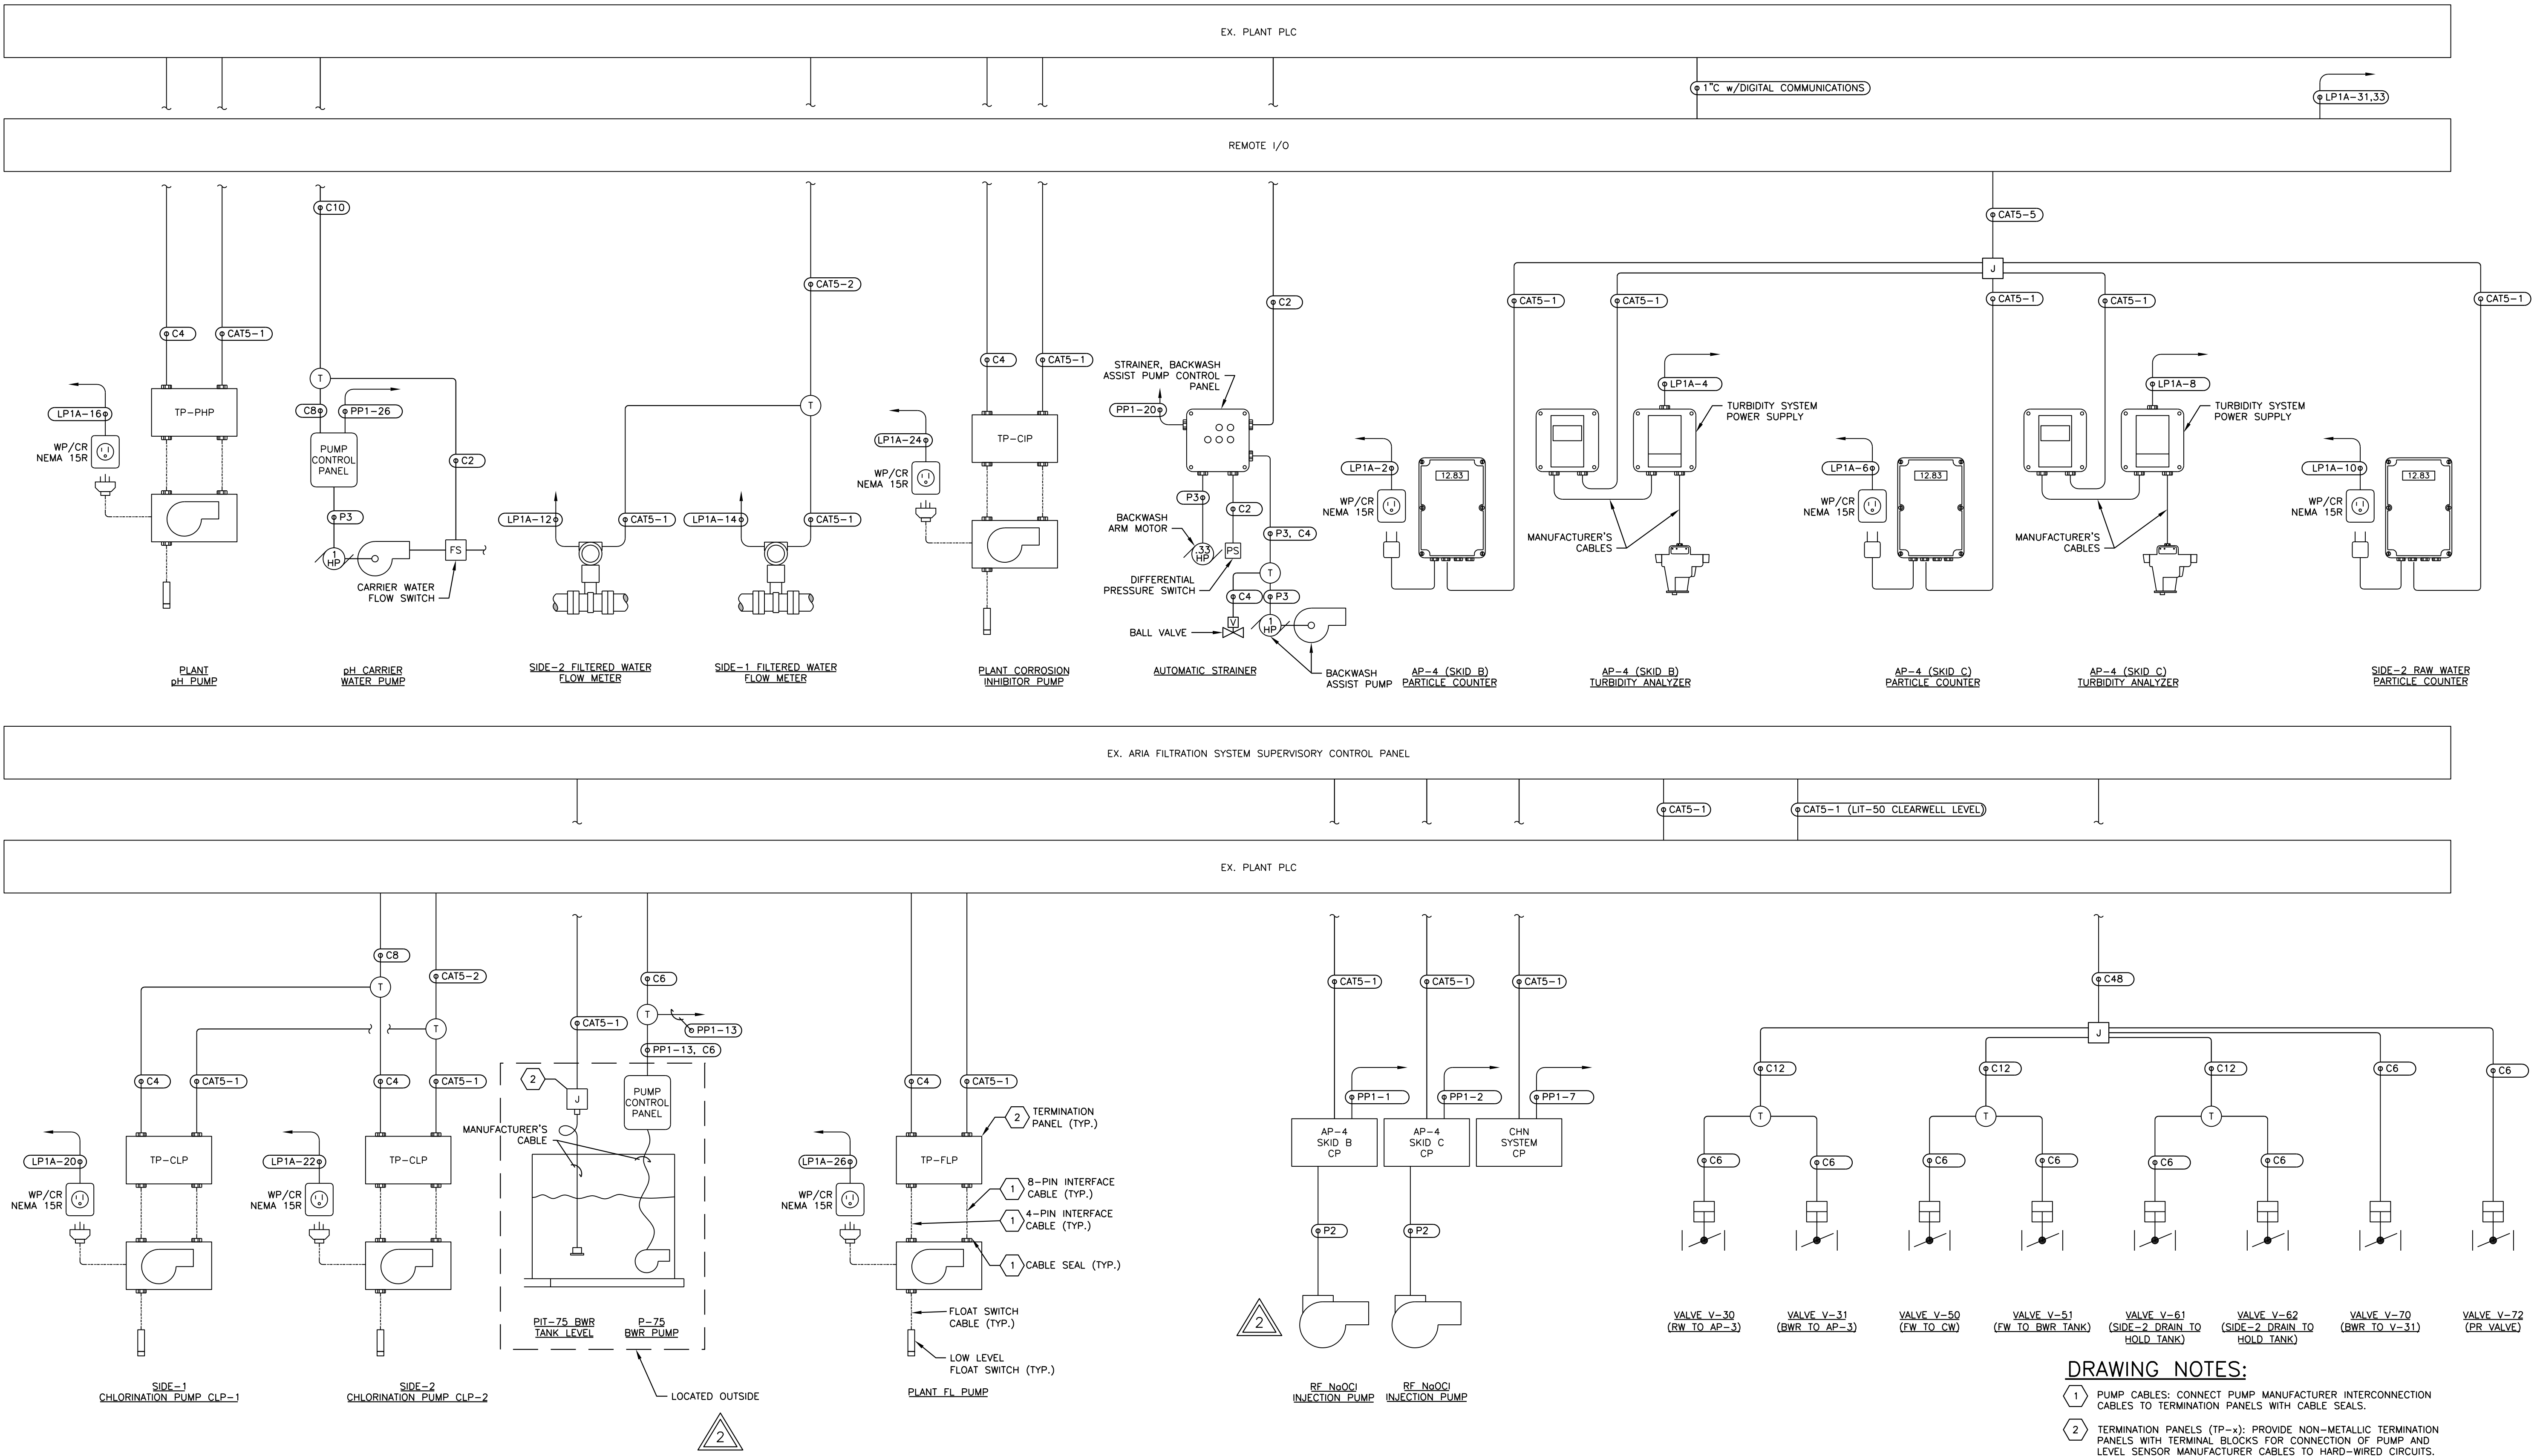Underground facilities, structures, and utilities have been plotted from available surveys and records, and therefore their locations must be considered approximate only. There may be others, the existence of which is presently not known.

3	ISSUED FOR CONSTRUCTION																		
2	REVISED PER OWNER & VDH COMMENTS				RRC	6/21/04													
	JHC	6/04	WPJ	TJR															
1	FOR APPROVAL				RRC	1/23/04													
	JHC	11/03	WPJ	TJR															
ISSUE NO.	DRAWN	DATE	CHECKED	DESIGNER	APPROVED	DATE													
PROJECT SUPERVISOR					DEPARTMENT SUPERVISOR														
-----													ISSUE NO.	DRAWN	DATE	CHECKED	DESIGNER	APPROVED	DATE



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HIGH POINT WTP EXPANSION – PROJECT NO. 2003 – 028

CONDUIT RISER DIAGRAM

JOB NO. 20280 DRAWING E-5 SHEET 35 OF 37

POWER PANELBOARD PP1

LOCATION:

PROCESS ROOM 100M

MAIN BUS RATING:

225A, 480/277V, 3PH, 4W

MINIMUM SHORT-CIRCUIT INTERRUPTION RATING:

35,000 AIC

MAIN BREAKER TRIP:

150A I225AF

FED FROM:

MAIN DISTRIBUTION PANEL

ESTIMATED CONNECTED LOAD:

40kVA

INCOMING FEED:

3" CW 4#30, 1-#6

ENCLOSURE:

NEMA 4X STAINLESS STEEL

TVSS/SURGE PROTECTION:

INTEGRAL

NOTES: SEE PANELBOARD SCHEDULE NOTES

DESCRIPTION	NOTES	LOAD	CONDUIT / CONDUCTOR SIZE	CB TRIP/POLE	CIRCUIT	A	B	C	CIRCUIT	CB TRIP/POLE	CONDUIT / CONDUCTOR SIZE	LOAD	NOTES	DESCRIPTION		
AP-4 SKID BOX CP			3/4" CW/3-#8, 1-#10	40A/SP	1		●		2	40A/SP	3/4" CW/3-#8, 1-#10			AP-4 SKID BOX CP		
					3			●	4							
					5				●						6	
					7	●									●	8
CHH SYSTEM CP			3/4" CW/3-#10, 1-#10	25A/SP	9			●	10	25A/SP	3/4" CW/3-#12, 1-#12	10Hp		AIR COMPRESSOR NO.1		
					11				●						12	
					13	●									14	
					15		●								16	
P-75 PUMP CONTROL PANEL			3/4" CW/3-#10, 1-#10	25A/SP	17				●	25A/SP	3/4" CW/3-#12, 1-#12	10Hp		AIR COMPRESSOR NO.2		
					19	●									20	
					21		●								22	
					23			●							24	
ROLL UP DOOR NO.1		3Hp	3/4" CW/3-#12, 1-#12	15A/SP	25				●	15A/SP	3/4" CW/3-#12, 1-#12	1.5Hp		STRAINER BACKWASH ASSIST PUMP CONTROL PANEL		
					27	●									28	
					29				●						30	
					31		●								32	
ROLL UP DOOR NO.2		3Hp	3/4" CW/3-#12, 1-#12	15A/SP	33				●	15A/SP	3/4" CW/3-#12, 1-#12	1Hp		pH CARRIER WATER PUMP		
					35				●						36	
					37	●									38	
					39				●						40	
SPACE					41				●	20A/SP				TVSS		
SPACE									●							
SPACE									●							
SPACE									●							

LIGHTING PANELBOARD LP1A														
LOCATION: PROCESS ROOM 100			FED FROM: EX. PANELBOARD P1											
MAIN BUS RATING: 100A, 208/120V, 3PH, 4W			ESTIMATED CONNECTED LOAD: 12kW											
MINIMUM SHORT-CIRCUIT INTERRUPTION RATING: 10,000 AIC			INCOMING FEED: 1-1/4" C w/4-#2, 1-#6											
MAIN BREAKER TRIP: 100A I225AF			ENCLOSURE: NEMA 4X STAINLESS STEEL											
TVSS/SURGE PROTECTION: N/A														
NOTES: SEE PANELBOARD SCHEDULE NOTES														
DESCRIPTION	NOTES	LOAD	CONDUIT / CONDUCTOR SIZE	CB TRIP/POLE	CIRCUIT	A	B	C	CIRCUIT	CB TRIP/POLE	CONDUIT / CONDUCTOR SIZE	LOAD	NOTES	DESCRIPTION
LIGHTING - PROCESS RM CIR #1	4	66kW	3/4" C w/2-#12, 10#12G	15A/NP	1	●			2	20A/NP	3/4" C w/2-#12, 10#12G	18kVA		RECEPT. - PART. COUNTER
LIGHTING - PROCESS RM CIR #2	4	66kW	3/4" C w/2-#12, 10#12G	15A/NP	3		●		4	20A/NP	3/4" C w/2-#12, 10#12G	50W		TURBIDITY ANALYZER
LIGHTING - PROCESS RM CIR #3	4	66kW	3/4" C w/2-#12, 10#12G	15A/NP	5			●	6	20A/NP	3/4" C w/2-#12, 10#12G	18kVA		RECEPT. - PART. COUNTER
LIGHTING - UTILITY ROOM	4	34kW	3/4" C w/2-#12, 10#12G	15A/NP	7	●			8	20A/NP	3/4" C w/2-#12, 10#12G	50W		TURBIDITY ANALYZER
LIGHTING - COMPRESSOR ROOM	4	17kW	3/4" C w/2-#12, 10#12G	15A/NP	9		●		10	20A/NP	3/4" C w/2-#12, 10#12G	18kVA		RECEPT. - PART. COUNTER
LIGHTING - EXTERIOR WALL PAKS	4	1.4kW	3/4" C w/2-#12, 10#12G	15A/NP	11			●	12	20A/NP	3/4" C w/2-#12, 10#12G	50W		SIDE-2 FLOWMETER
LIGHTING - FLOODLIGHTS CIR #1	4	6kW	3/4" C w/2-#12, 10#12G	15A/NP	13	●			14	20A/NP	3/4" C w/2-#12, 10#12G	50W		SIDE-1 FLOWMETER
LIGHTING - FLOODLIGHTS CIR #2	4	6kW	3/4" C w/2-#12, 10#12G	20A/NP	15		●		16	20A/NP	3/4" C w/2-#12, 10#12G	50W		PLANT pH PUMP
LIGHTING - FLOODLIGHTS CIR #3	4	9kW	3/4" C w/2-#12, 10#12G	20A/NP	17			●	18	20A/NP	3/4" C w/2-#12, 10#12G	50W		SPARE
RECEPT. - PROCESS ROOM		36kVA	3/4" C w/2-#12, 10#12G	20A/NP	19	●			20	20A/NP	3/4" C w/2-#12, 10#12G	18kVA		RECEPT. - CLP-1
RECEPT. - UTILITY ROOM		36kVA	3/4" C w/2-#12, 10#12G	20A/NP	21		●		22	20A/NP	3/4" C w/2-#12, 10#12G	18kVA		RECEPT. - CLP-2
RECEPT. - COMPRESSOR ROOM		18kVA	3/4" C w/2-#12, 10#12G	20A/NP	23			●	24	20A/NP	3/4" C w/2-#12, 10#12G	18kVA		RECEPT. - CORROSION PUMP
GLH - S 8.2		06Hp	3/4" C w/2-#12, 10#12G	20A/NP	25	●			26	20A/NP	3/4" C w/2-#12, 10#12G	18kVA		RECEPT. - FL. PUMP
GLH - S 8.4		06Hp	3/4" C w/2-#12, 10#12G	20A/NP	27		●		28	20A/NP	3/4" C w/2-#12, 10#12G	5Hp		FAN F-1 MSCP
GLH - S 8.6		09Hp	3/4" C w/2-#12, 10#12G	20A/NP	29			●	30	20A/NP	3/4" C w/2-#12, 10#12G	5Hp		FAN F-2 MSCP
REMOTE I/O CABINET - CIR #1			3/4" C w/2-#12, 10#12G	20A/NP	31	●			32	20A/NP	3/4" C w/2-#12, 10#12G	5Hp		FAN F-3 MSCP
REMOTE I/O CABINET - CIR #2			3/4" C w/2-#12, 10#12G	20A/NP	33		●		34	20A/NP	3/4" C w/2-#12, 10#12G	04Hp		FAN F-4 MSCP
SPARE				20A/NP	35			●	36	20A/NP	3/4" C w/2-#12, 10#12G	17Hp		FAN F-5 MSCP
SPARE				20A/NP	37	●			38	20A/NP				SPARE
SPARE				20A/NP	39			●	40	20A/NP				SPARE
SPARE				20A/NP	41			●	42	20A/NP				SPARE

PANELBOARD SCHEDULE NOTES

1. PROVIDE GFCI RATED CIRCUIT BREAKER.
2. PROVIDE HACR RATED CIRCUIT BREAKER.
3. PROVIDE CIRCUIT BREAKER CAPABLE OF BEING LOCKED IN THE "OFF" POSITION (HANDLE LOCK-OFF/PADLOCK ATTACHMENT FEATURE).
4. LIGHTING CIRCUITS MAY REQUIRE ADDITIONAL CONDUCTORS FOR SWITCHED LEGS.


A-REF: 2028001.DWG
03/11/2009
P: (20280) (3) (DRAWINGS/EE/C)

NOTES:

Underground facilities, structures, and utilities have been plotted from available surveys and records, and therefore their locations must be considered approximate only. There may be others, the existence of which is presently not known.

3	ISSUED FOR CONSTRUCTION																
2	RE-SEALED				RRC	6/21/04											
1	FOR APPROVAL				RRC	1/23/04											
	JHC	11/03	WPJ	TJR													
ISSUE NO.	DRAWN	DATE	CHECKED	DESIGNER	APPROVED	DATE											
PROJECT SUPERVISOR					DEPARTMENT SUPERVISOR												

							ISSUE NO.	DRAWN	DATE	CHECKED	DESIGNER	APPROVED	DATE				

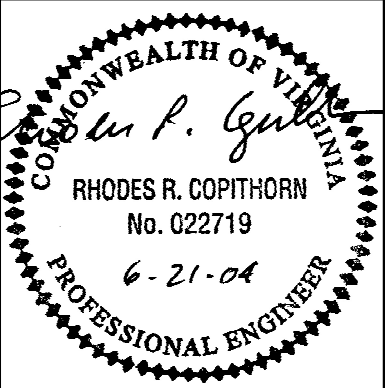

Stearns & Wheler, LLC
Environmental Engineers and Scientists

310 FIRST STREET, S.W., SUITE 150
ROANOKE, VIRGINIA 24011
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BEDFORD COUNTY PUBLIC SERVICE AUTHORITY


HIGH POINT WTP EXPANSION – PROJECT NO. 2003 – 028

ELECTRICAL SCHEDULES

JOB NO. 20280 DRAWING E-6 SHEET 36 OF 37


2

LEGEND

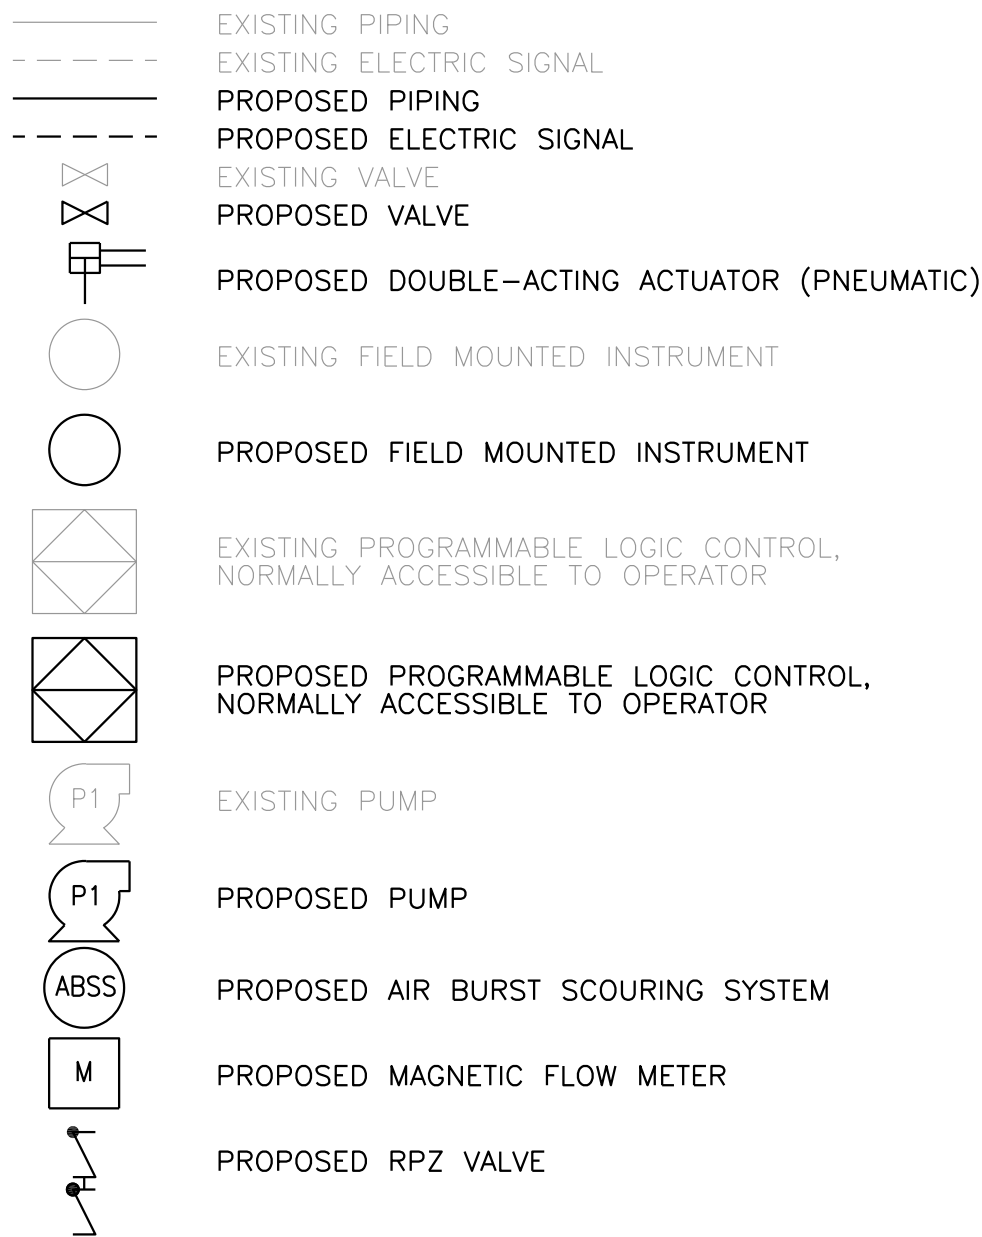

INSTRUMENTATION ABBREVIATIONS

AAH ANALYSIS ALARM HIGH
AAHL ANALYSIS ALARM HIGH/LOW (COMBINATION)
AI ANALYSIS INDICATE
AIT ANALYSIS INDICATING TRANSMITTER
AR ANALYSIS RECORD
BWR BACKWASH RECOVERY
CIP CLEAN-IN-PLACE
CL CHLORINE
FE FLOW ELEMENT
FI FLOW RATE INDICATE
FOI FLOW QUANTITY INDICATE
FR FLOW RATE RECORD
FT FLOW RATE TRANSMITTER
FW FILTERED WATER
KOI RUNNING TIME INDICATE
LAHL LEVEL ALARM HIGH/LOW (COMBINATION)
LSHL LEVEL SWITCH HIGH/LOW (COMBINATION)
LT LEVEL TRANSMITTER
NOP NORMAL OPERATIONS
PART PARTICLE
PDAH PRESSURE DIFFERENTIAL ALARM HIGH
PDI PRESSURE DIFFERENTIAL INDICATE
PDR PRESSURE DIFFERENTIAL RECORD
PI PRESSURE INDICATE
PIT PRESSURE INDICATING TRANSMITTER
PW POTABLE WATER
QOI INDICATING COUNTER
RW RAW WATER
STR STRAINER
TURB TURBIDITY
V VALVE
ZSC POSITION SWITCH CLOSED
ZSO POSITION SWITCH OPEN
ZVN POSITION VALVE OPEN
ZVX POSITION VALVE CLOSED

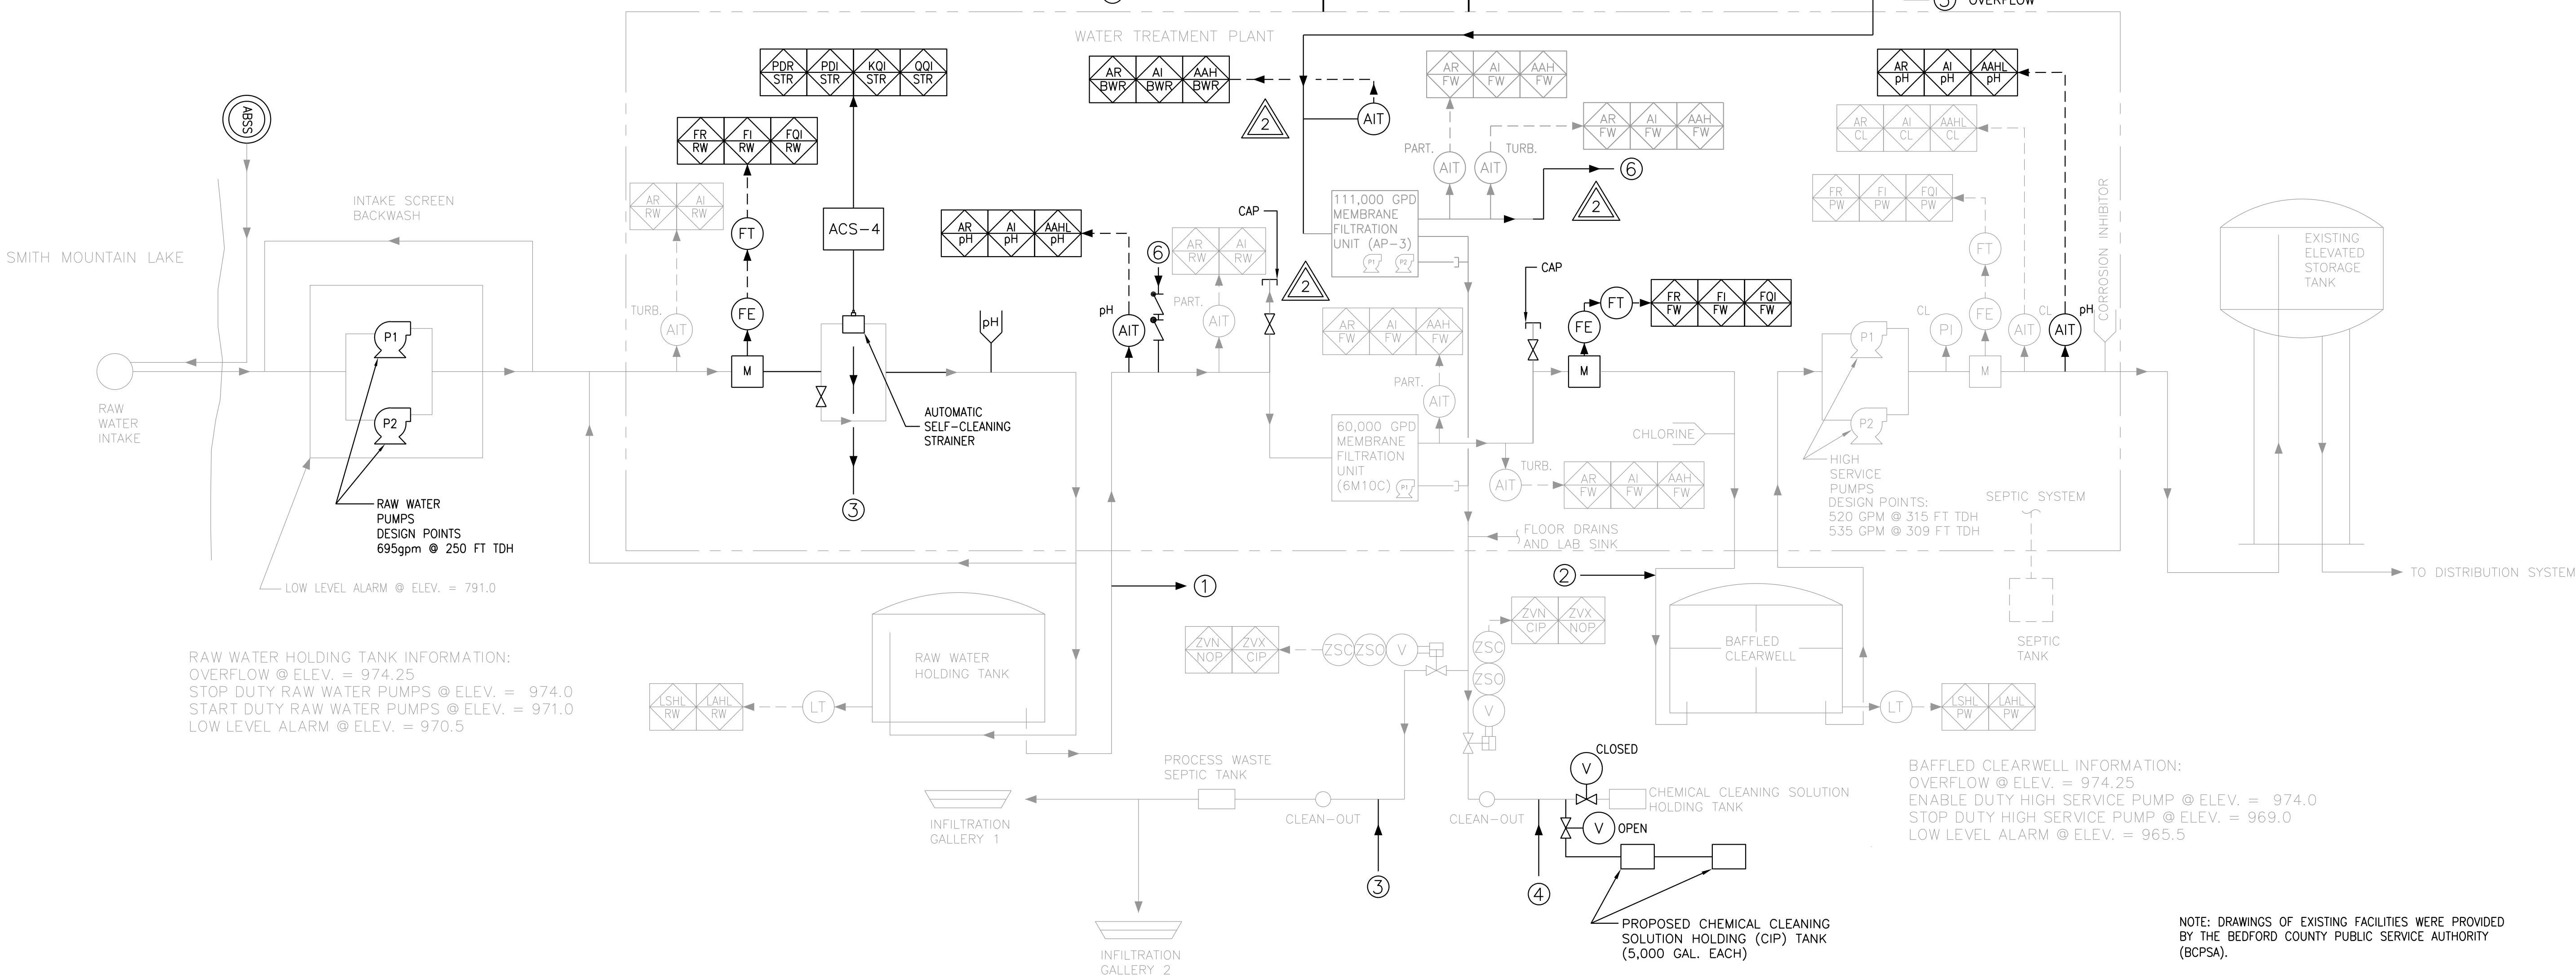

1-REF: 20280a1
8/03, 8/04, 8/05, 8/158, 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